




PARCEL ZONING:
SOLAR FACILITY:
TAX PARCEL NO.:
PARCEL SIZE:

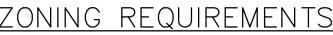

PARCEL SIZE	REQUIRED	PROPOSED
PARCEL SIZE	> 5 ACRES	254.99 ACRES
FRONT YARD SETBACK	30 FEET	> 30 FEET
SIDE YARD SETBACK	15 FEET	> 15 FEET
REAR YARD SETBACK	25 FEET	> 25 FEET
LOT COVERAGE (MAX)	40%	37%

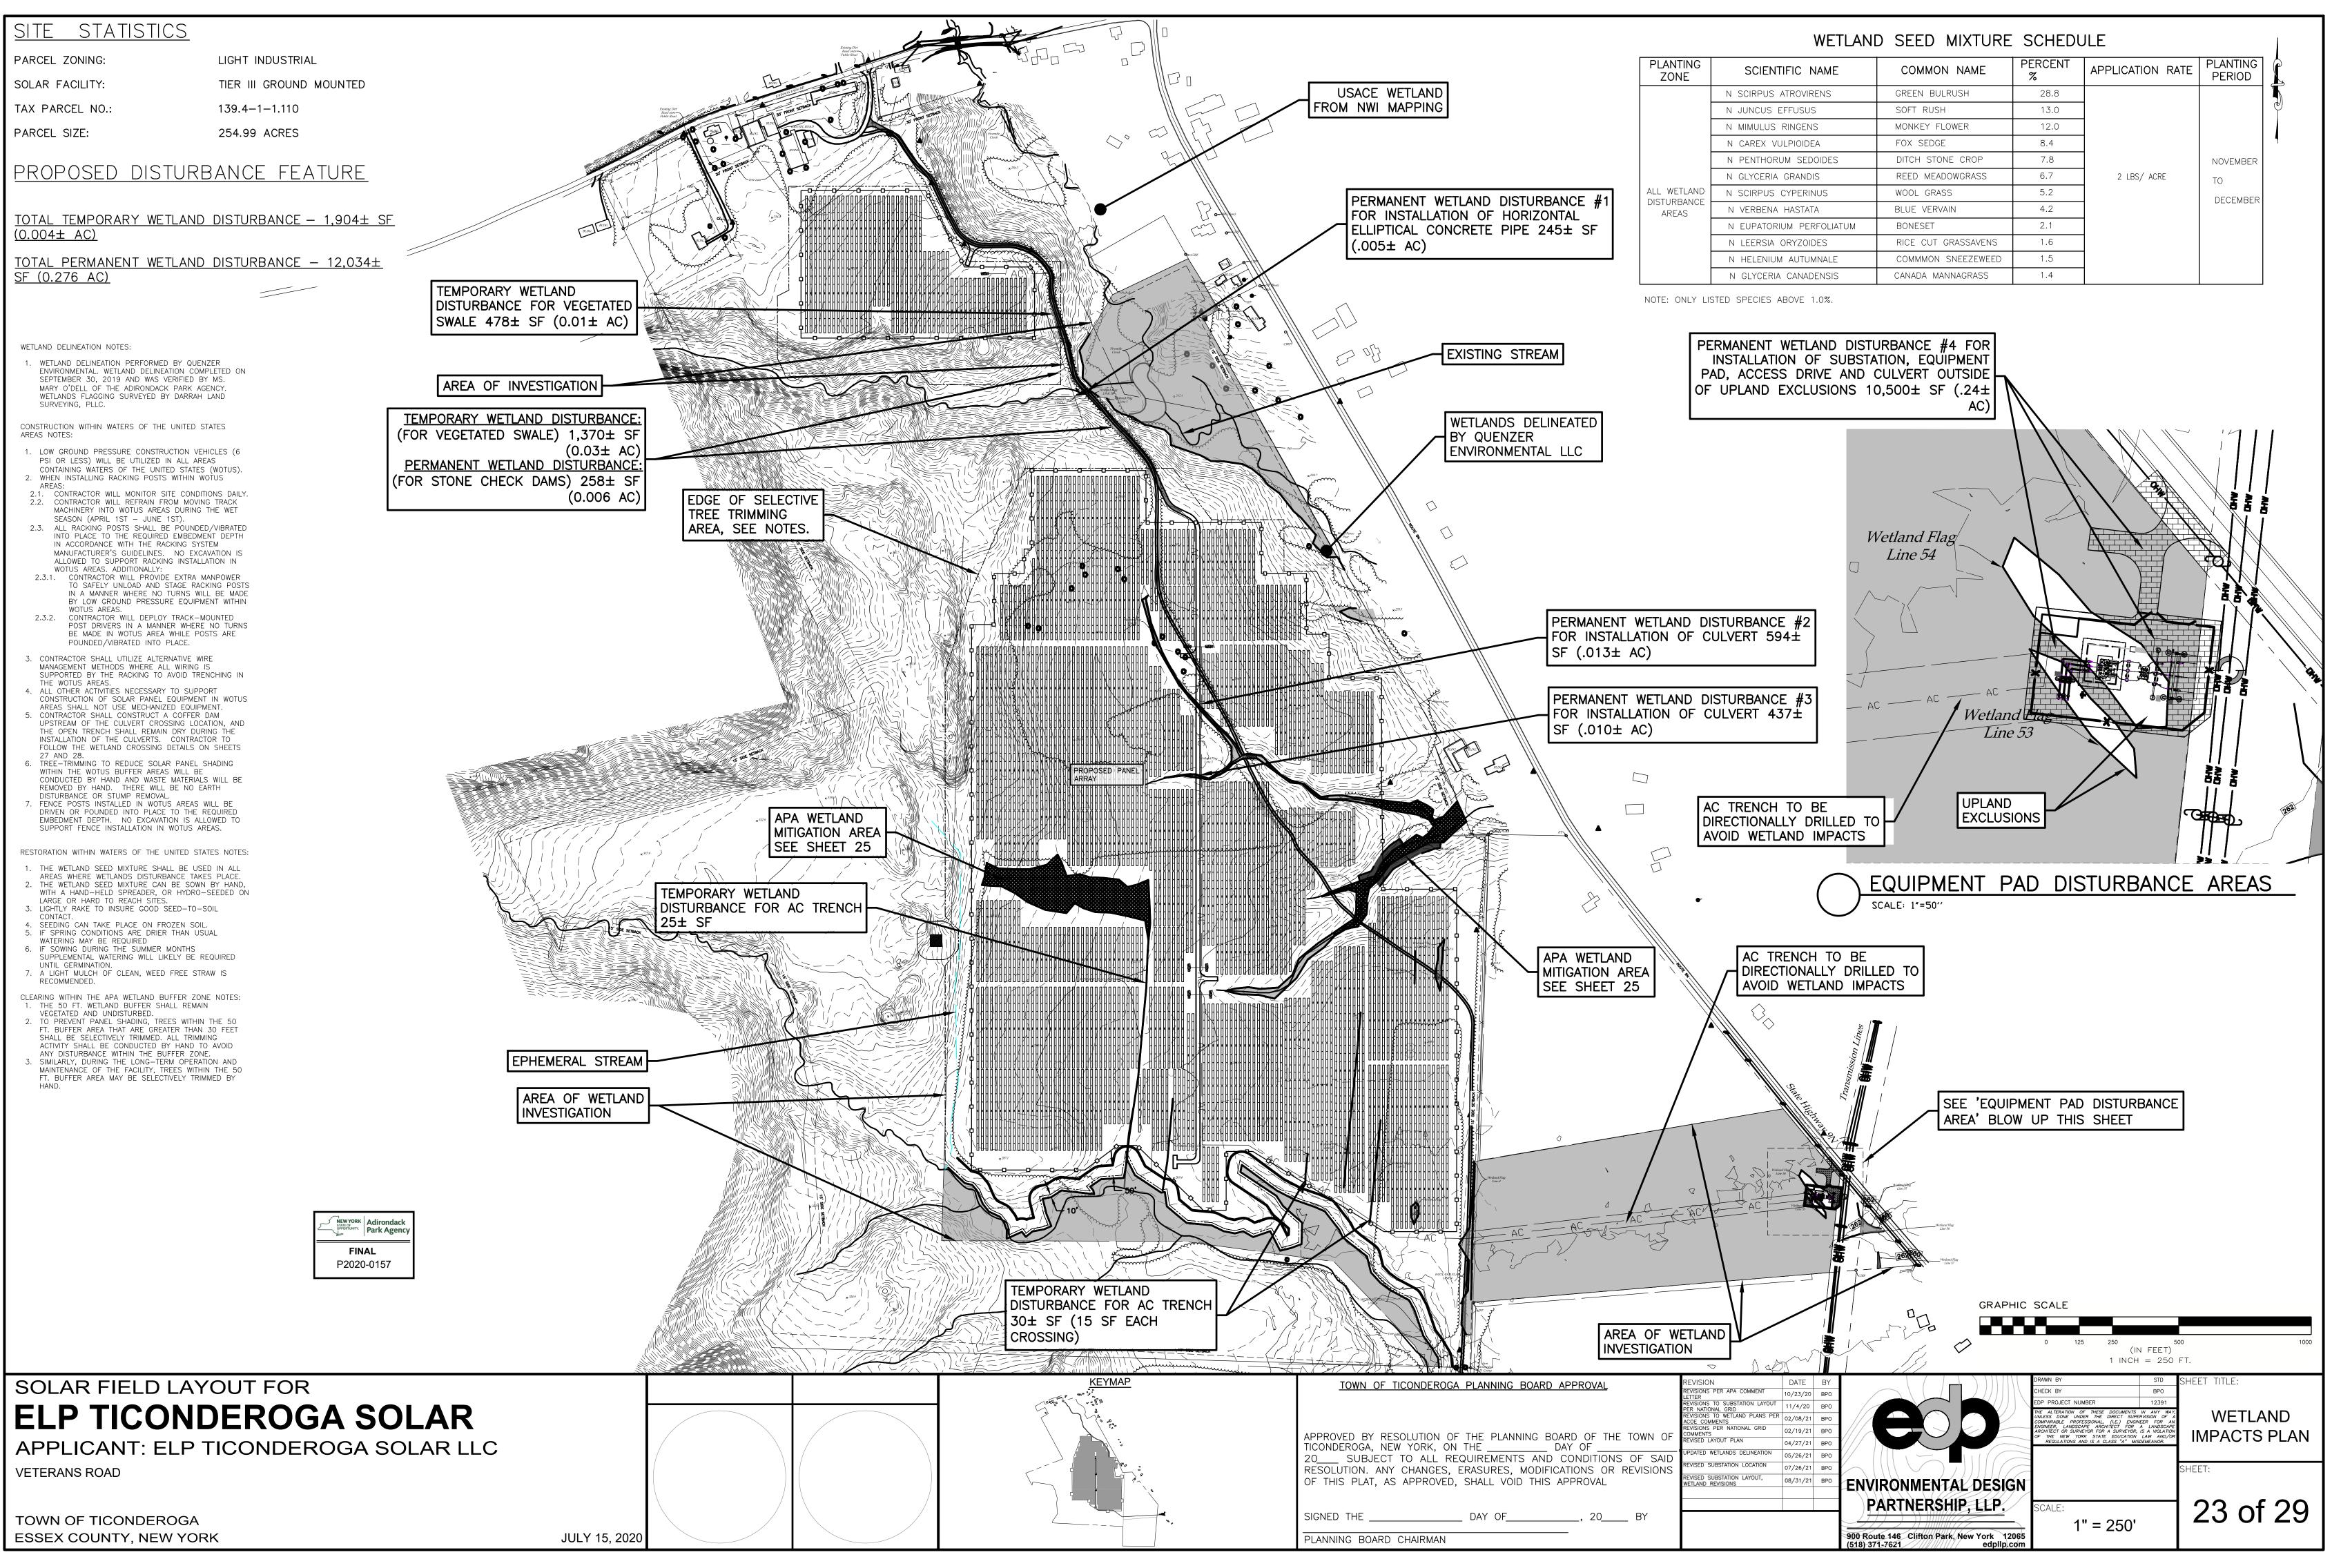

PLANTING ZONE	SCIENTIFIC NAME	COMMON NAME	PERCENT %	APPLICATION RATE	PLANTING PERIOD
	N SCIRPUS ATROVIRENS	GREEN BULRUSH	28.8	_	
Ī	N JUNCUS EFFUSUS	SOFT RUSH	13.0		
Ī	N MIMULUS RINGENS	MONKEY FLOWER	12.0		
Ī	N CAREX VULPIOIDEA	FOX SEDGE	FOX SEDGE 8.4		
Ī	N PENTHORUM SEDOIDES	DITCH STONE CROP	7.8		NOVEMBER
Γ	N GLYCERIA GRANDIS	REED MEADOWGRASS	6.7	2 LBS/ ACRE	то
ALL WETLAND	N SCIRPUS CYPERINUS	WOOL GRASS	5.2		DECEMBER
DISTURBANCE - AREAS	N VERBENA HASTATA	BLUE VERVAIN	4.2		
	N EUPATORIUM PERFOLIATUM	BONESET	2.1		
	N LEERSIA ORYZOIDES	RICE CUT GRASSAVENS	1.6		
	N HELENIUM AUTUMNALE	COMMMON SNEEZEWEED	1.5		
	N GLYCERIA CANADENSIS	CANADA MANNAGRASS	1.4		

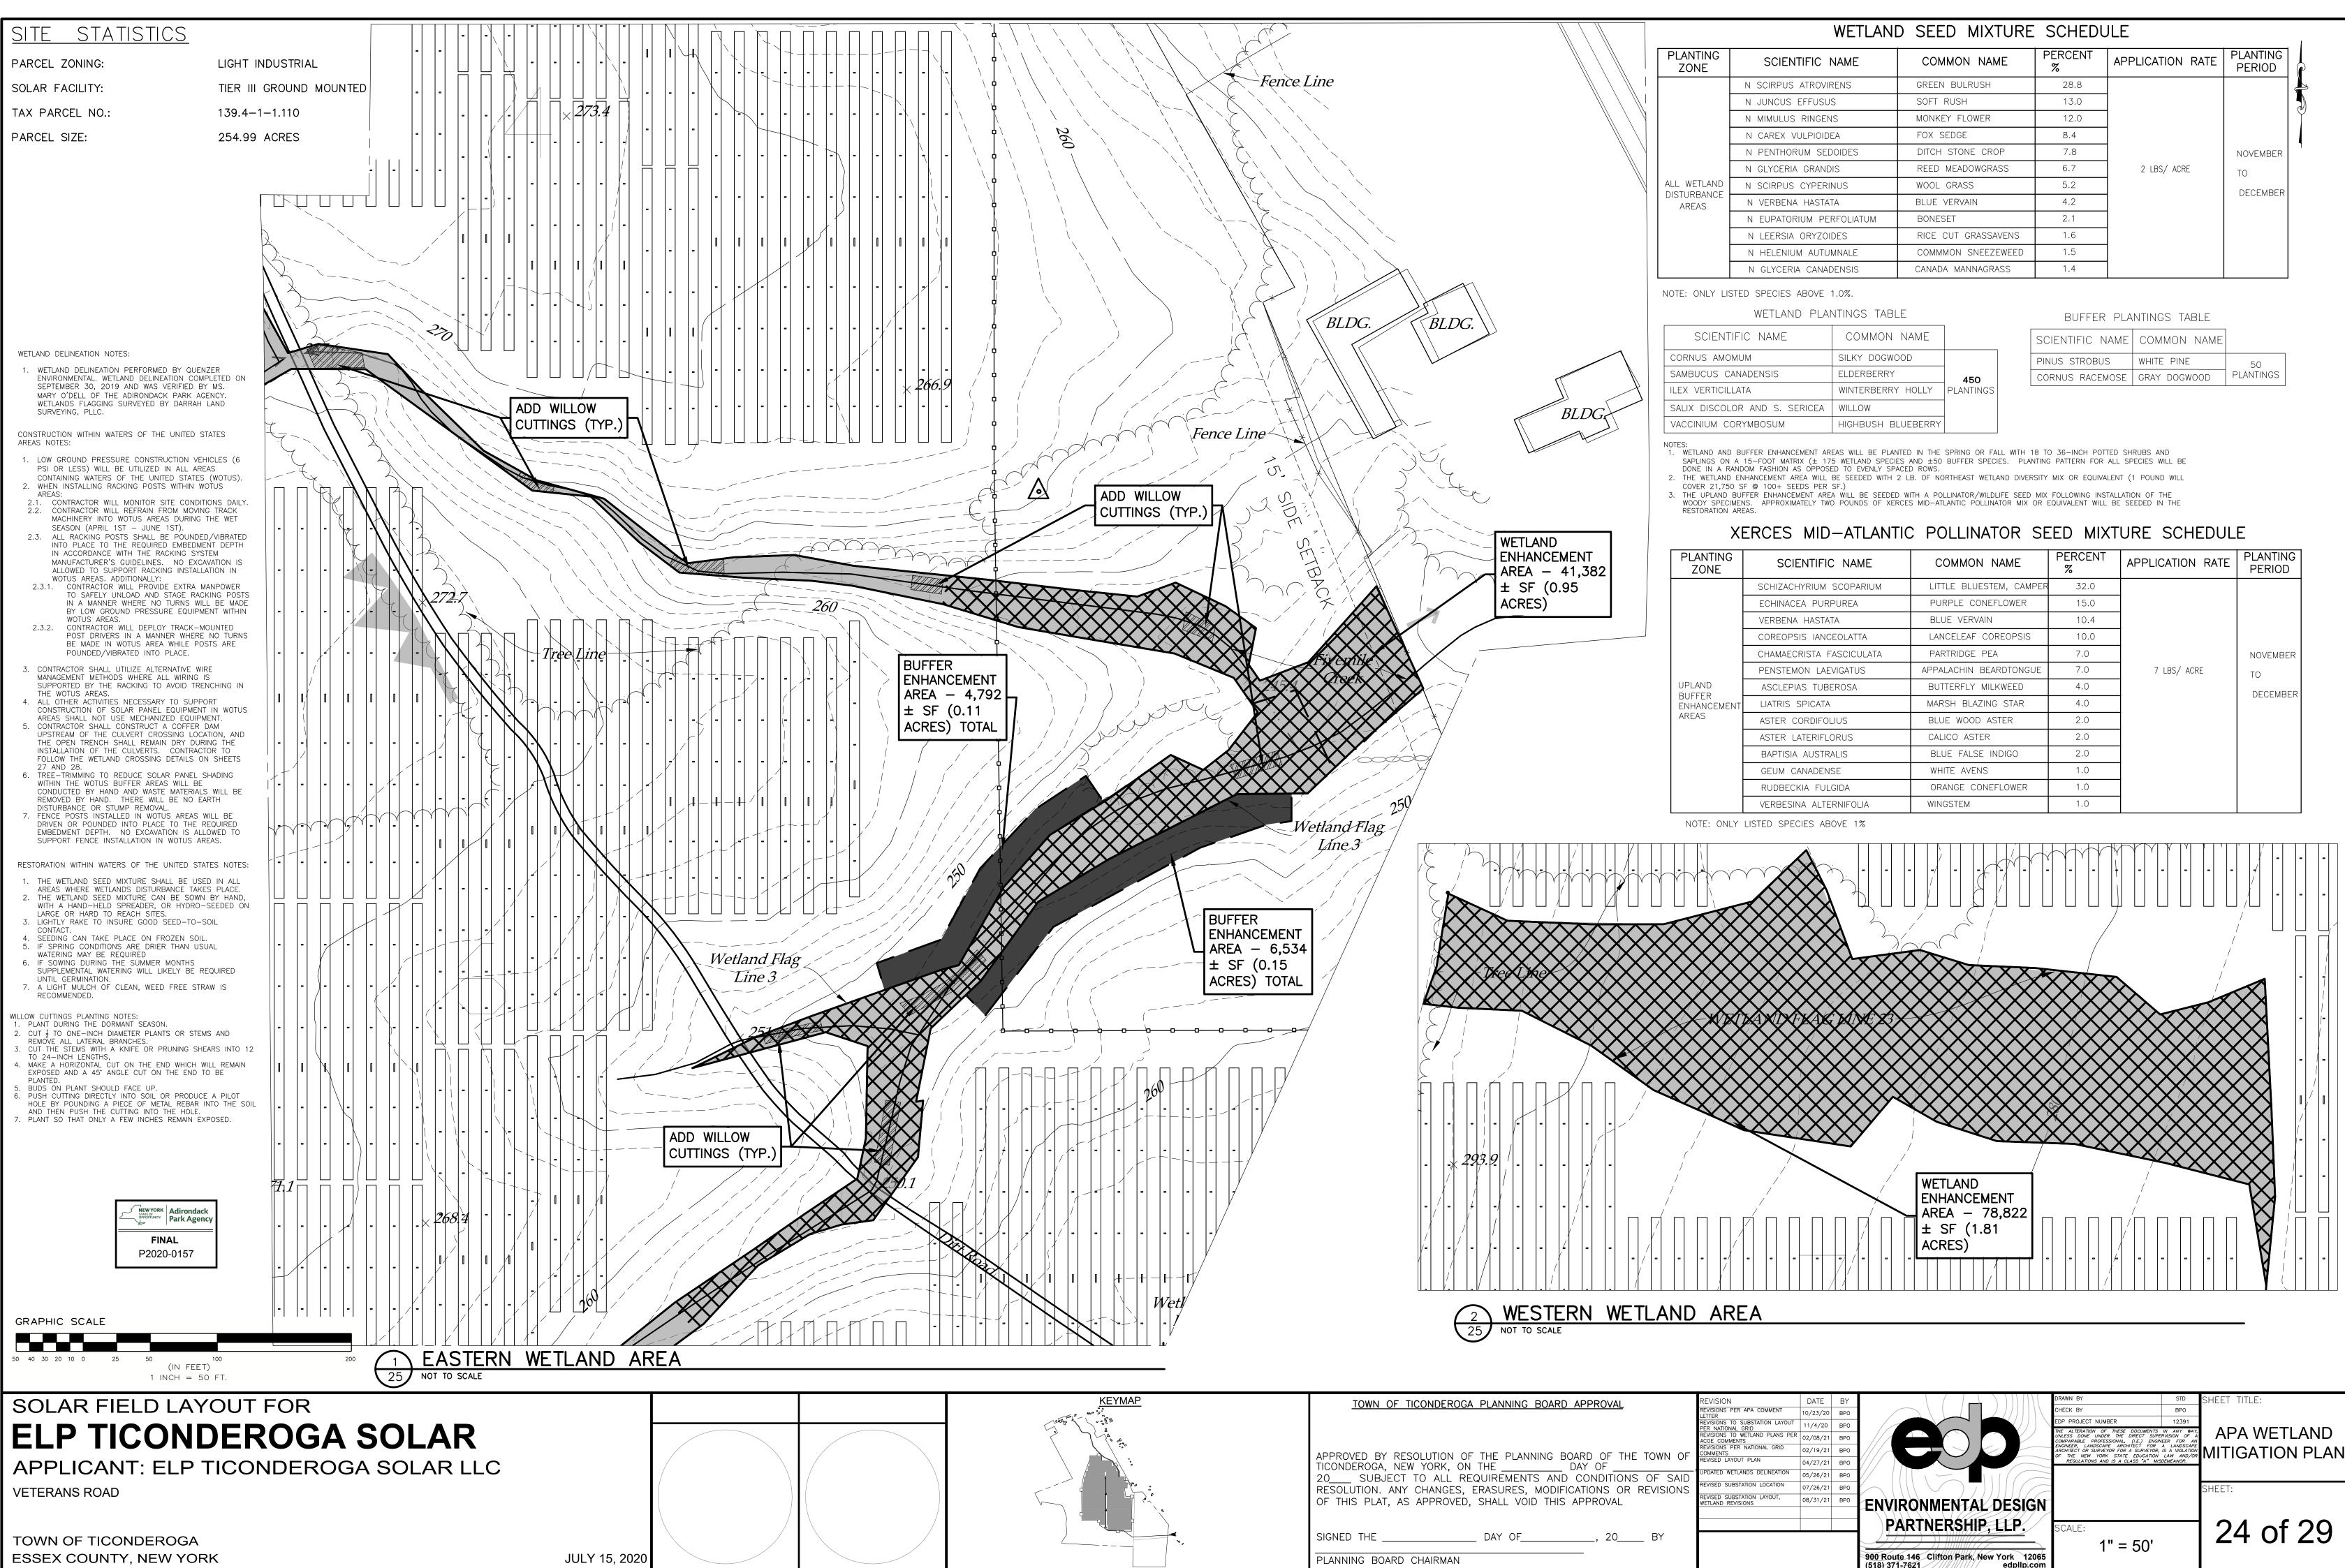

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				-	
G BC	DARD	CHAIRMAN			


PLANTING ZONE	SCIENTIFIC NAME	COMMON NAME	PERCENT %	APPLICATION RATE	PLANTING PERIOD
	N SCIRPUS ATROVIRENS	GREEN BULRUSH	28.8		
Ī	N JUNCUS EFFUSUS	SOFT RUSH	13.0		
Ī	N MIMULUS RINGENS	MONKEY FLOWER	12.0	-	
Ī	N CAREX VULPIOIDEA	FOX SEDGE	8.4		
Ī	N PENTHORUM SEDOIDES	DITCH STONE CROP	7.8		NOVEMBER
Ī	N GLYCERIA GRANDIS	REED MEADOWGRASS	6.7	2 LBS/ ACRE	ТО
ALL WETLAND	N SCIRPUS CYPERINUS	WOOL GRASS	5.2		DECEMBER
DISTURBANCE - AREAS	N VERBENA HASTATA	BLUE VERVAIN	4.2		DECEMBER
Ī	N EUPATORIUM PERFOLIATUM	BONESET	2.1		
Ī	N LEERSIA ORYZOIDES	RICE CUT GRASSAVENS	1.6		
Ī	N HELENIUM AUTUMNALE	COMMMON SNEEZEWEED	1.5	1	
Ī	N GLYCERIA CANADENSIS	CANADA MANNAGRASS	1.4	1	

SCIENTIFIC NAME	COMMON NAME	
CORNUS AMOMUM	SILKY DOGWOOD	
SAMBUCUS CANADENSIS	ELDERBERRY	450
ILEX VERTICILLATA	WINTERBERRY HOLLY	PLANTINGS
SALIX DISCOLOR AND S. SERICEA	WILLOW	
VACCINIUM CORYMBOSUM	HIGHBUSH BLUEBERRY	

SCIENTIFIC NAME	COMMON NAME	
PINUS STROBUS	WHITE PINE	50
CORNUS RACEMOSE	GRAY DOGWOOD	PLANTINGS

PLANTING ZONE	SCIENTIFIC NAME	COMMON NAME	PERCENT %	APPLICATION RATE	PLANTING PERIOD
	SCHIZACHYRIUM SCOPARIUM	LITTLE BLUESTEM, CAMPER	32.0		
	ECHINACEA PURPUREA	PURPLE CONEFLOWER	15.0		
	VERBENA HASTATA	BLUE VERVAIN	10.4		
	COREOPSIS IANCEOLATTA	LANCELEAF COREOPSIS	10.0	7 LBS/ ACRE	
	CHAMAECRISTA FASCICULATA	PARTRIDGE PEA	7.0		NOVEMBER
	PENSTEMON LAEVIGATUS	APPALACHIN BEARDTONGUE	7.0		TO DECEMBER
UPLAND	ASCLEPIAS TUBEROSA	BUTTERFLY MILKWEED	4.0		
BUFFER ENHANCEMENT	LIATRIS SPICATA	MARSH BLAZING STAR	4.0		
AREAS	ASTER CORDIFOLIUS	BLUE WOOD ASTER	2.0	1	
	ASTER LATERIFLORUS	CALICO ASTER	2.0	-	
	BAPTISIA AUSTRALIS	BLUE FALSE INDIGO	2.0		
	GEUM CANADENSE	WHITE AVENS	1.0		
	RUDBECKIA FULGIDA	ORANGE CONEFLOWER	1.0	1	
Γ	VERBESINA ALTERNIFOLIA	WINGSTEM	1.0		

TOWN OF	REVISION REVISIONS PER APA COMMENT LETTER REVISIONS TO SUBSTATION LAYOUT PER NATIONAL GRID REVISIONS TO WEILAND PLANS PER ACOE COMMENTS REVISIONS PER NATIONAL GRID COMMENTS REVISIONS PER NATIONAL GRID COMMENTS REVISIONS PER NATIONAL GRID COMMENTS REVISION LAYOUT PLAN UPDATED WETLANDS DELINEATION	DATE 10/23/20 11/4/20 02/08/21 02/19/21 04/27/21 05/26/21	BY BPO BPO BPO BPO BPO		CHECK BY BPO EDP PROJECT NUMBER 12391 THE ALTERATION OF THESE DOCUMENTS IN ANY WAY, UNLESS DONE LINDER THE DIFFCUSION OF A	SHEET TITLE: APA WETLAND MITIGATION PLAN
REVISIONS	DEVICED CURCTATION LAYOUT	07/26/21	BP0 BP0	ENVIRONMENTAL DESIGN		SHEET:
_ BY				PARTNERSHIP, LLP. 900 Route 146 Clifton Park, New York 12065 (518) 371-7621 edpllp.com	scale: 1" = 50'	24 of 29

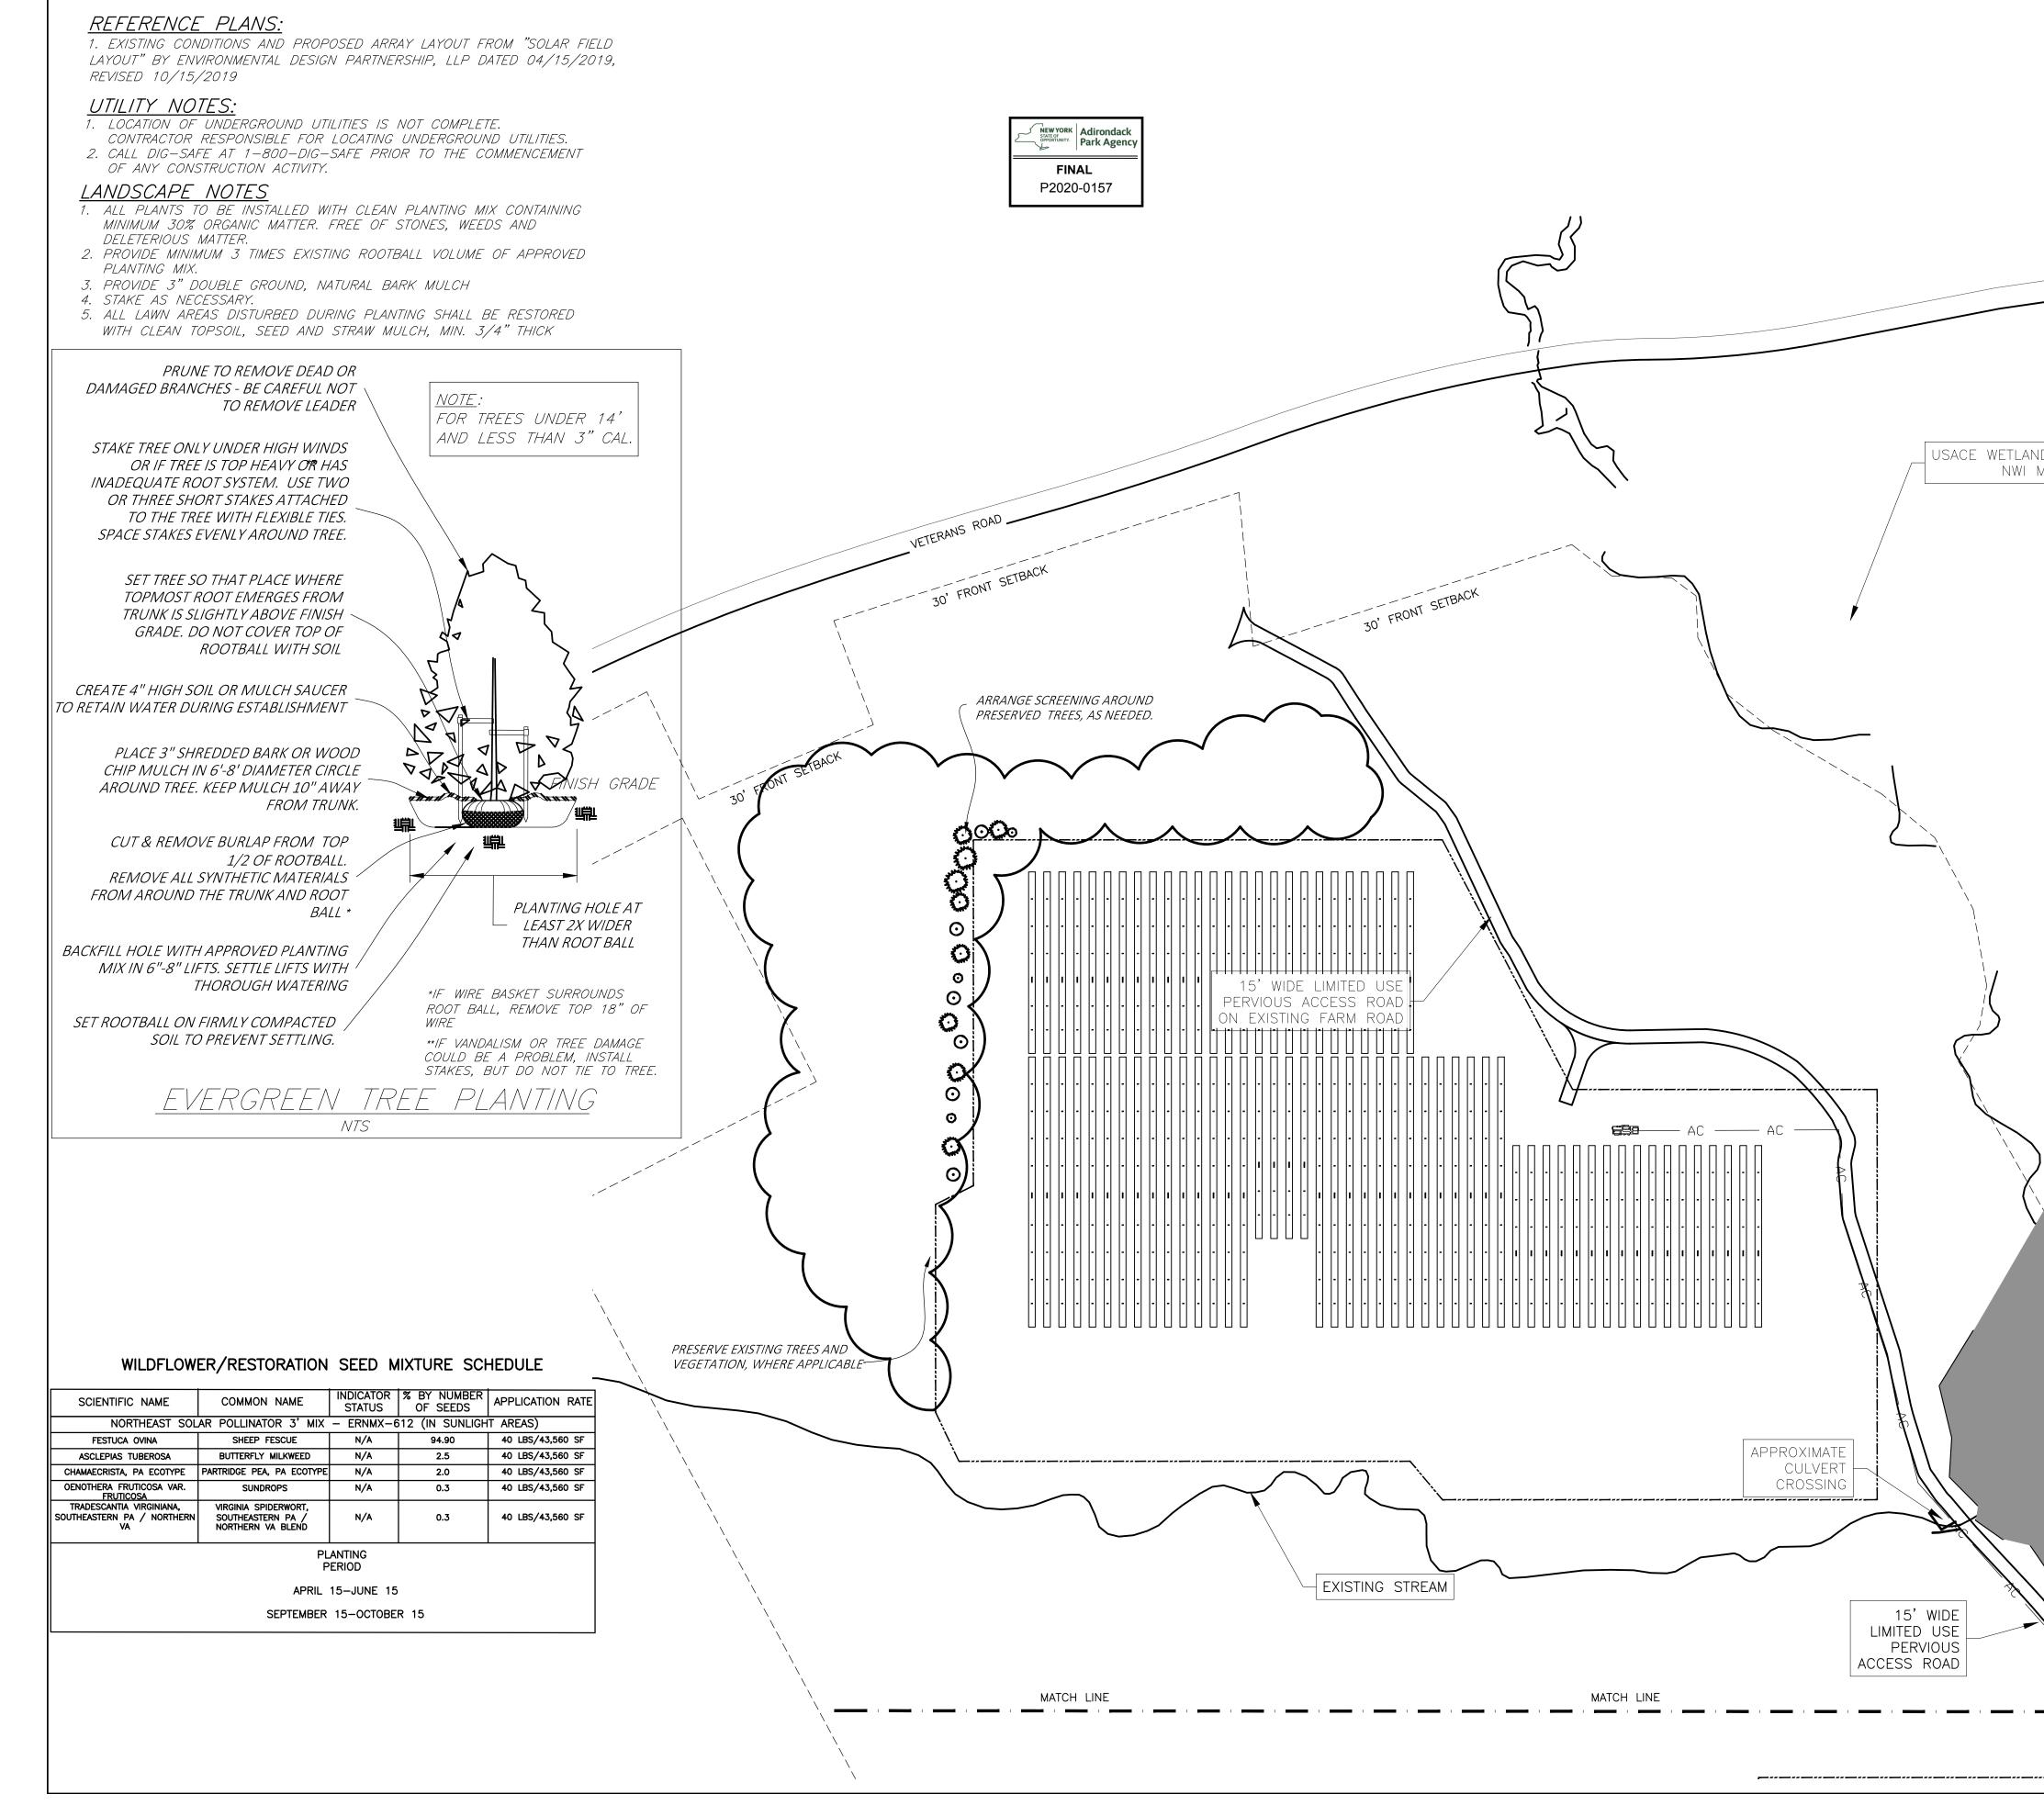

	SEEDING AND MULCHING NOTES	
	 CLEAR AND GRADE THE PROPOSED AREA OF DISTURBANCE. INSTALL AND MAINTAIN ALL EROSION AND SEDIMENT CONTROL 	ELP
	MEASURES THROUGHOUT THE COURSE OF CONSTRUCTION. 3. WHEN ALL DISTURBED AREAS ARE STABLE, REMOVE ALL	TICONDEROGA
	TEMPORARY EROSION AND SEDIMENT CONTROL MEASURES. 4. TEMPORARY EROSION CONTROL PROTECTION BY MULCHING	PREPARED FOR: EAST LIGHT PARTNERS
	MUST BE CARRIED OUT AS THE FILL IS PROGRESSED TO AVOID ALL POSSIBLE CONTAMINATION OF PONDS, STREAMS, OR OTHER WATERCOURSES. PLACEMENT OF JUTE MESH OVER THE MULCH IS RECOMMENDED TO PROVIDE POSITIVE "TACKING" OF THE MULCH AND INCREASED PROTECTION AGAINST EROSION.	CAMBRIDGE, MA
	5. PLAN SITE PREPARATION ACTIVITIES TO MINIMIZE THE SCOPE AND DURATION OF SOIL DISRUPTION.	
	 IF EXISTING SUITABLE TOPSOIL IS NOT ALREADY IN PLACE, TOPSOIL IS TO BE PLACED TO A MINIMUM UNIFORM DEPTH OF 4" OVER THE APPLICATION AREA. DO NOT PLACE WHEN IT IS PARTIALLY FROZEN, MUDDY, ON FROZEN SLOPES OR OVER ICE, SNOW OR STANDING WATER. 	
ID FROM	7. TOPSOIL, WHETHER EXISTING OR IMPORTED, SHALL CONSIST OF NATURAL LOAM TOPSOIL FREE OF COBBLES, CLAY, SAND AND OTHER UNSUITABLE MATERIALS.	
MAPPING	8. CONTRACTOR SHALL BE RESPONSIBLE FOR WATERING, FERTILIZING, MULCHING, ETC. TO ESTABLISH GROWTH AND MAINTAIN SEEDED AREAS UNTIL ACCEPTED BY THE OWNER.	
	9. CONTRACTOR SHALL COMPLY WITH ALL SWPPP REQUIREMENTS.	
	10. INSPECT THE PROJECT SITE AND ALL EROSION AND SEDIMENT CONTROL PRACTICES AFTER EACH RAIN EVENT AND ON A WEEKLY BASIS IN ACCORDANCE WITH THE PROJECT SPECIFIC SWPPP.	
	11. REPAIR AND REMEDY ANY EROSION AND SEDIMENT CONTROL PRACTICES OBSERVED TO BE DEFICIENT OR IN NEED OF REPAIR OR AT THE DIRECTION OF THE DIRECTOR'S REPRESENTATIVE.	
	12. IMPLEMENT AND COMPLY WITH ALL THE PROJECT-SPECIFIC SWPPP REQUIREMENTS.	
	13. STABILIZE DISTURBED AREAS IMMEDIATELY BUT NOT MORE THAN SEVEN DAYS AFTER SOIL DISTURBANCE HAS CEASED.	
	14. ALL AREAS WITHIN THE FENCE LINE AND ALL DISTURBED AREAS OUTSIDE THE FENCE LINE, INCLUDING TEMPORARY LAYDOWN AREAS, WILL BE SEEDED AND RESTORED.	
	$\setminus \setminus$	
	APPROXIMATE WETLANDS DELINEATED BY QUENZER ENVIRONMENTAL (TYP.)	
)		PURPOSE OF DRAWING: DRAFT CONCEPT FOR CLIENT REVIEW MAY 28, 2020 NOT FOR CONSTRUCTION
		LANDSCAPING PLAN
		REVISION REVISED SEED MIX AND PLANTINGS 10/23/2020
		PREPARED BY: HUBBARD LAND DESIGN E. ADAM HUBBARD, RLA 492 BEEBE RD. PUTNEY, VT 05346 802-380-5875 Adam@HubbardLandDesign.com
	MATCH LINE	SCALE 1"=100'@ 24X36"
		DATE 05/28/2020
		PAGE L-2 SHEET 25 of 29

