



SITE LOCATION MAP
SCALE: 1" = 800'

RV PARK FOR WOODS HOLLOW CAMPGROUND

APPLICANT/OWNER:
WOODS HOLLOW MINING CO
WOODS HOLLOW ROAD
TOWN OF MAYFIELD, FULTON COUNTY, NEW YORK

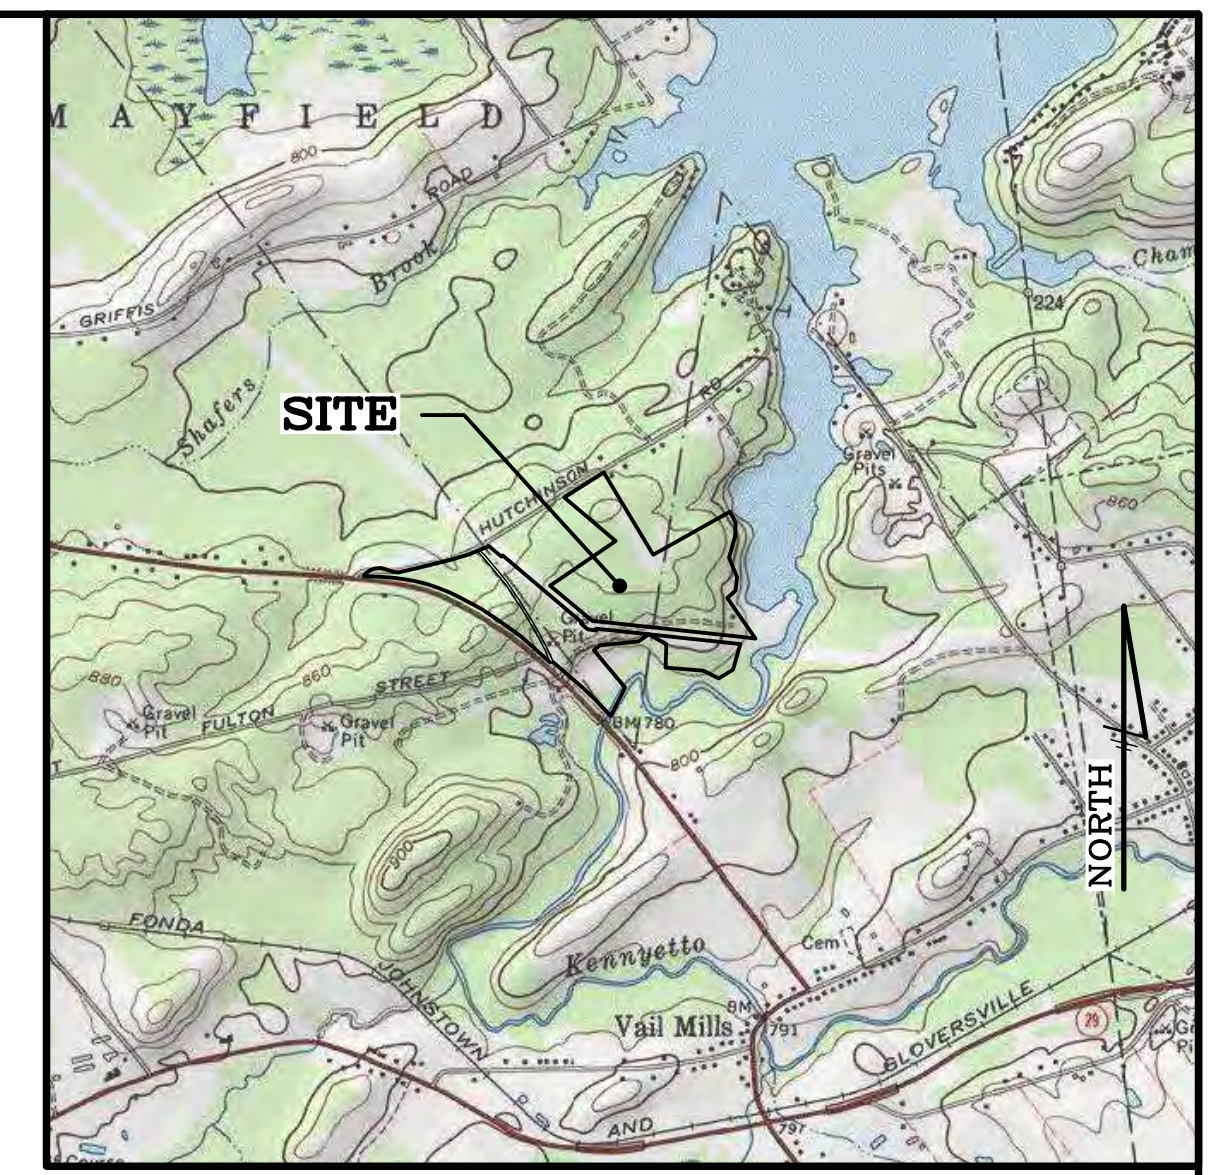

SITE LOCATION MAP
SCALE: 1" = 2,000'

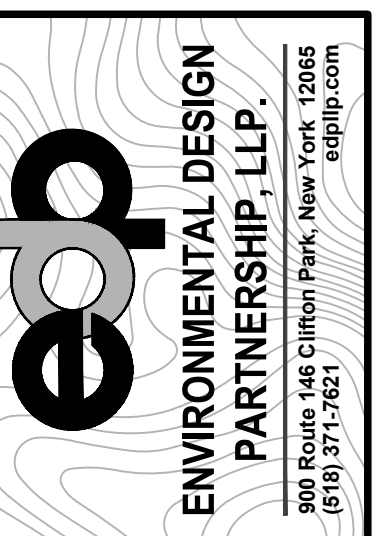

ENVIRONMENTAL DESIGN
PARTNERSHIP, LLP.
908 Route 148 Clifton Park, New York 12065
(518) 371-7621

RV PARK FOR
WOODS HOLLOW CAMPGROUND
WOODS HOLLOW MINING COMPANY
WOODS HOLLOW ROAD
TOWN OF MAYFIELD
FULTON COUNTY, NEW YORK



TAX MAP No. 137-4-51, 137-4-52,
137-4-54, 137-4-55, 137-4-56
137-4-54.11, 137-4-55.1, 137-4-56.1
OCTOBER 6, 2021

SITE STATISTICS

EXISTING ZONING	COMMERCIAL
PARCEL AREA	82.0± ACRES
PARCEL NUMBERS	137-4-51, 137-4-52, 137-4-54.11, 137-4-55, 137-4-56
MAXIMUM BUILDING HEIGHT	35 FT
PROPOSED USE	CAMPGROUND
PROPOSED NUMBER OF RV-CAMPING LOTS:	
RV SITES	213
GLAMPING	32
TENTS	19
PRIMITIVE	13
TOTAL PROPOSED NUMBER OF LOTS	277
MAXIMUM ALLOWABLE DENSITY	12 RV LOTS PER GROSS AREA (800+ RV LOTS)
PROPOSED DENSITY	2.6 RV LOTS PER GROSS AREA
RV LOT MIN AREA	2,500 SF
RV LOT MIN. DIMENSIONS	30 FT
REQUIRED SETBACKS	
FROM ADJACENT RV	20 FT
PROPERTY LINE	50 FT
PUBLIC R.O.W.	50 FT
EDGE OF ROAD (WITHIN PARK)	10 FT
HUDSON RIVER-BLACK RIVER REGULATING DISTRICT (HRBRDD)	5 FT
RV STAND	AS REQUIRED FOR ANTICIPATED LOADS
ACCESSIBILITY	2 POINTS OF ACCESS REQUIRED FOR 16+ RV LOTS
STREETS	
ONE WAY	18 FT ROADBED
TWO WAY	28 FT ROADBED
DRIVEWAY	9 FT MIN WIDTH
PARKING	1 OFF-STREET SPACE PER RV LOT
OPEN SPACE REQUIRED	10% OF GROSS LAND AREA OF THE PARK
OPEN SPACE PROPOSED	12% OF GROSS LAND AREA OF THE PARK
WATER	ON-SITE (WELL)
SANITARY	ON-SITE (SEPTIC)
STORMWATER MANAGEMENT	ONSITE

SHEET INDEX



SHEET NUMBER	SHEET TITLE
1	COVER SHEET
2	EXISTING CONDITIONS
3	OVERALL SITE PLAN
4	GRADING AND DRAINAGE PLAN
5	GRADING AND DRAINAGE PLAN
6	GRADING AND DRAINAGE PLAN
7	GRADING AND DRAINAGE PLAN
8	UTILITY PLAN
9	UTILITY PLAN
10	UTILITY PLAN
11	UTILITY PLAN
12	EROSION AND SEDIMENT CONTROL PLAN
13	SITE DETAILS
14	PLANTING AND SIGN DETAILS
15	WATER DETAILS
16	STORMWATER DETAILS
17	SANITARY SEWER DETAILS
18	SANITARY SEWER DETAILS
19	LIGHTING PLAN

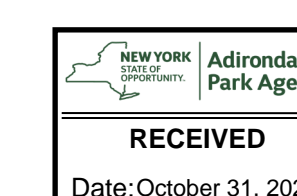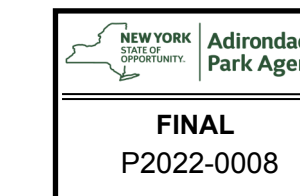

RECORD OF SUBMITTALS	DATE	BY

PLANS PREPARED BY:

ENVIRONMENTAL DESIGN
PARTNERSHIP, LLP.
908 Route 148 Clifton Park, New York 12065
(518) 371-7621 edplp.com

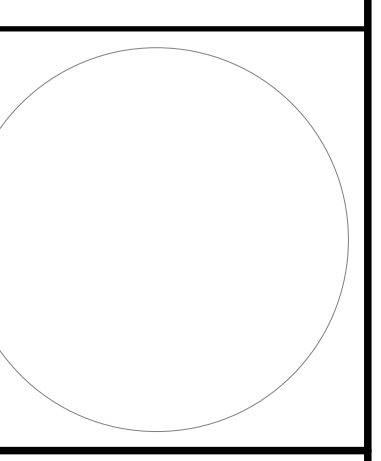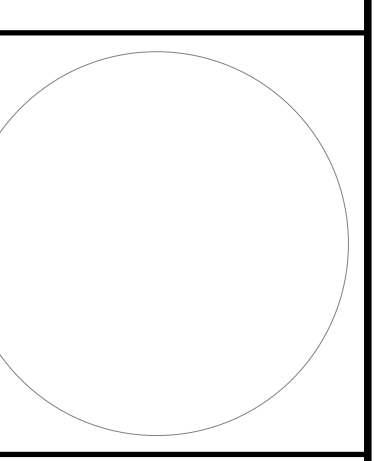

SCALE:
AS NOTED

NOT FOR
CONSTRUCTION

SHEET TITLE:
COVER
SHEET

SHEET:
1 of 19

D:\FULTON\MAYFIELD\Woods Hollow Road\170 - WmMay\554-Adj\Checked Plans\B/EET/8/60_CS-Woods Hollow Road.dwg Sep 28, 2022 09:42:23AM



REFERENCE NOTES:

- 1) SITE PLANS ARE BASED ON A PROPERTY BOUNDARY MAP PREPARED BY FERROUS & FOSS PROFESSIONAL LAND SURVEYORS, PC, TITLED, "SURVEY MAP OF LANDS OF LANE & JAMIE WINNEY, TOWN OF MAYFIELD, COUNTY OF FULTON, STATE OF NEW YORK, DATED JUNE 30, 2021."
 A. THE SURVEY WAS PERFORMED WITHOUT BENEFIT OF AN ABSTRACT OF THE TITLE AND IS SUBJECT TO ANY STATEMENT OF FACT AN ABSTRACT OF TITLE MAY REVEAL.
 B. EXCEPTING ANY RIGHT TITLE OR INTEREST THAT THE STATE OF NEW YORK OR COUNTY OF FULTON MAY RETAIN TO THE ORIGINAL STATE ROAD RIGHT OF WAY.
- 2) THE ADIRONDACK PARK BOUNDARY LINE OR ADIRONDACK PARK AGENCY (APA) BLUELINE IS PLOTTED BY ENVIRONMENTAL DESIGN PARTNERSHIP, LLP, FROM NYS APA BOUNDARY LINE DATA, PUBLISHED 2018. LEGAL DESCRIPTION FOUND IN NYS ENVIRONMENTAL CONSERVATION LAW 89-0101.
- 3) TOPOGRAPHIC INFORMATION SHOWN HEREON IS THE RESULT OF AERIAL IMAGERY AND LIDAR DATA RECORDED ON JULY 20, 2022. PHOTOGAMMETRIC ANALYSIS AND ANALYTICAL TRIANGULATION COMPLETED BY ENVIRONMENTAL DESIGN PARTNERSHIP, LLP. ALL MAPPING WITHIN THE NATIONAL MAP ACCURACY STANDARDS AS PUBLISHED BY USGS.
- 4) WETLAND BOUNDARIES DELINEATED BY MELANIE MUSARRA OF ENVIRONMENTAL DESIGN PARTNERSHIP, LLP IN JULY OF 2021.

SOIL DATA:
 THE FOLLOWING TEST PITS WERE PERFORMED ON JUNE 25, 2021 AND WERE OBSERVED BY ENVIRONMENTAL DESIGN PARTNERSHIP, LLP.

TP#1
 0" - 48" CLEAN BROWN FINE SAND
 NO EVIDENCE OF MOTTLING OR SEASONAL WATER TABLE

TP#2
 0" - 48" CLEAN BROWN FINE SAND
 NO EVIDENCE OF MOTTLING OR SEASONAL WATER TABLE

TP#3
 0" - 6" FINE SANDY TOPSOIL/FOREST DUFF
 6" - 48" LIGHT BROWN FINE SAND, SOME SILT WITH DEPTH
 NO EVIDENCE OF MOTTLING OR SEASONAL WATER TABLE

TP#4
 0" - 7" BROWN SANDY TOPSOIL
 7" - 18" RED BROWN FINE SAND
 18" - 48" LIGHT BROWN FINE SAND, SOME ROCKS 3"-4"
 NO EVIDENCE OF MOTTLING OR SEASONAL WATER TABLE

TP#5
 0" - 10" BROWN SANDY TOPSOIL/FOREST DUFF
 10" - 15" RED BROWN FINE SAND
 15" - 48" LIGHT BROWN FINE SAND, SOME ROCKS 3"-4"
 NO EVIDENCE OF MOTTLING OR SEASONAL WATER TABLE

TP#6
 0" - 8" LIGHT BROWN SAND WITH ROCK
 8" - BOTTOM OF MINE FLOOR
 NO EVIDENCE OF MOTTLING OR SEASONAL WATER TABLE

TP#7
 THE FOLLOWING TEST PITS WERE PERFORMED ON MAY 28, 2021 AND WERE OBSERVED BY ENVIRONMENTAL DESIGN PARTNERSHIP, LLP.

TP#8
 0" - 8" BROWN SANDY TOPSOIL/FOREST DUFF
 8" - 20" LIGHT BROWN FINE SAND
 20" - 48" DARK BROWN FINE SAND
 NO EVIDENCE OF MOTTLING OR SEASONAL WATER TABLE

TP#9
 0" - 8" BROWN SANDY TOPSOIL/FOREST DUFF
 8" - 22" RED BROWN FINE SAND
 22" - 48" DARK BROWN FINE SAND
 NO EVIDENCE OF MOTTLING OR SEASONAL WATER TABLE

TP#10
 STABILIZED PERCOLATION RATE = 1.0 MIN./IN.

TP#11
 STABILIZED PERCOLATION RATE = 1 MIN 10 SEC./IN.

TP#12
 STABILIZED PERCOLATION RATE = 3 MIN 50 SEC./IN.

TP#13
 STABILIZED PERCOLATION RATE = 1 MIN 5 SEC./IN.

TP#14
 STABILIZED PERCOLATION RATE = 1 MIN 15 SEC./IN.

TP#15
 STABILIZED PERCOLATION RATE = 1 MIN 5 SEC./IN.

TP#16
 STABILIZED PERCOLATION RATE = 1 MIN 30 SEC./IN.

TP#17
 STABILIZED PERCOLATION RATE = 1 MIN 30 SEC./IN.

TP#18
 STABILIZED PERCOLATION RATE = 1 MIN 30 SEC./IN.

SOIL DATA:
 THE FOLLOWING TEST PITS WERE PERFORMED ON DECEMBER 2, 2021 AND WERE OBSERVED BY ENVIRONMENTAL DESIGN PARTNERSHIP, LLP.

TP#9
 0" - 13" FINE SANDY TOPSOIL
 13" - 24" ORANGE MEDIUM TO FINE SAND
 24" - 72" FINE SAND, BROWN
 NO GROUNDWATER OR MOTTLING OBSERVED

PT.#2
 STABILIZED PERCOLATION RATE = 1 MIN. 45 SEC./IN.

TP#10
 0" - 10" FINE SANDY TOPSOIL
 10" - 24" ORANGE/RED FINE SAND
 24" - 72" FINE SAND, BROWN
 NO GROUNDWATER OR MOTTLING OBSERVED

PT#10
 STABILIZED PERCOLATION RATE = 4 MIN. 30 SEC./IN.

TP#11
 0" - 11" FINE SANDY TOPSOIL
 11" - 30" ORANGE/RED FINE SAND
 30" - 72" FINE SAND, BROWN
 NO GROUNDWATER OR MOTTLING OBSERVED

PT#11
 STABILIZED PERCOLATION RATE = 4 MIN. 10 SEC./IN.

TP#12
 0" - 4" FINE SANDY TOPSOIL
 4" - 15" ORANGE/RED FINE SAND
 15" - 72" FINE SAND, BROWN
 NO GROUNDWATER OR MOTTLING OBSERVED

PT#12
 STABILIZED PERCOLATION RATE = 2 MIN. 45 SEC./IN.

TP#13
 NO TOPSOIL
 0" - 72" FINE SAND, BROWN
 NO GROUNDWATER OR MOTTLING OBSERVED

PT#13
 STABILIZED PERCOLATION RATE = 3 MIN. 00 SEC./IN.

TP#14
 0" - 8" FINE SANDY TOPSOIL
 8" - 30" ORANGE/RED FINE SAND
 30" - 72" FINE SAND, BROWN
 NO GROUNDWATER OR MOTTLING OBSERVED

PT#14
 STABILIZED PERCOLATION RATE = 5 MIN. 00 SEC./IN.

TP#15
 0" - 6" FINE SANDY TOPSOIL
 6" - 36" ORANGE/RED FINE SAND
 36" - 72" FINE SAND, BROWN
 NO GROUNDWATER OR MOTTLING OBSERVED


PT#15
 STABILIZED PERCOLATION RATE = 5 MIN. 00 SEC./IN.

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 P2022-0008

GRAPHIC SCALE
 1" = 120'
 (IN FEET)
 1 INCH = 120 FT.


NO.	DATE	BY
1	7/21/22	TM
2	7/21/22	TM
3	8/12/22	TM

DESIGNED BY	STA	
CHECKED BY	14	
PER PROJECT NUMBER	140201	
<small>THIS PLAN IS A PART OF THE PROJECT AND IS NOT TO BE USED SEPARATELY. THE USER SHALL BE RESPONSIBLE FOR OBTAINING ALL NECESSARY PERMITS AND APPROVALS FROM THE APPROPRIATE AGENCIES. THE USER SHALL BE RESPONSIBLE FOR OBTAINING ALL NECESSARY PERMITS AND APPROVALS FROM THE APPROPRIATE AGENCIES. THE USER SHALL BE RESPONSIBLE FOR OBTAINING ALL NECESSARY PERMITS AND APPROVALS FROM THE APPROPRIATE AGENCIES.</small>		
REVISION	DATE	BY
REVISED FOR MUNICIPAL COMMENTS	7/20/22	14M
SUBMITTED TO APA	7/21/22	TAM
SUBMITTED TO APA AND DOH	8/18/22	TAM

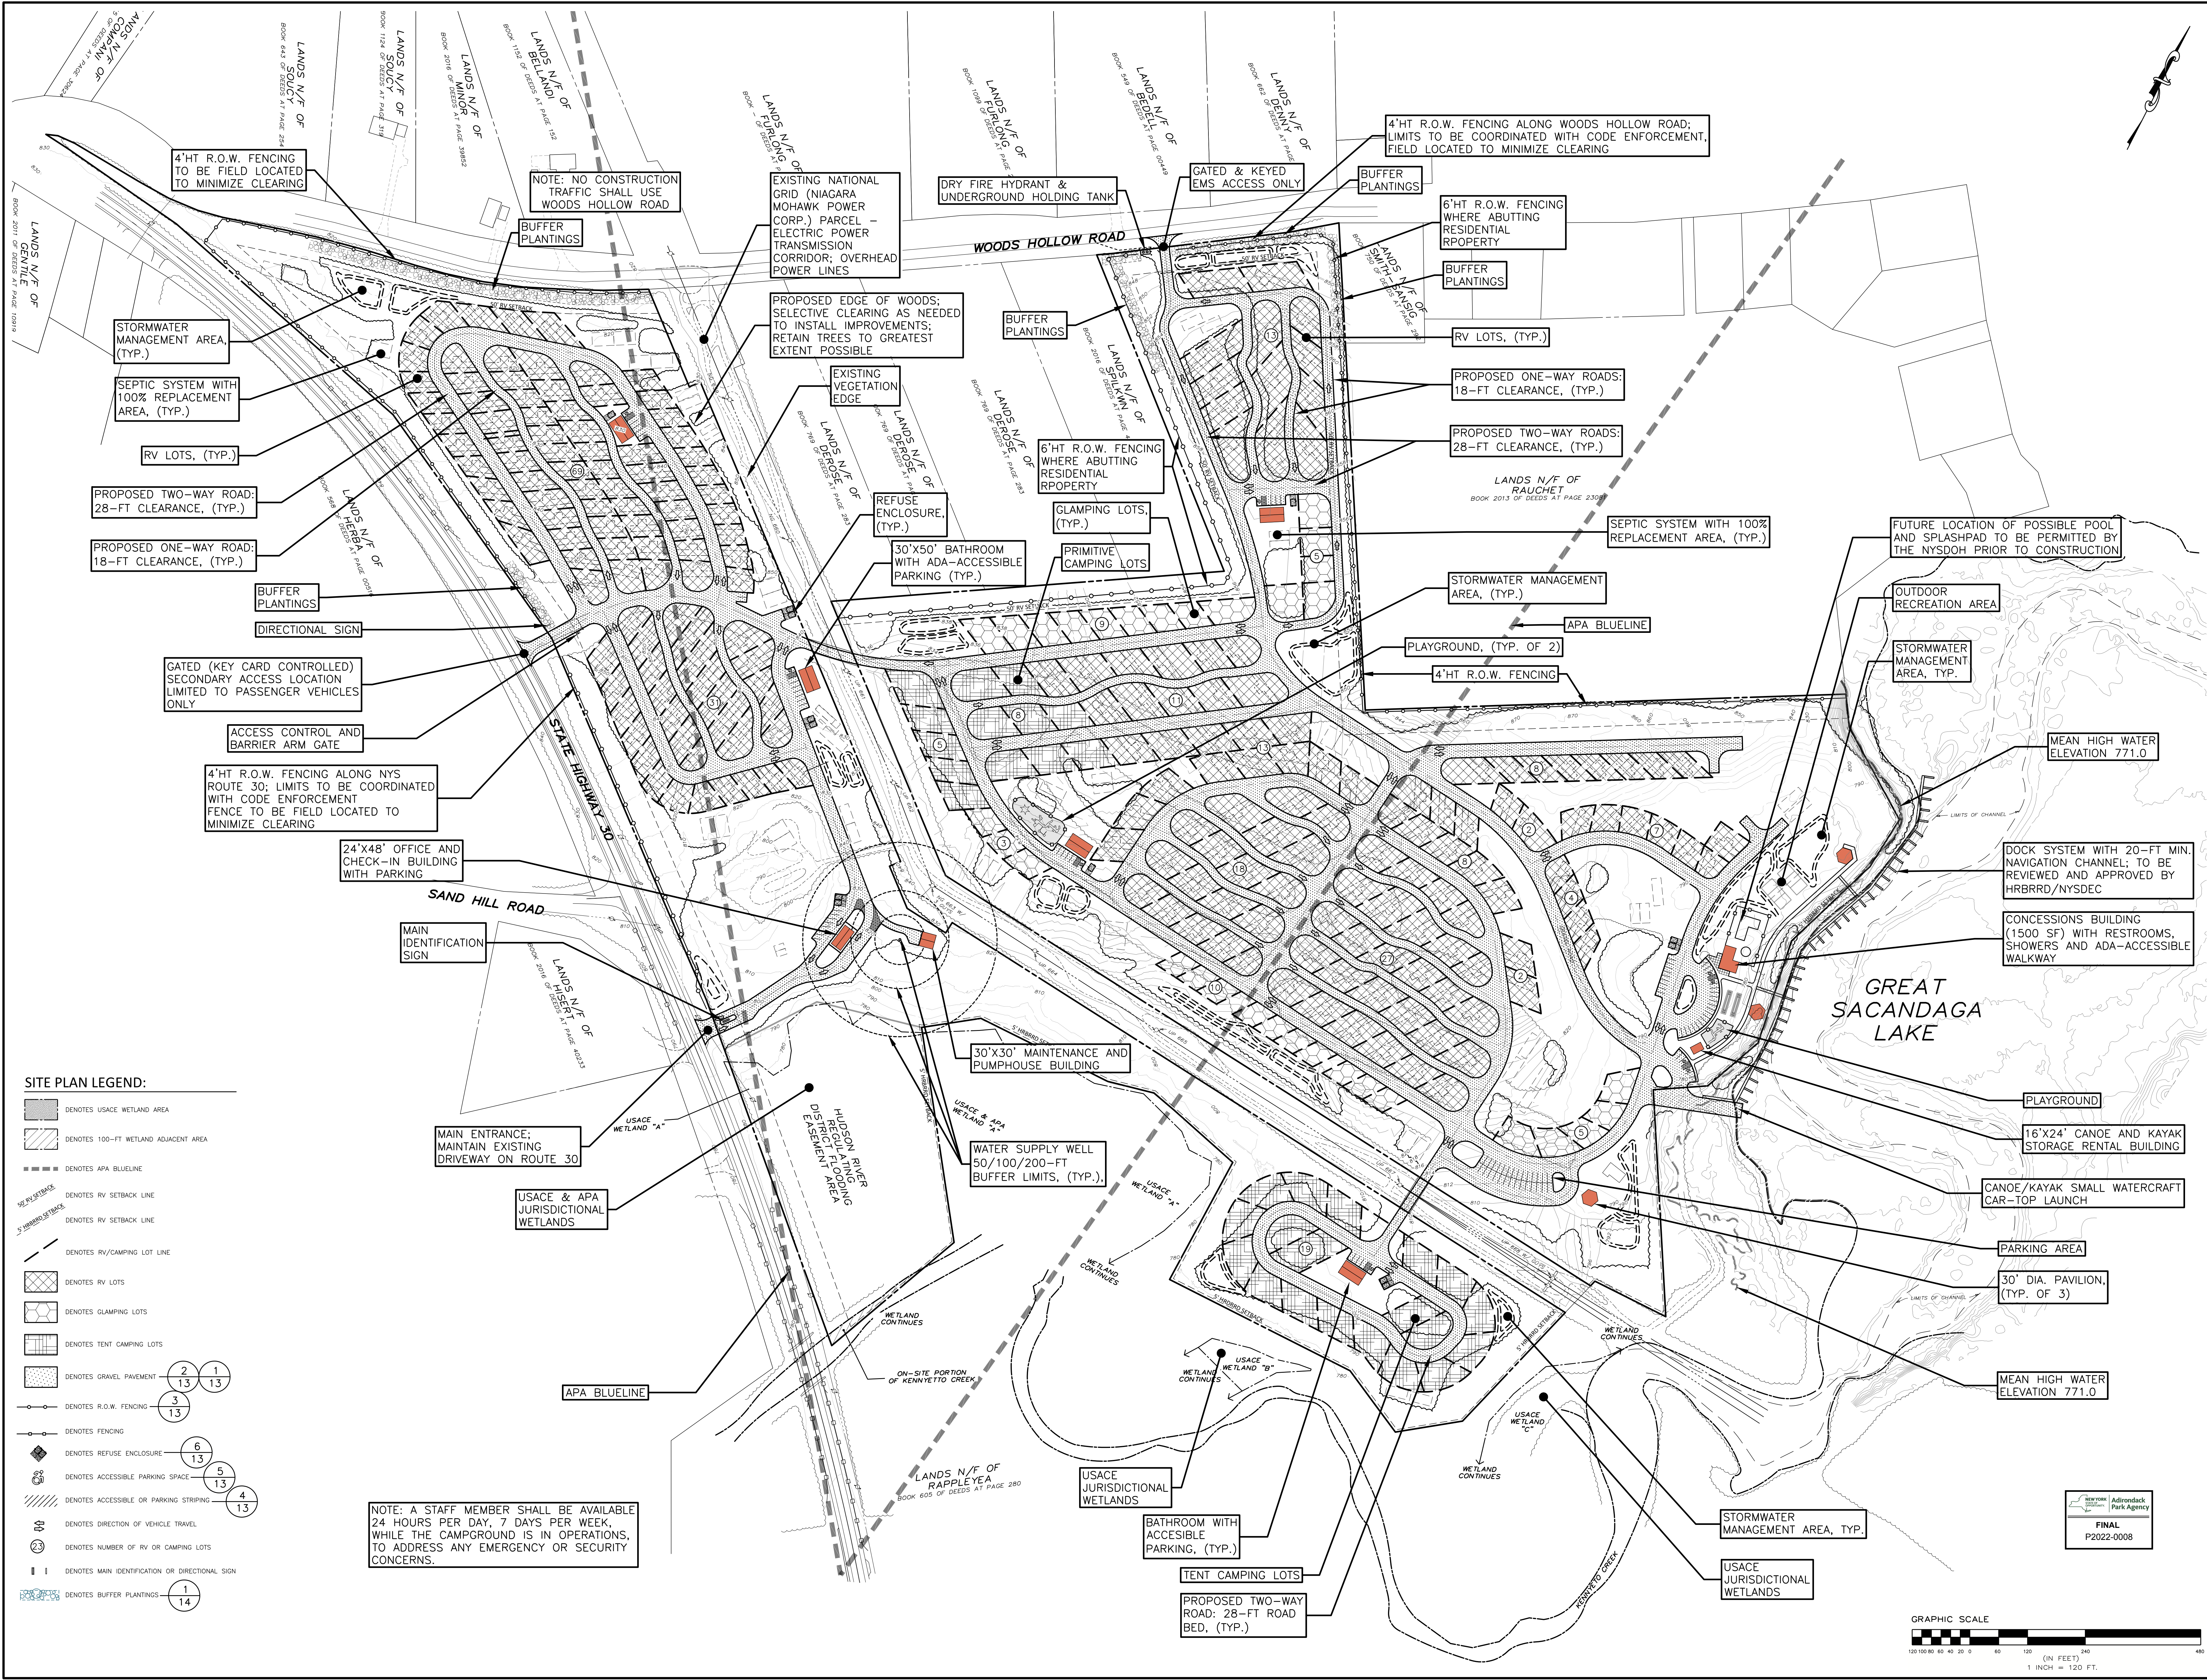

- SITE PLAN LEGEND:**
- DENOTES USACE WETLAND AREA
 - DENOTES 100-FT WETLAND ADJACENT AREA
 - DENOTES APA BLUELINE
 - DENOTES RV SETBACK LINE
 - DENOTES RV SETBACK LINE
 - DENOTES RV/CAMPING LOT LINE
 - DENOTES RV LOTS
 - DENOTES GLAMPING LOTS
 - DENOTES TENT CAMPING LOTS
 - DENOTES GRAVEL PAVEMENT
 - DENOTES R.O.W. FENCING
 - DENOTES FENCING
 - DENOTES REFUSE ENCLOSURE
 - DENOTES ACCESSIBLE PARKING SPACE
 - DENOTES ACCESSIBLE OR PARKING STRIPING
 - DENOTES DIRECTION OF VEHICLE TRAVEL
 - DENOTES NUMBER OF RV OR CAMPING LOTS
 - DENOTES MAIN IDENTIFICATION OR DIRECTIONAL SIGN
 - DENOTES BUFFER PLANTINGS

NOTE: A STAFF MEMBER SHALL BE AVAILABLE 24 HOURS PER DAY, 7 DAYS PER WEEK, WHILE THE CAMPGROUND IS IN OPERATIONS, TO ADDRESS ANY EMERGENCY OR SECURITY CONCERNS.

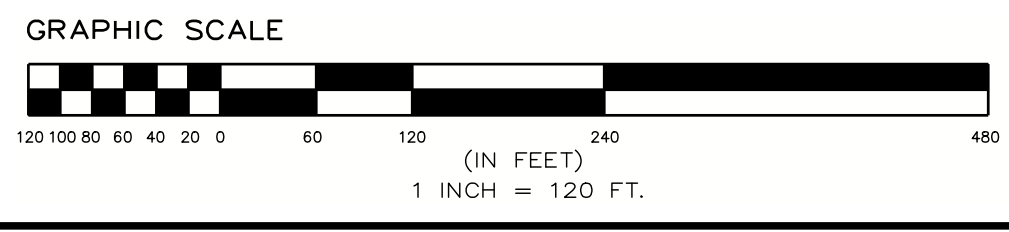

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 P2022-0008


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2	7/21/22	TAM	SUBMITTAL TO APA
3	8/16/22	TAM	SUBMITTAL TO APA AND DOH

SCALE: 1" = 50'

NOT FOR CONSTRUCTION

SHEET TITLE:
GRADING AND DRAINAGE PLAN

SHEET:
4 of 19

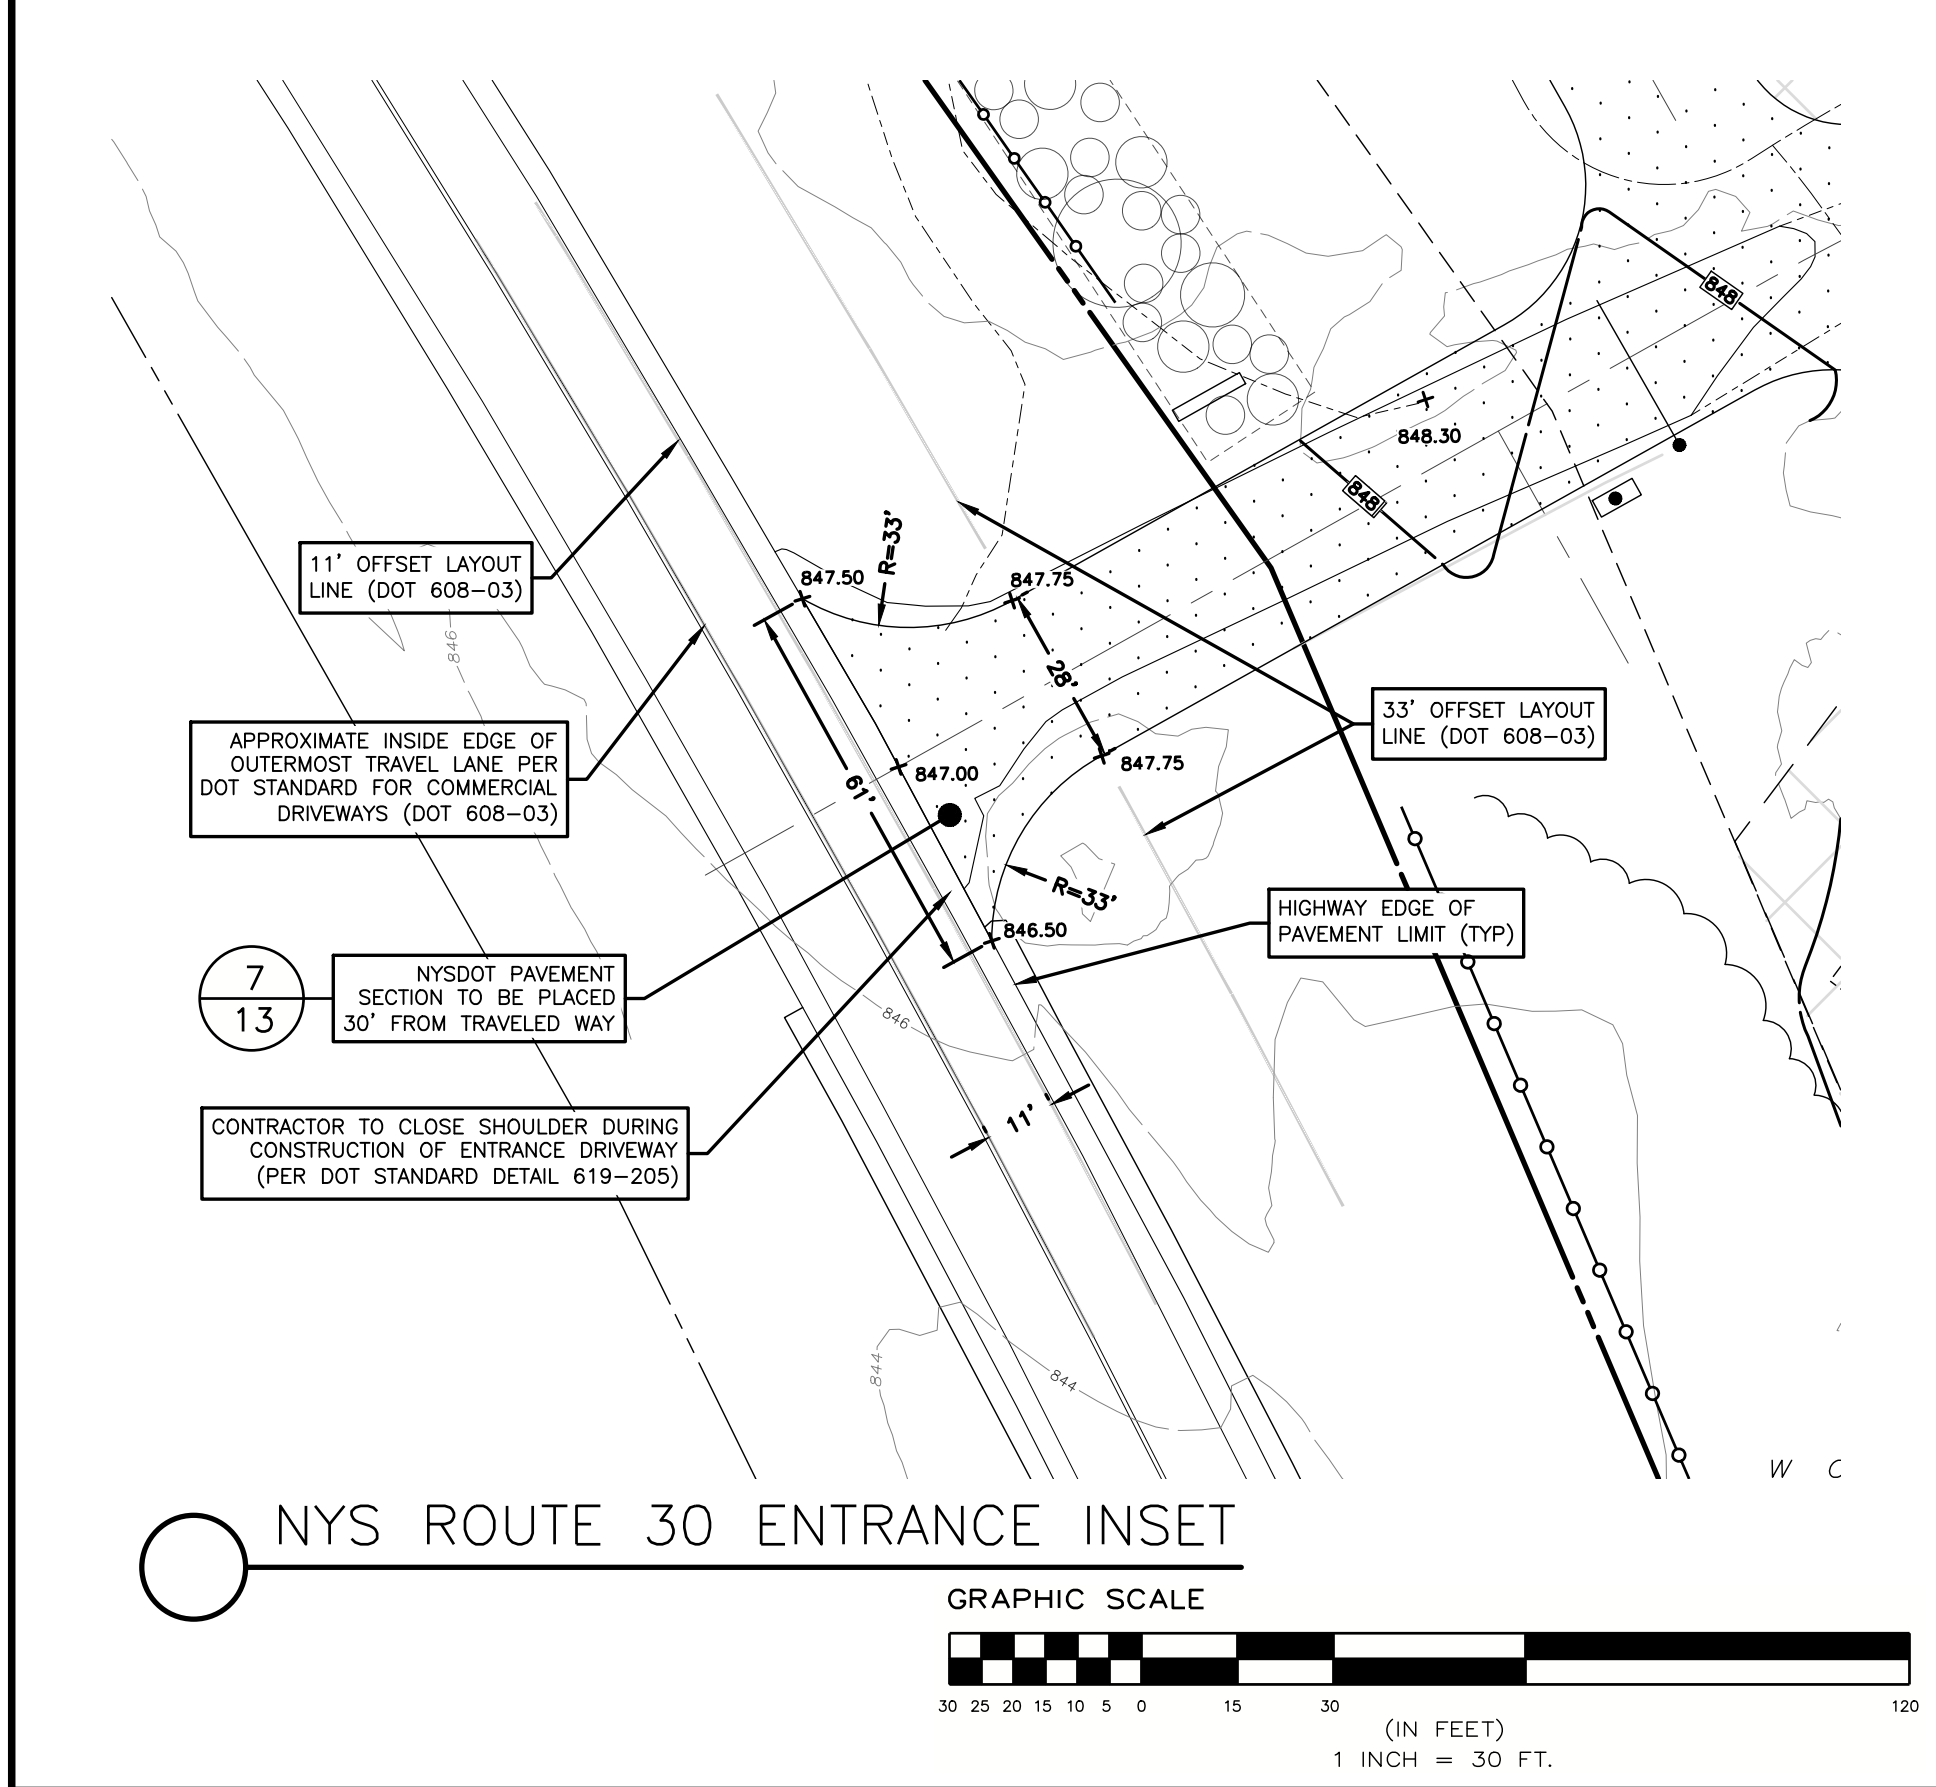

GRADING PLAN LEGEND:


- DENOTES USACE WETLAND AREA
- DENOTES APA BLUELINE
- DENOTES RV LOTS
- DENOTES GLAMPING LOTS
- DENOTES TENT CAMPING LOTS
- DENOTES DRYWELL
- DENOTES RIP-RAP OVERFLOW WEIR (ELEVATION 1/16)
- DENOTES PROPOSED SPOT ELEVATION (ELEVATION 6/16)
- DENOTES EXISTING CONTOUR (ELEVATION 1/16)
- DENOTES PROPOSED CONTOUR (ELEVATION 1/16)

FINAL
 P2022-0008

Adirondack Park Agency

GRAPHIC SCALE
 1" = 50 FT.

SHEET 4
 SHEET 7

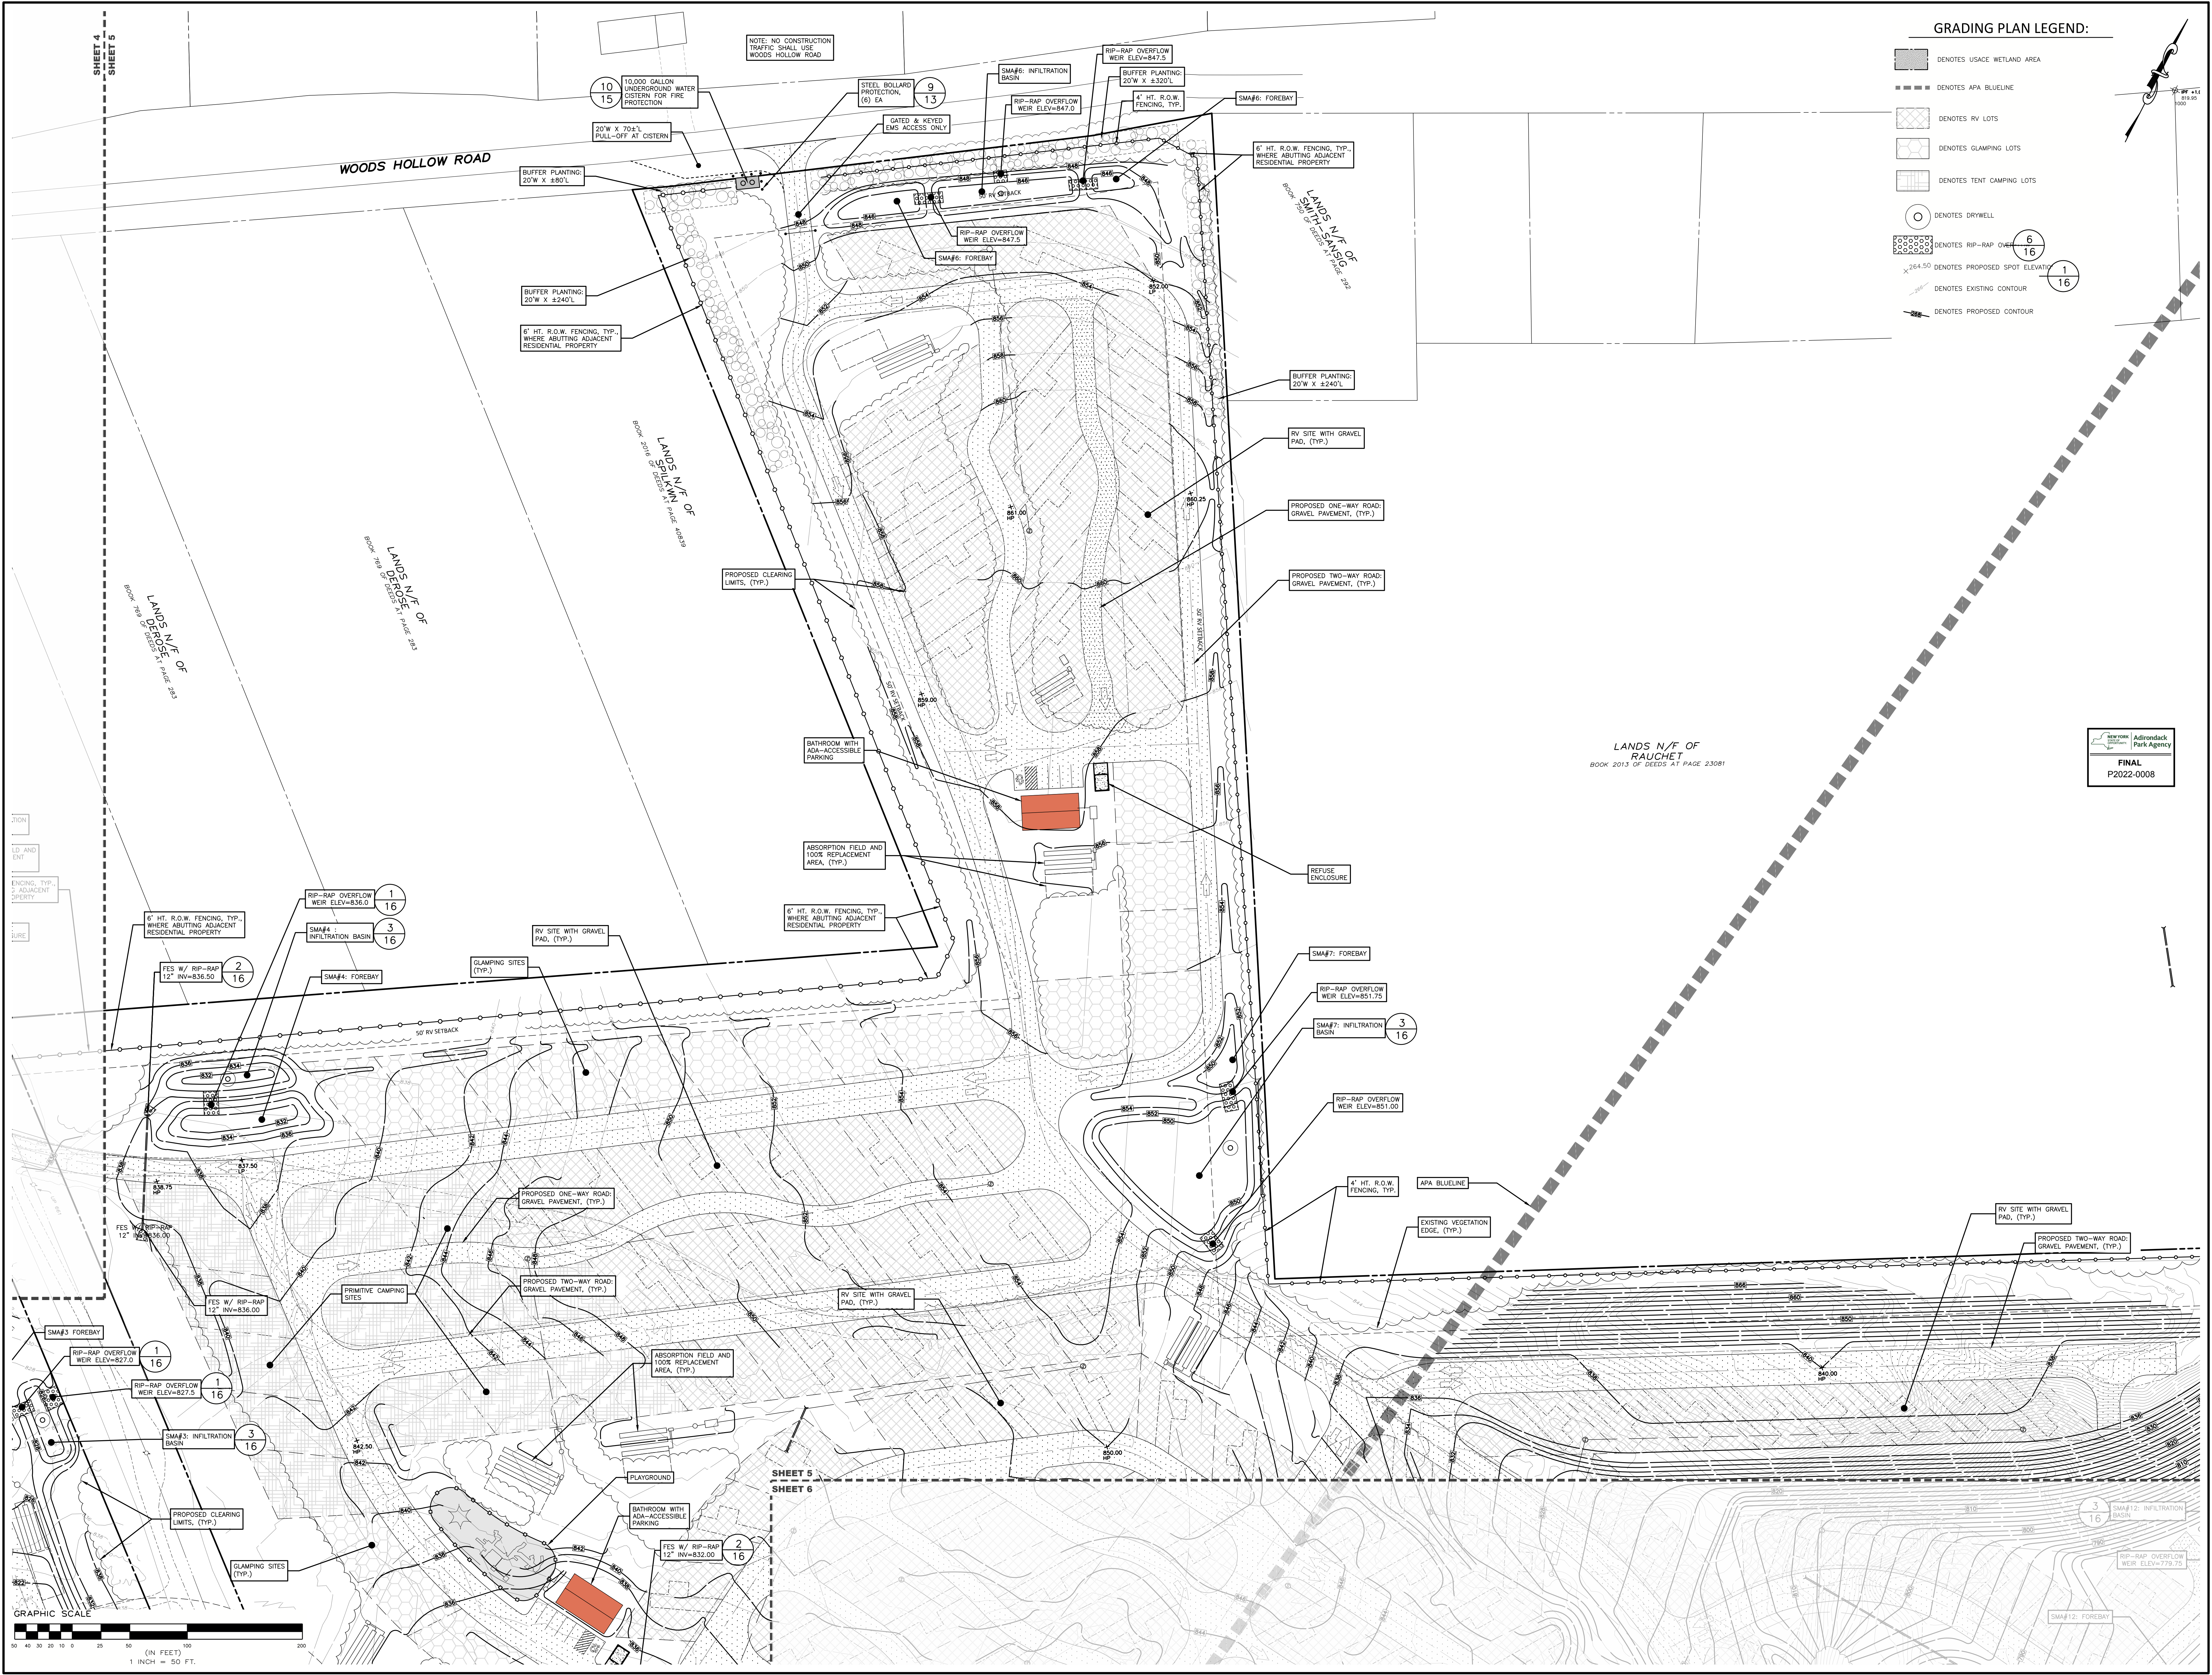


GRADING PLAN LEGEND:

- DENOTES USACE WETLAND AREA
- DENOTES APA BLUELINE
- DENOTES RV LOTS
- DENOTES GLAMPING LOTS
- DENOTES TENT CAMPING LOTS
- DENOTES DRYWELL
- DENOTES RIP-RAP OVERFLOW WEIR (16)
- DENOTES PROPOSED SPOT ELEVATION (16)
- DENOTES EXISTING CONTOUR
- DENOTES PROPOSED CONTOUR


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CHECKED BY	DATE
REV. PROJECT NUMBER	DATE

REVISION	DATE	BY
REVIEW FOR MUNICIPAL COMMENTS	7/20/22	LM
SUBMITTED TO APA AND DOH	8/18/22	LM

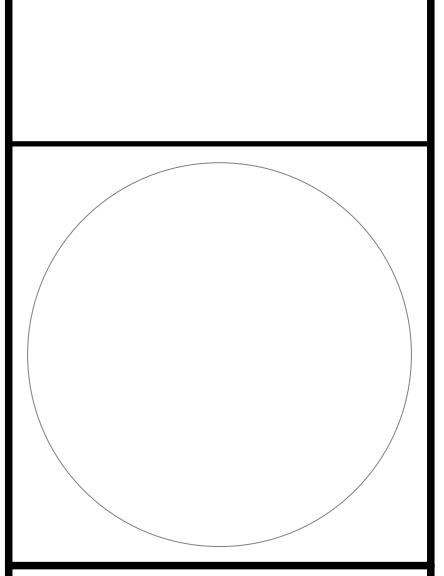

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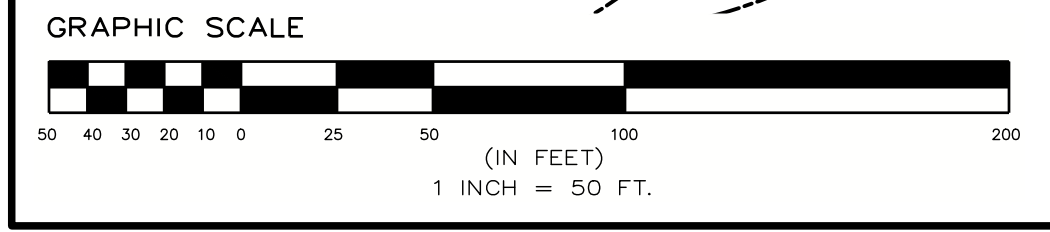


**RV PARK FOR
 WOODS HOLLOW CAMPGROUND**
 WOODS HOLLOW MINING COMPANY
 WOODS HOLLOW ROAD
 TOWN OF MAYFIELD
 FULTON COUNTY, NEW YORK

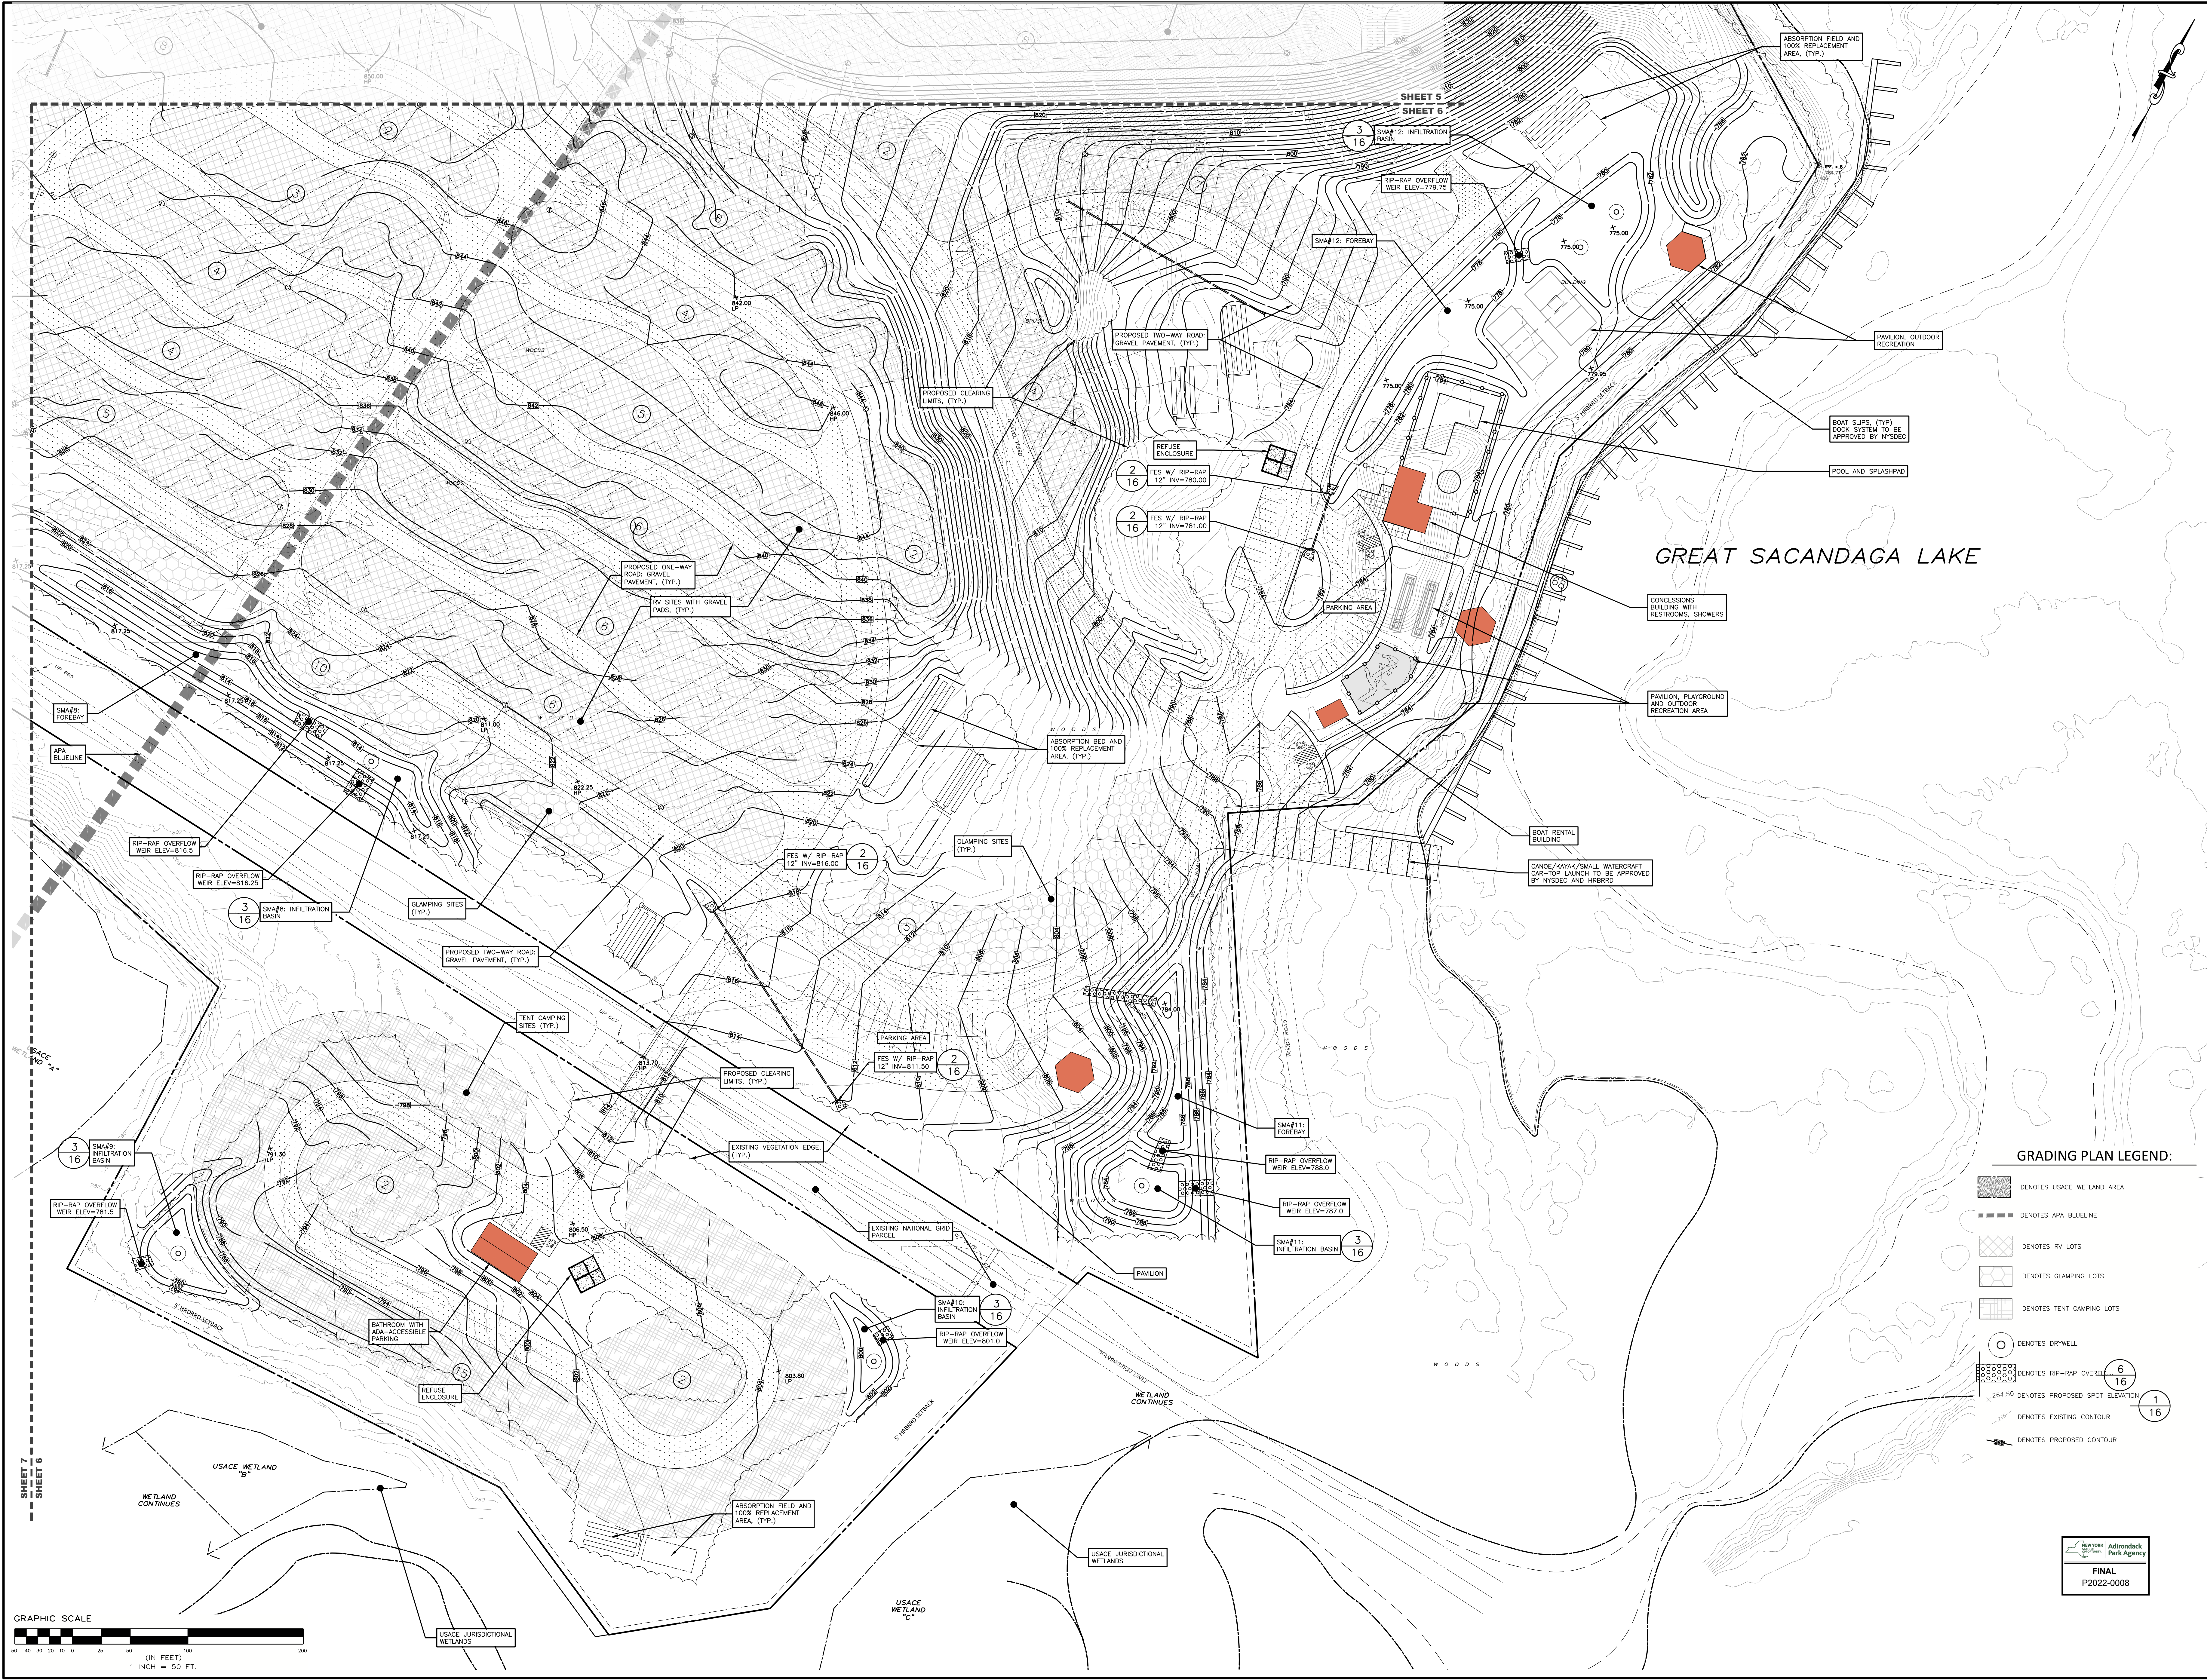DRAWN BY:	STA:
CHECKED BY:	DATE:
DATE:	DATE:
DATE:	DATE:

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REVISED FOR MUNICIPAL COMMENTS	7/20/22	LM
SUBMITTED TO APA	7/21/22	LM
SUBMITTED TO APA AND DOH	8/18/22	LM

- GRADING PLAN LEGEND:**
- DENOTES USACE WETLAND AREA
 - DENOTES APA BLUELINE
 - DENOTES RV LOTS
 - DENOTES GLAMPING LOTS
 - DENOTES TENT CAMPING LOTS
 - DENOTES DRYWELL
 - DENOTES RIP-RAP OVERFLOW WEIR ELEVATION
 - DENOTES EXISTING CONTOUR
 - DENOTES PROPOSED CONTOUR




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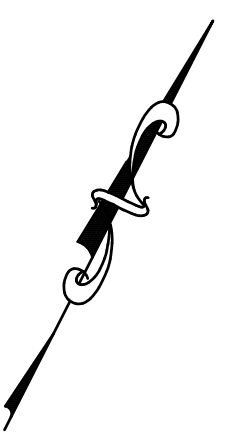
© FULTON COUNTY, NEW YORK. WOODS HOLLOW CAMPGROUND. PLOTTED FROM SHEETS 108, 109, 110, 199, 200. Sep 28, 2022 09:43:09AM

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PROJECT NUMBER	148201	
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REVISED FOR MUNICIPAL COMMENTS	7/20/21	T.M.
SUBMITTAL TO APA	7/21/22	T.M.
SUBMITTAL TO APA AND DOH	9/16/22	T.M.

SCALE:	1" = 50'
NOT FOR CONSTRUCTION	
SHEET TITLE:	GRADING AND DRAINAGE PLAN
SHEET:	7 of 19


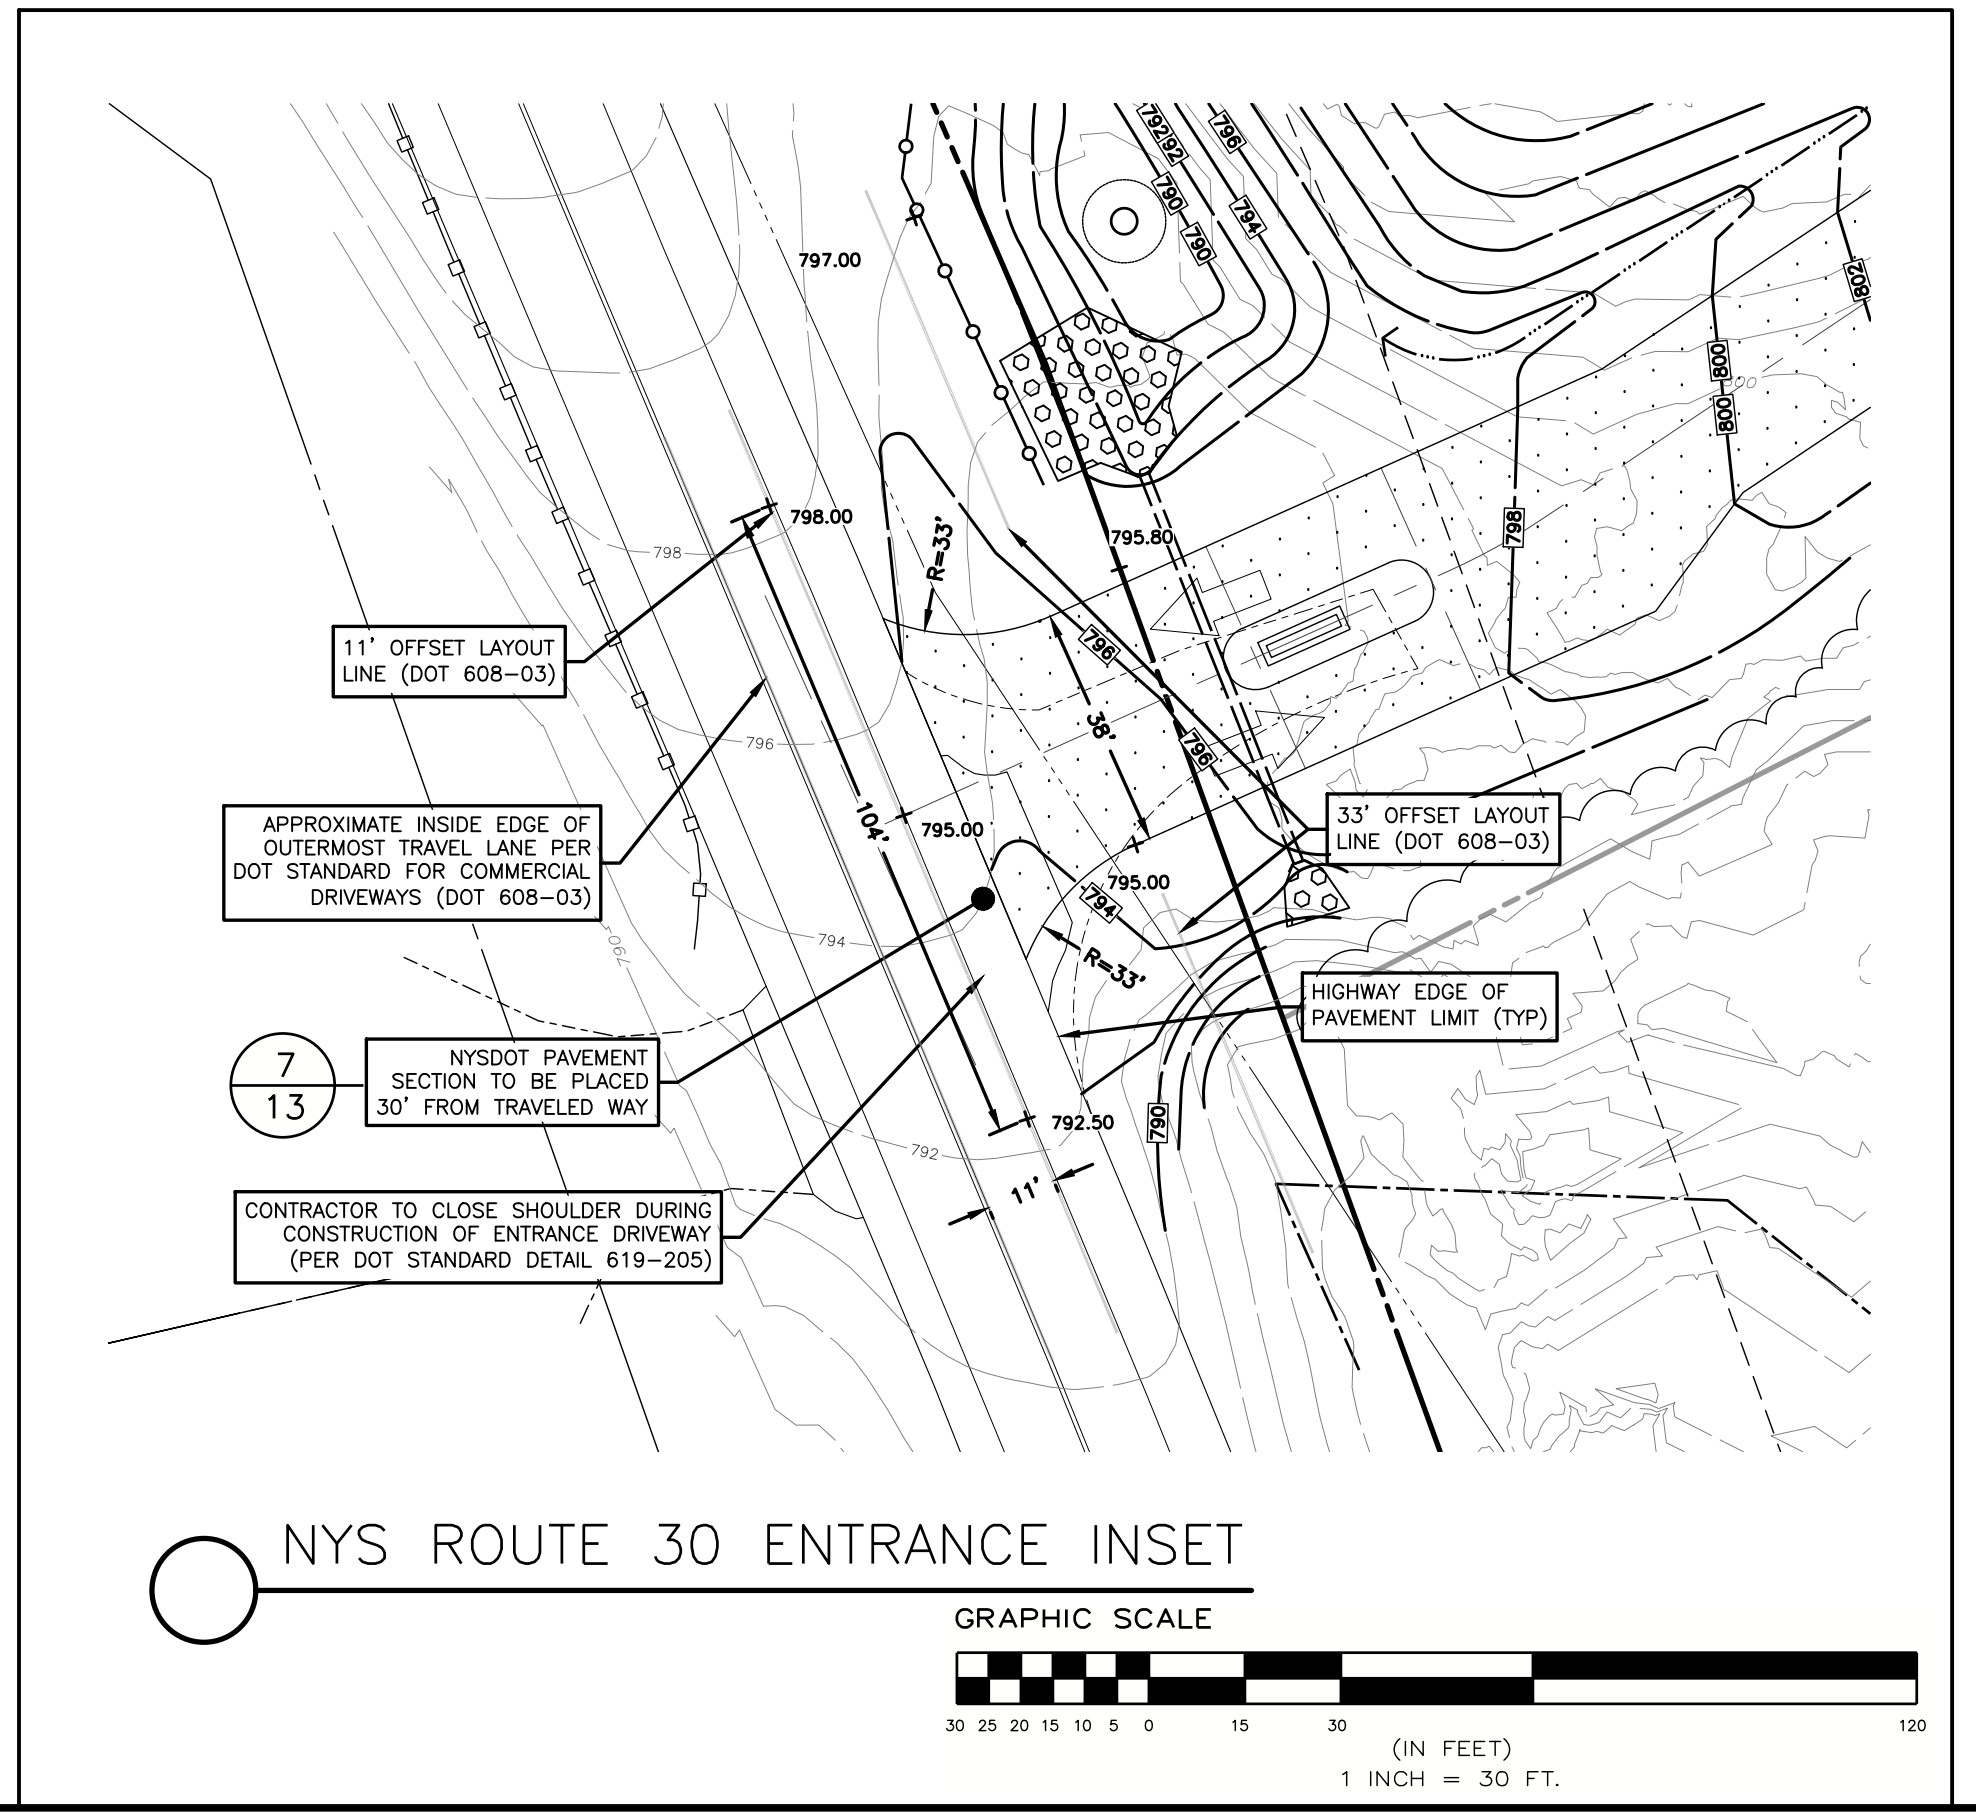


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 P2022-0008



GRADING PLAN LEGEND:

- DENOTES USACE WETLAND AREA
- DENOTES APA BLUELINE
- DENOTES RV LOTS
- DENOTES GLAMPING LOTS
- DENOTES TENT CAMPING LOTS
- DENOTES DRYWELL
- DENOTES RIP-RAP OVERFLOW WEIR
- DENOTES PROPOSED SPOT ELEVATION
- DENOTES EXISTING CONTOUR
- DENOTES PROPOSED CONTOUR

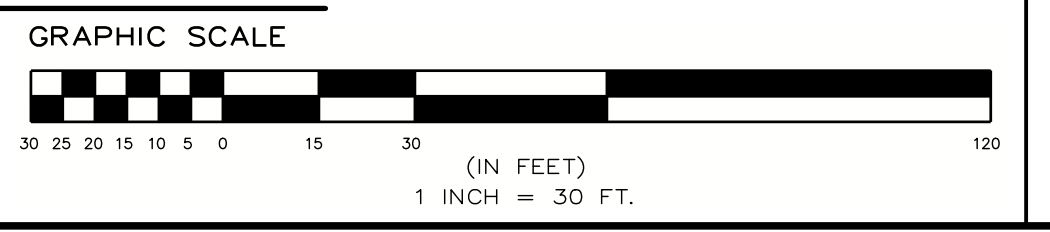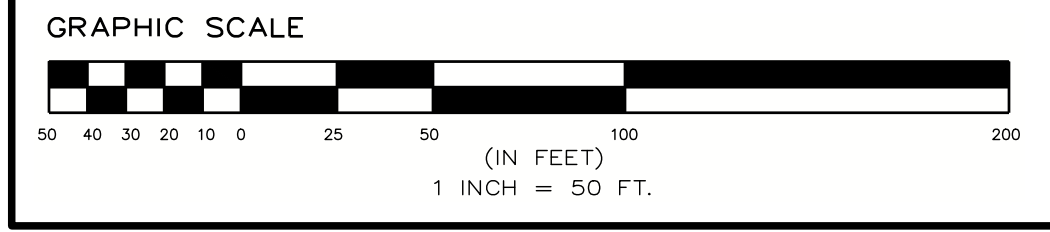

**RV PARK FOR
WOODS HOLLOW MINING COMPANY**
WOODS HOLLOW ROAD
TOWN OF MAYFIELD
FULTON COUNTY, NEW YORK

NO.	DATE	BY	REVISION
1	7/20/22	MM	ISSUED FOR MUNICIPAL COMMENTS
2	7/21/22	MM	SUBMITTAL TO APA AND DOH

NO.	DATE	BY	REVISION

NO.	DATE	BY	REVISION

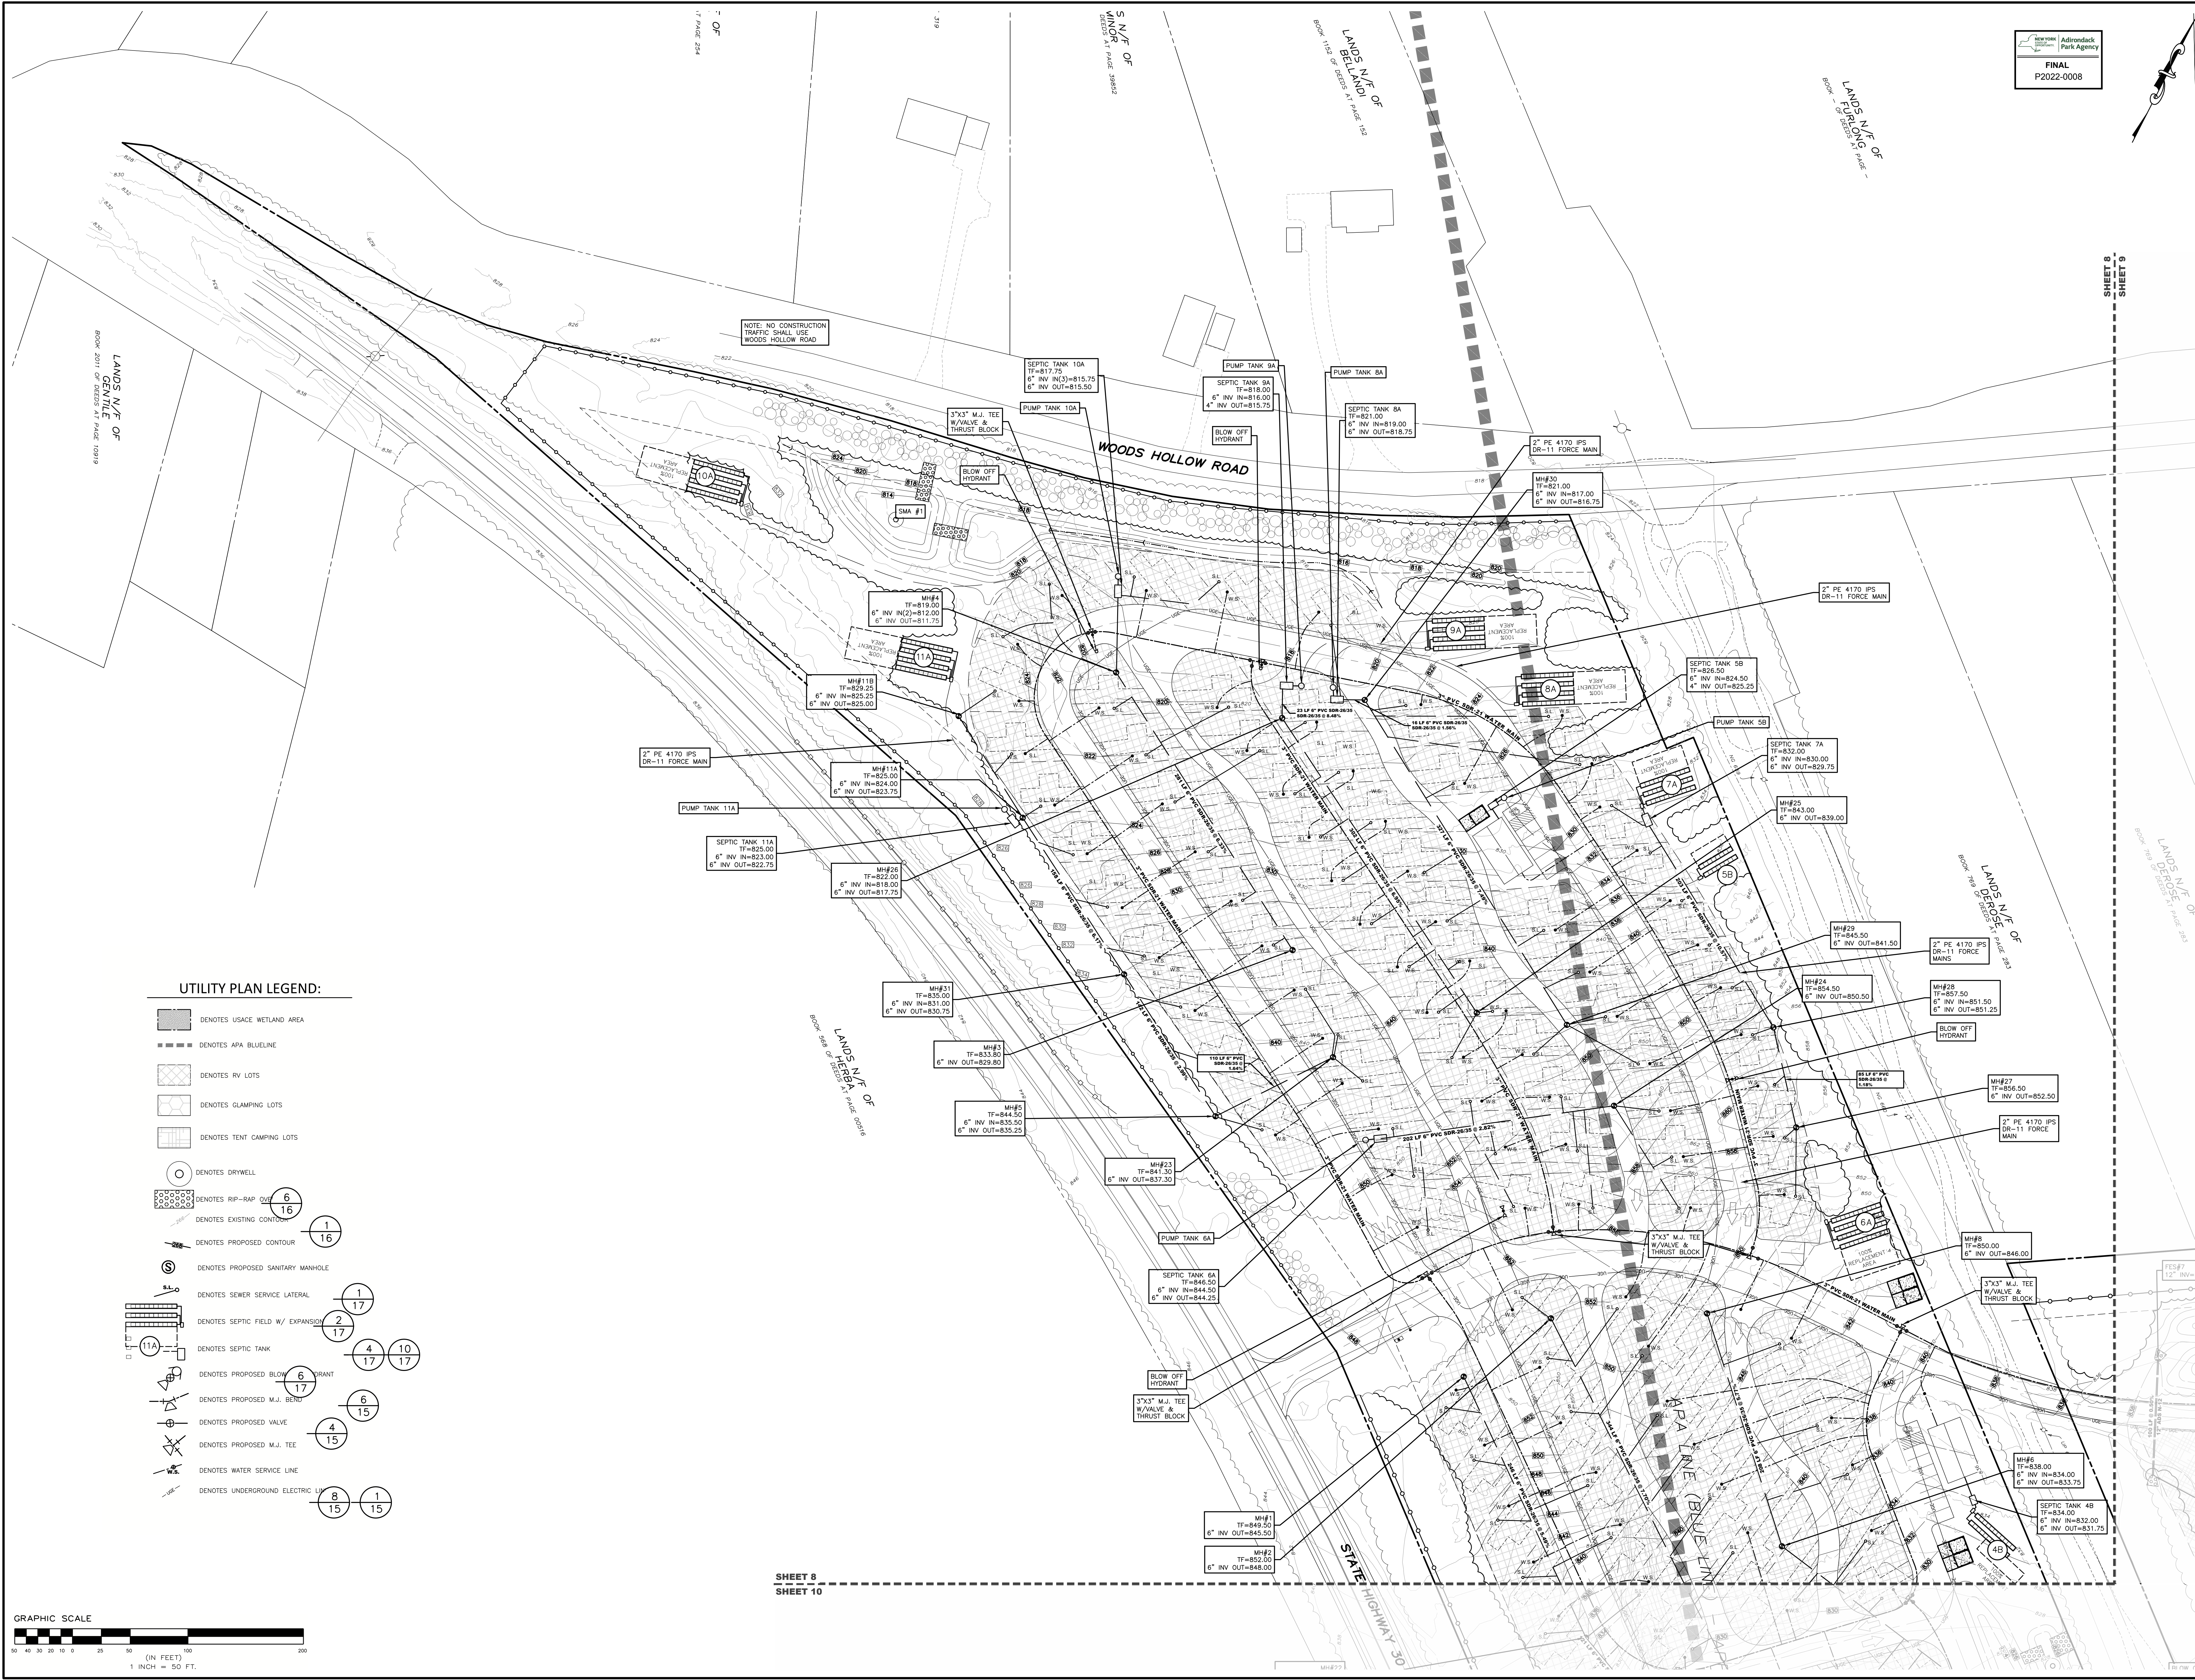

UTILITY PLAN LEGEND:

- DENOTES USACE WETLAND AREA
- DENOTES APA BLUELINE
- DENOTES RV LOTS
- DENOTES GLAMPING LOTS
- DENOTES TENT CAMPING LOTS
- DENOTES DRYWELL
- DENOTES RIP-RAP
- DENOTES EXISTING CONTOUR
- DENOTES PROPOSED CONTOUR
- DENOTES PROPOSED SANITARY MANHOLE
- DENOTES SEWER SERVICE LATERAL
- DENOTES SEPTIC FIELD W/ EXPANSION
- DENOTES SEPTIC TANK
- DENOTES PROPOSED BLOW OFF HYDRANT
- DENOTES PROPOSED M.J. BENT
- DENOTES PROPOSED VALVE
- DENOTES PROPOSED M.J. TEE
- DENOTES WATER SERVICE LINE
- DENOTES UNDERGROUND ELECTRIC UN

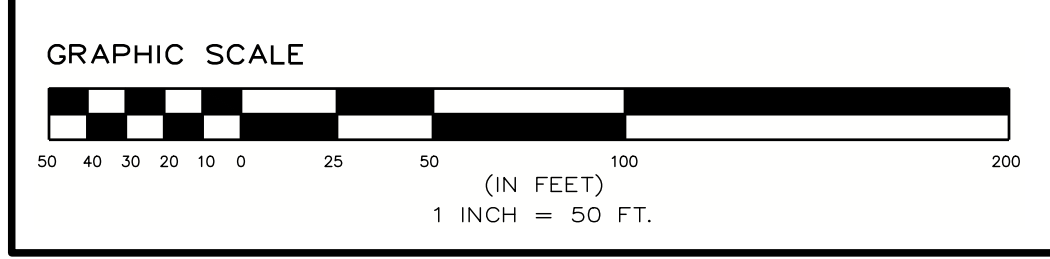

SHEET 8
SHEET 10

SHEET 8
SHEET 9

© 2022 WATFIELD Woods Hollow Road 170 - Winery/UG map/Shared Plans/SHEETS/07-Utility/Woods Hollow Road.dwg Sep 28, 2022 09:43:33AM

WOODS HOLLOW ROAD



NOTE: NO CONSTRUCTION TRAFFIC SHALL USE WOODS HOLLOW ROAD


UTILITY PLAN LEGEND:

- DENOTES USAGE WETLAND AREA
- DENOTES APA BLUELINE
- DENOTES RV LOTS
- DENOTES GLAMPING LOTS
- DENOTES TENT CAMPING LOTS
- DENOTES DRYWELL
- DENOTES RIP-RAP OVER 6
16
- DENOTES EXISTING CONTOUR 1
16
- DENOTES PROPOSED CONTOUR 1
16
- DENOTES PROPOSED SANITARY MANHOLE
- DENOTES SEWER SERVICE LATERAL 1
17
- DENOTES SEPTIC FIELD W/ EXPANSION 2
17
- DENOTES SEPTIC TANK 4
17 10
17
- DENOTES PROPOSED BLOW OFF HYDRANT 6
17
- DENOTES PROPOSED M.J. BEND 6
15
- DENOTES PROPOSED VALVE 4
15
- DENOTES PROPOSED M.J. TEE 4
15
- DENOTES WATER SERVICE LINE
- DENOTES UNDERGROUND ELECTRIC LINE 8
15 1
15

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REVISION:	DATE:	BY:
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SUBMITTAL TO APA	7/21/22	TM
SUBMITTAL TO APA AND DOH	9/16/22	TM



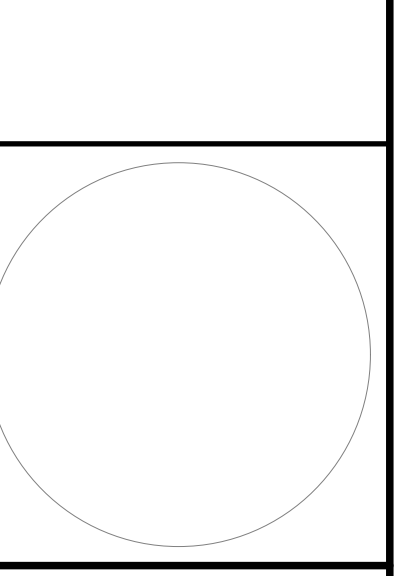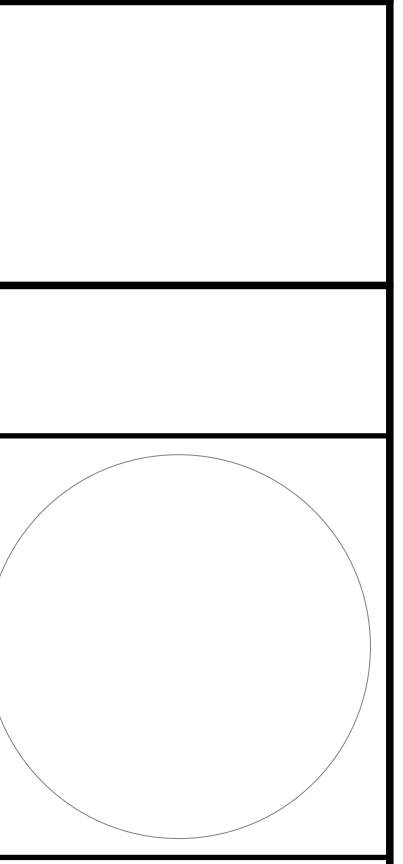


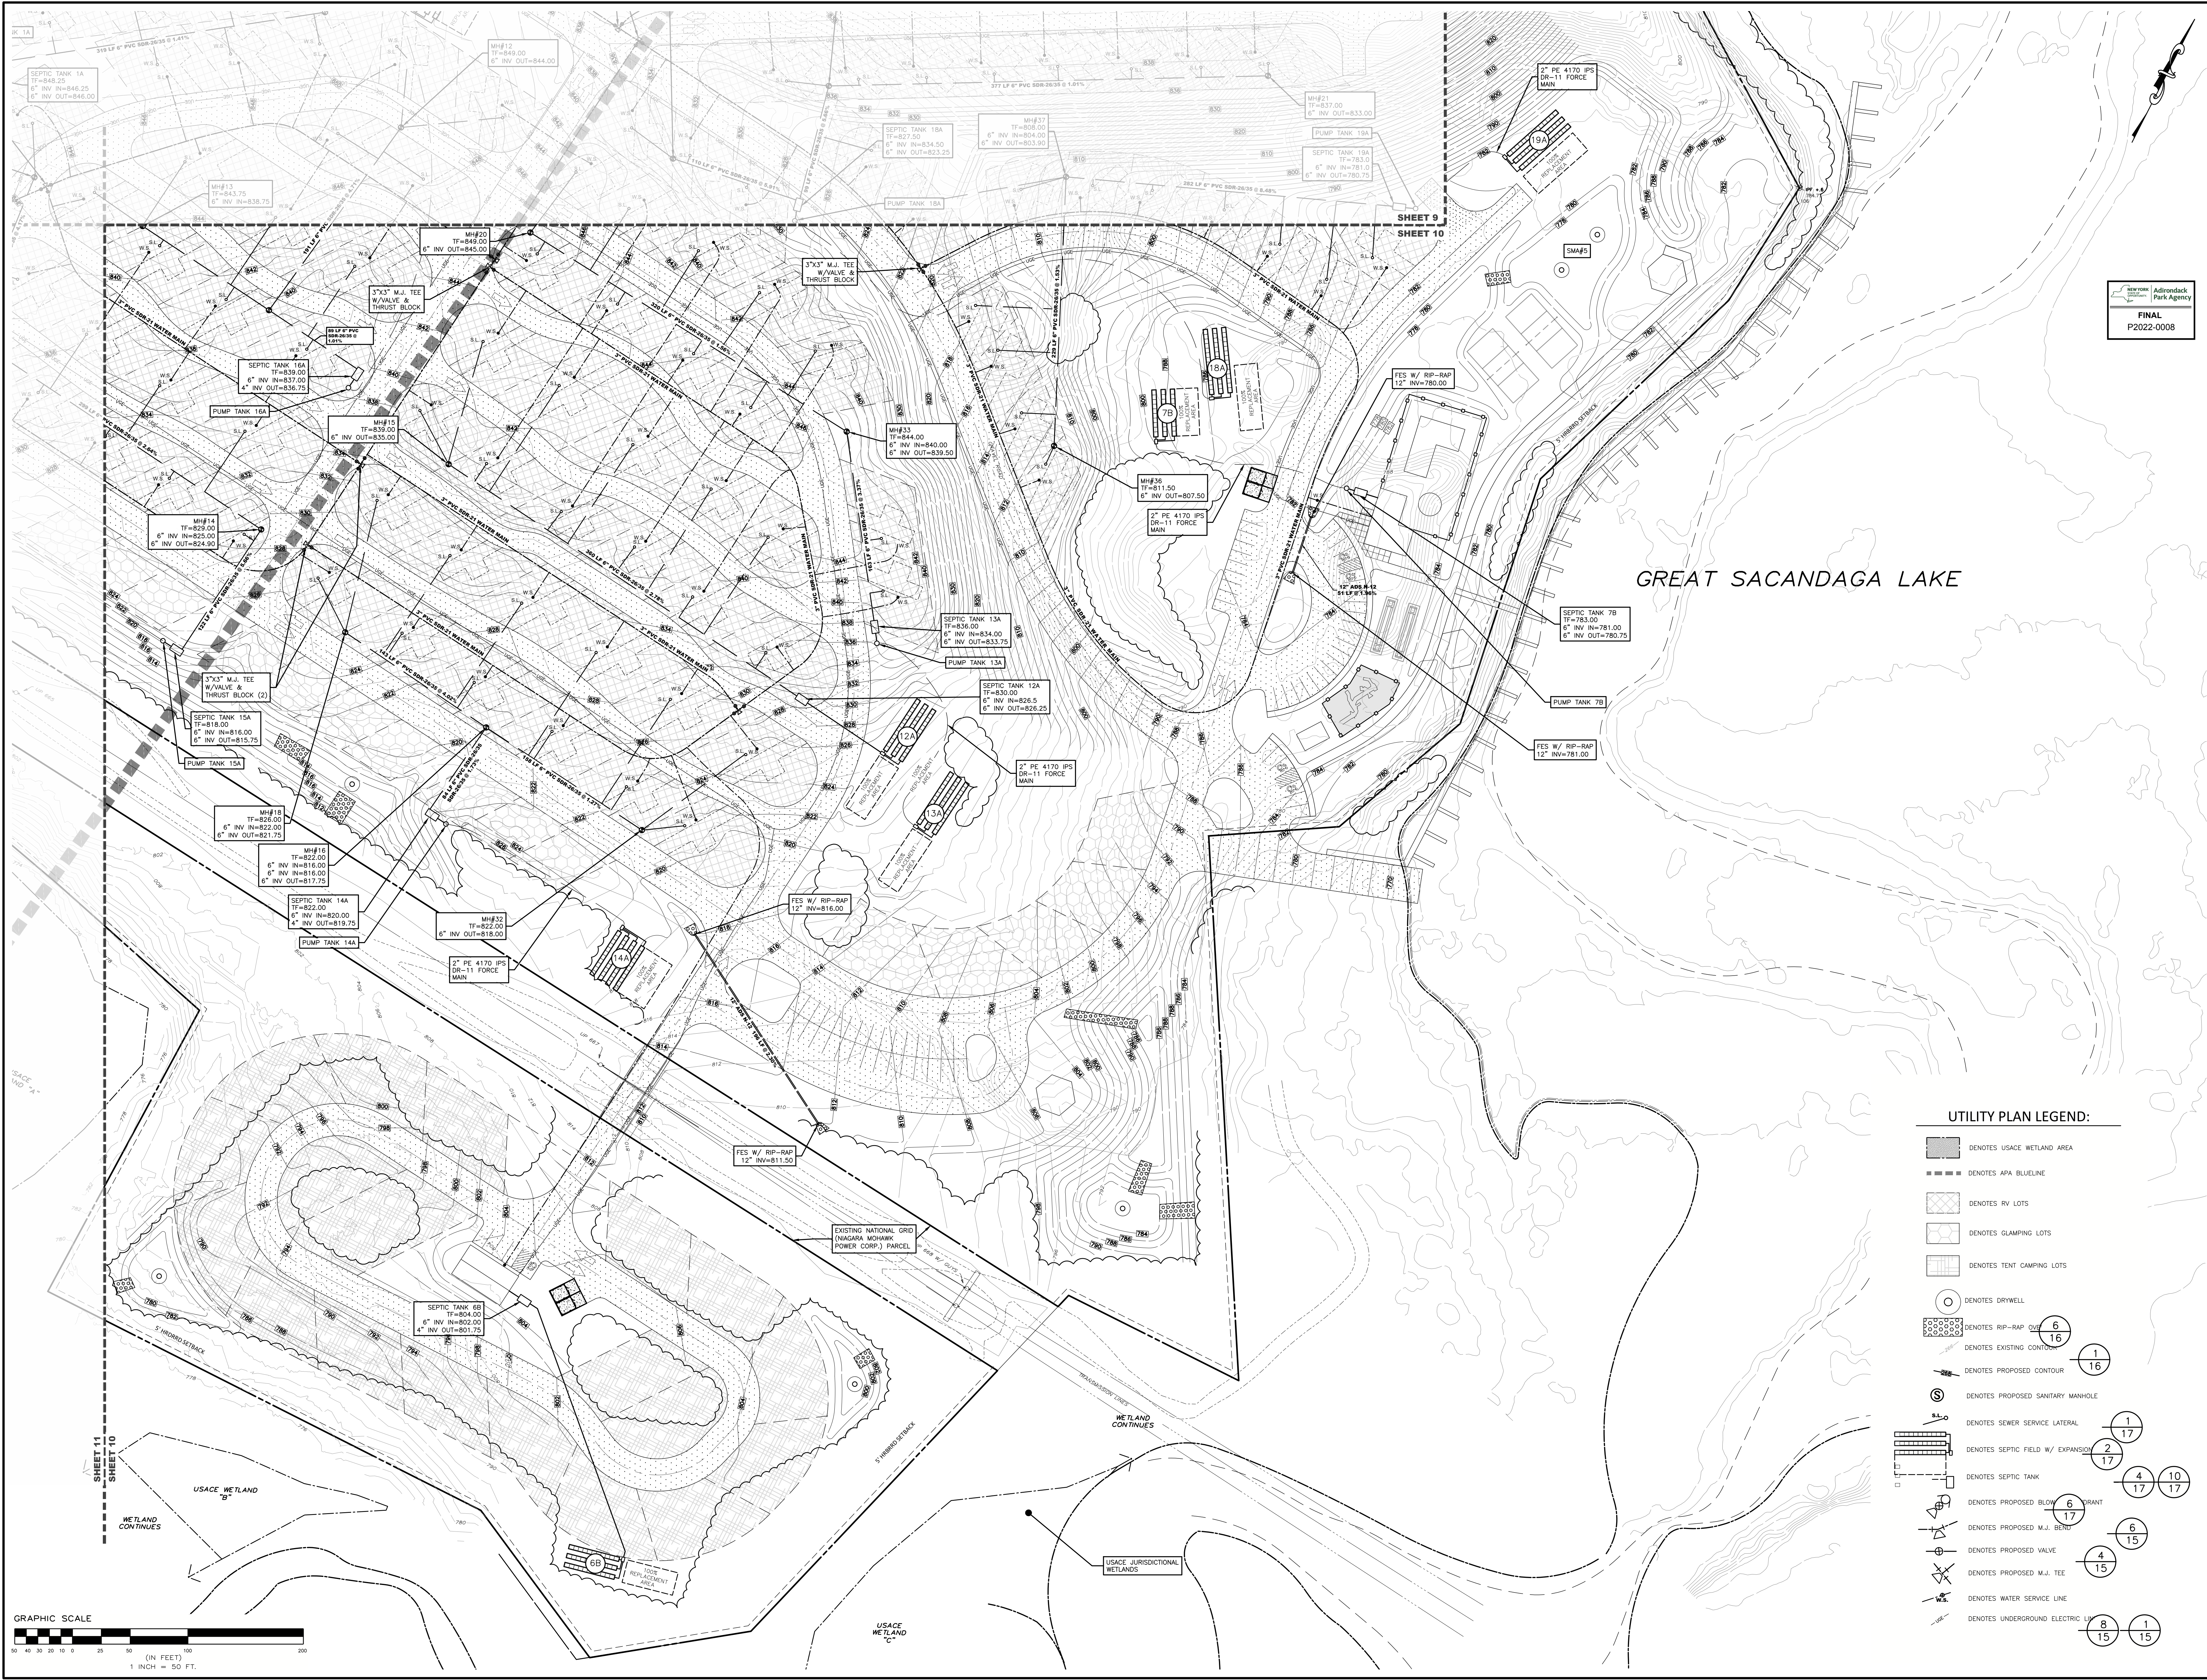FINAL
P2022-0008

GREAT SACANDAGA LAKE

UTILITY PLAN LEGEND:

- DENOTES USACE WETLAND AREA
- DENOTES APA BLUELINE
- DENOTES RV LOTS
- DENOTES CLAMPING LOTS
- DENOTES TENT CAMPING LOTS
- DENOTES DRYWELL
- DENOTES RIP-RAP
- DENOTES EXISTING CONTOUR
- DENOTES PROPOSED CONTOUR
- DENOTES PROPOSED SANITARY MANHOLE
- DENOTES SEWER SERVICE LATERAL
- DENOTES SEPTIC FIELD W/ EXPANSION
- DENOTES SEPTIC TANK
- DENOTES PROPOSED BLOW OFF
- DENOTES PROPOSED M.J. BEND
- DENOTES PROPOSED VALVE
- DENOTES PROPOSED M.J. TEE
- DENOTES WATER SERVICE LINE
- DENOTES UNDERGROUND ELECTRIC LINE

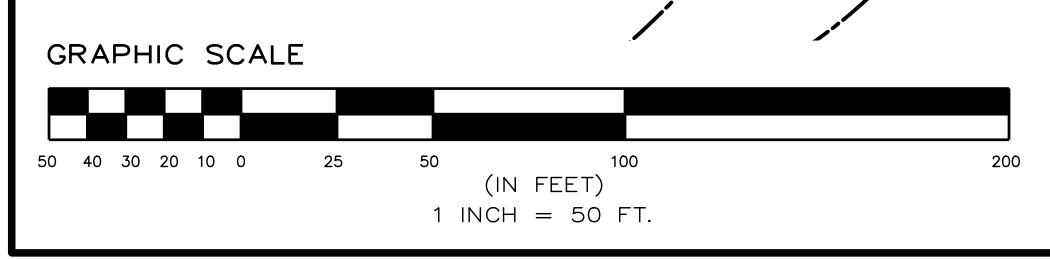

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CHECKED BY:	DATE:
PROJECT NUMBER:	148201


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REVISION FOR REVISION COMMENTS 7/20/22 TAM
SUBMITAL TO APA 7/21/22 TAM
SUBMITAL TO APA AND DOH 8/18/22 TAM

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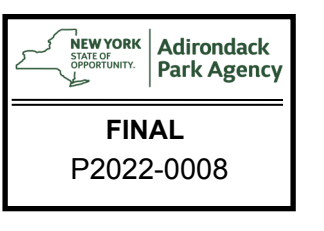
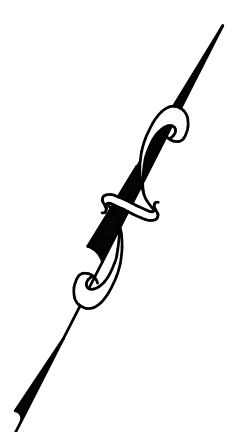
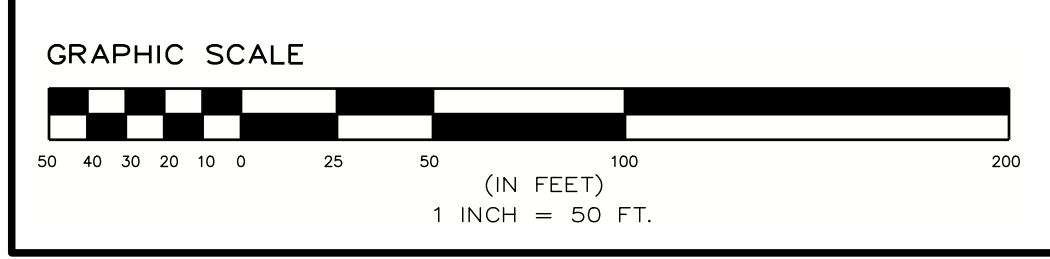
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REVISED FOR MUNICIPAL COMMENTS	7/20/22	TM
SUBMITTAL TO APA	7/21/22	TM
SUBMITTAL TO APA AND DOH	9/16/22	TM

SCALE:	1" = 50'
NOT FOR CONSTRUCTION	
SHEET TITLE:	UTILITY PLAN
SHEET:	11 of 19



UTILITY PLAN LEGEND:

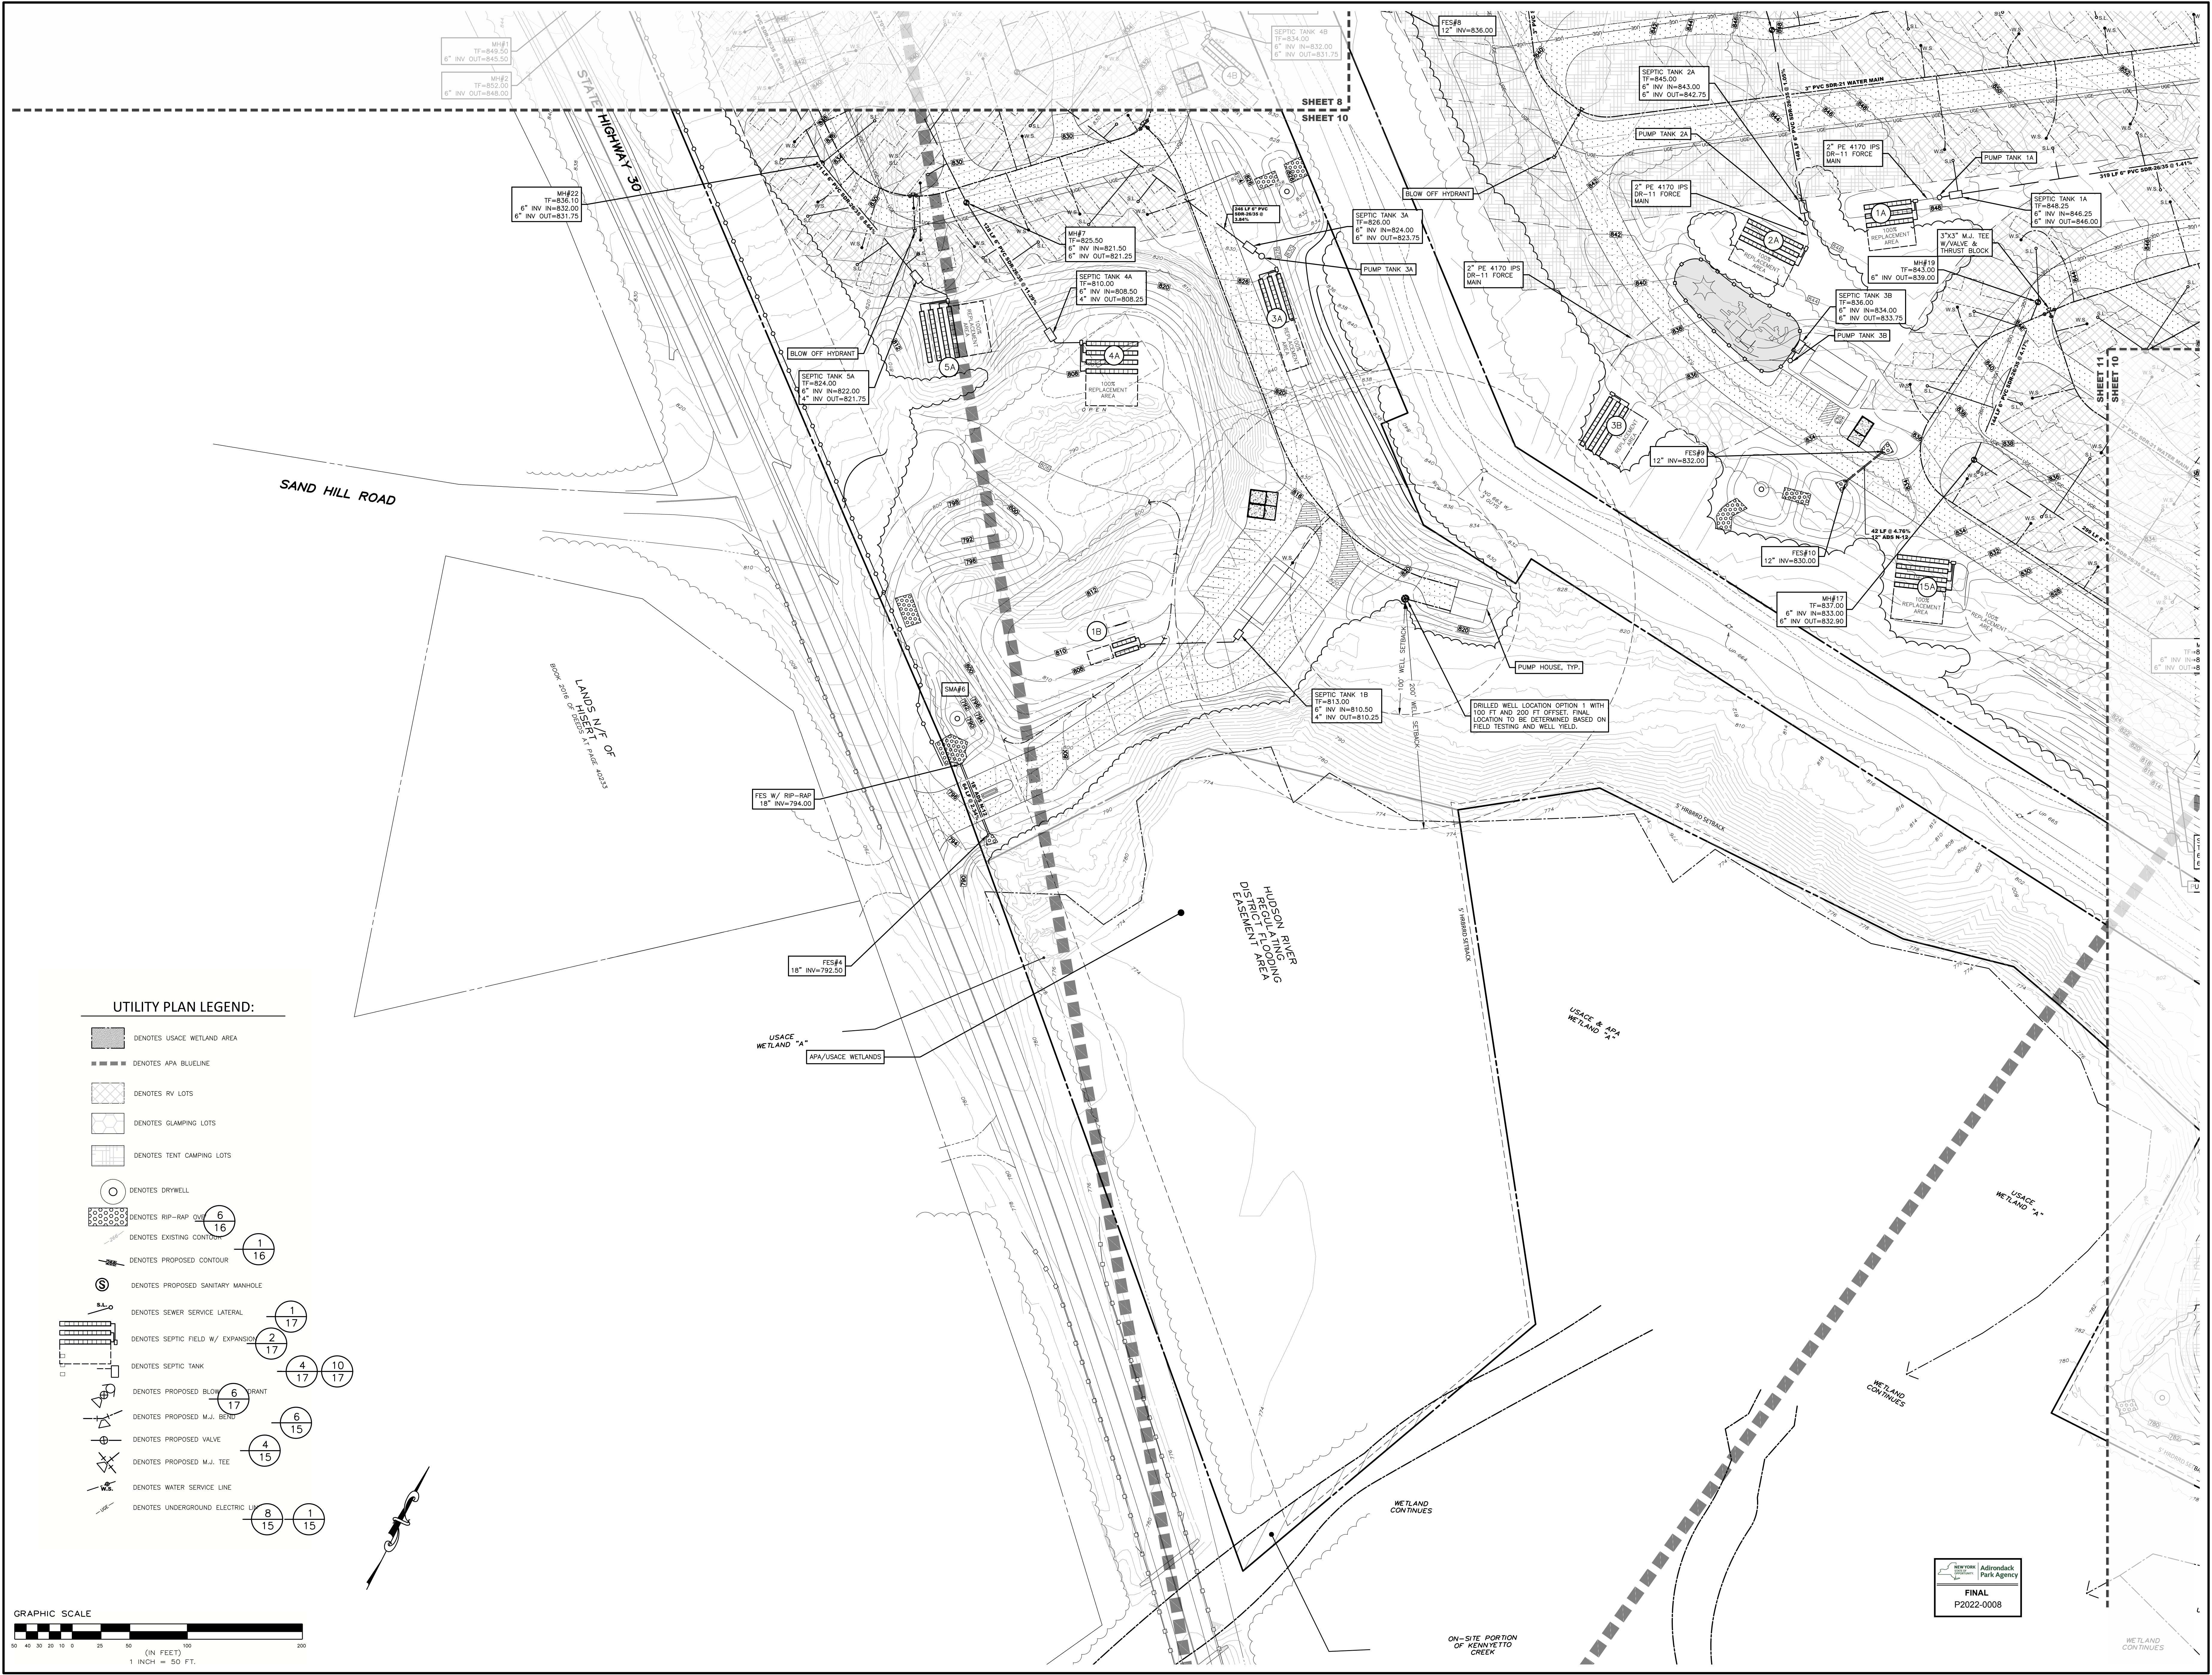- DENOTES USACE WETLAND AREA
- DENOTES APA BLUELINE
- DENOTES RV LOTS
- DENOTES GLAMPING LOTS
- DENOTES TENT CAMPING LOTS
- DENOTES DRYWELL
- DENOTES RIP-RAP
- DENOTES EXISTING CONTOUR
- DENOTES PROPOSED CONTOUR
- DENOTES PROPOSED SANITARY MANHOLE
- DENOTES SEWER SERVICE LATERAL
- DENOTES SEPTIC FIELD W/ EXPANSION
- DENOTES SEPTIC TANK
- DENOTES PROPOSED BLOW OFF HYDRANT
- DENOTES PROPOSED M.J. BEND
- DENOTES PROPOSED VALVE
- DENOTES PROPOSED M.J. TEE
- DENOTES WATER SERVICE LINE
- DENOTES UNDERGROUND ELECTRIC



GENERAL NOTES:

THE ENVIRONMENTAL DESIGN PARTNERSHIP IS NOT RESPONSIBLE FOR ANY CONSTRUCTION WORK PERFORMED PRIOR TO FINAL APPROVAL OF ALL PLANS AND SECURING OF ALL PERMITS AND FILING OF ALL MAPS.

EMPAKMENT SUBGRADE AREA (TWO FEET BELOW SUBGRADE ELEVATION) SHALL BE CONSTRUCTED IN ACCORDANCE WITH NYS DOT 230-2.02.B., SELECT BORROW AND SELECT FILL, COMPACTED PER 203-3.03.C.

CONTRACTOR TO ARRANGE A PRECONSTRUCTION CONFERENCE WITH THE ENVIRONMENTAL DESIGN PARTNERSHIP AND MUNICIPALITY PRIOR TO CONSTRUCTION.

ALL AREAS OF THE SUBGRADE SURFACE WITHIN THE ROADWAY OR OTHER PAVEMENT AREA LIMITS SHALL BE PROOF-ROLLED, WITH UNSTABLE AREAS CORRECTED TO THE SATISFACTION OF THE ENVIRONMENTAL DESIGN PARTNERSHIP AND MUNICIPALITY PRIOR TO CONSTRUCTION.

CONTRACTOR IS TO VERIFY THAT ALL NECESSARY WORK PERMITS AND EASEMENTS ARE IN PLACE PRIOR TO COMMENCEMENT OF WORK.

CONTRACTOR SHALL VERIFY THE ACCEPTABILITY OF ALL CONSTRUCTION MATERIALS WITH MUNICIPALITY'S ENGINEER PRIOR TO ORDERING.

INSTALLATION AND MATERIAL SPECIFICATIONS FOR STORM SEWER, SANITARY SEWER, WATER SERVICE CONNECTIONS SHALL CONFORM TO THE MUNICIPALITY'S STANDARD DETAILS AND REQUIREMENTS.

ALL PRESSURE SANITARY SEWER PIPE SHALL BE BURIED WITH TRACER WIRE SECURED TO THE PIPE WITH GORILLA TAPE. TRACER WIRE SHALL BE 12 AWG, SINGLE CONDUCTOR, HIGH STRENGTH, FLEXIBLE, STRANDED STAINLESS STEEL.

CONTRACTOR SHALL CLEAN UP THE JOB SITE DAILY BEFORE LEAVING THE JOB SITE. ALL RUBBISH MUST BE CLEANED UP AND CONSTRUCTION EQUIPMENT MUST BE PROPERLY TAKEN CARE OF AND STORED AT THE END OF THE DAY.

WHERE MINIMUM SEPARATIONS CANNOT BE MET, WITH CASE-BY-CASE APPROVAL FROM NYS DOH: NEW SEWERS SHALL BE CONSTRUCTED OF MIN. PR 150 PSI AWWA WATER GRADE MATERIALS.

CONTRACTOR SHALL RESTORE ALL LAWS, DRIVEWAYS, WALKS, CURBS, FENCES, ETC. TO A CONDITION AT LEAST AS GOOD AS THEY WERE BEFORE BEING DISTURBED.

ALL PLASTIC WATER MAIN AND WATER SERVICE TUBING SHALL BE BURIED WITH TRACER WIRE SECURED TO THE PIPE WITH GORILLA TAPE. BLUE-COLORED #10 BY KRIS-TECH WIRE CO. MAIN BRANCHES AND SERVICE CONNECTIONS SHALL BE MADE WITHOUT CUTTING THE MAIN WIRE.

CONTRACTOR TO COMPLY WITH ALL OSHA AND OTHER STATE AND LOCAL SAFETY REQUIREMENTS DURING CONSTRUCTION (PIPE SHORING, ETC.).

THE INFORMATION REPRESENTED WITHIN THESE DOCUMENTS DOES NOT IMPLY ANY CONTRACT WITH OR OBLIGATION FOR, PERFORMING ANY OR ALL TOWN, COUNTY, OR STATE REQUIRED INSPECTIONS DURING THE COURSE OF CONSTRUCTION OR PURSUANT TO OBTAINING CERTIFICATE OF OCCUPANCY.

PROVISIONS FOR STORMWATER COLLECTION AND DRAINAGE PERTAINING TO THE ROOF AND TO PHYSICAL FEATURES WITHIN THE FEET OF THE EXTERIOR BUILDING WALLS AND CANOPY OVERHANGS ARE THE RESPONSIBILITY OF THE ARCHITECT.

INSPECTION SERVICES BY THE ENVIRONMENTAL DESIGN PARTNERSHIP ARE NOT SUPERVISORY ACCORDINGLY, THE ENVIRONMENTAL DESIGN PARTNERSHIP CAN NEITHER GUARANTEE THE PERFORMANCE OF THE CONSTRUCTION CONTRACTS BY CONTRACTORS NOR ASSUME RESPONSIBILITY FOR THE CONTRACTOR'S FAILURE TO PERFORM WORK IN ACCORDANCE WITH THE CONTRACT DOCUMENTS.

ROADWAYS AND UNDERGROUND UTILITY FILL AREAS SHALL BE CONTROLLED FILLS PREPARED IN GENERAL ACCORDANCE WITH NYS DOT STANDARD SPECIFICATIONS 203, EXCAVATION AND EMPAKMENT.
























CONTRACTOR SHALL OBTAIN A PERMIT FROM SARATOGA COUNTY SEWER DISTRICT NO. 1 PRIOR TO CONSTRUCTION OF ANY PROPOSED SANITARY SEWER LINES AND FOLLOW ALL PERMIT PROCEDURES DURING CONSTRUCTION.

CONTRACTOR SHALL VERIFY THAT ALL NECESSARY WORK PERMITS AND EASEMENTS ARE IN PLACE PRIOR TO COMMENCEMENT OF WORK.

CONTRACTOR SHALL VERIFY THE ACCEPTABILITY OF ALL CONSTRUCTION MATERIALS WITH MUNICIPALITY'S ENGINEER PRIOR TO ORDERING.

CONTRACTOR SHALL RESTORE ALL LAWS, DRIVEWAYS, WALKS, CURBS, FENCES, ETC. TO A CONDITION AT LEAST AS GOOD AS THEY WERE BEFORE BEING DISTURBED.

CONTRACTOR SHALL RESTORE ALL LAWS, DRIVEWAYS, WALKS, CURBS, FENCES, ETC. TO A CONDITION AT LEAST AS GOOD AS THEY WERE BEFORE BEING DISTURBED.

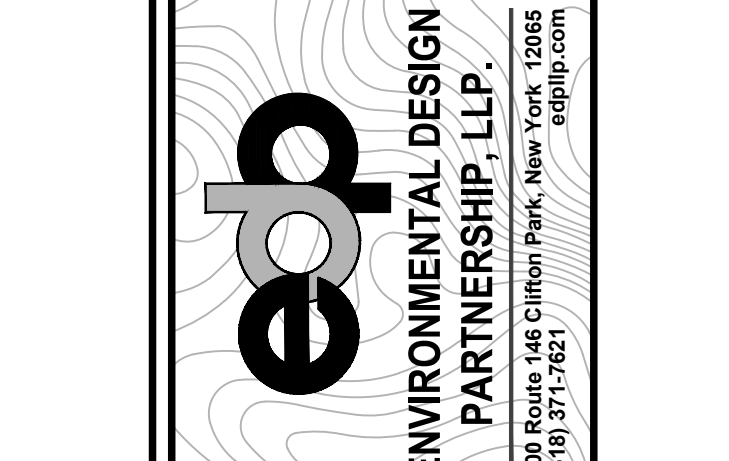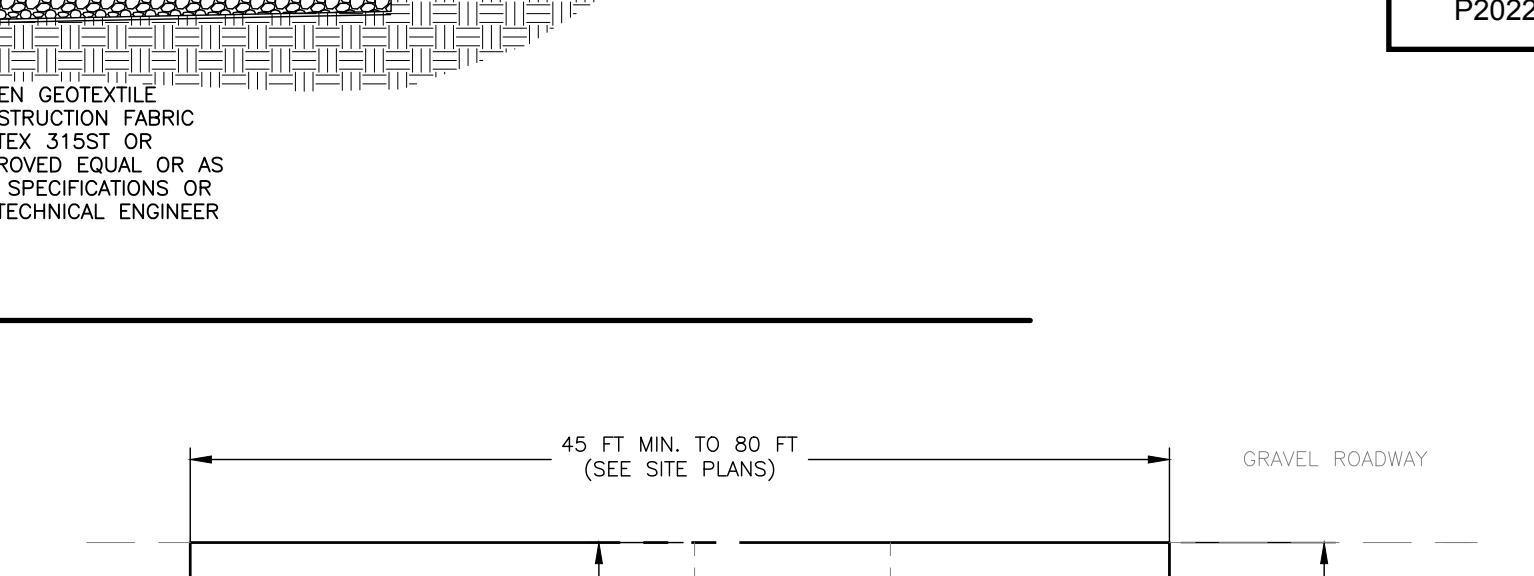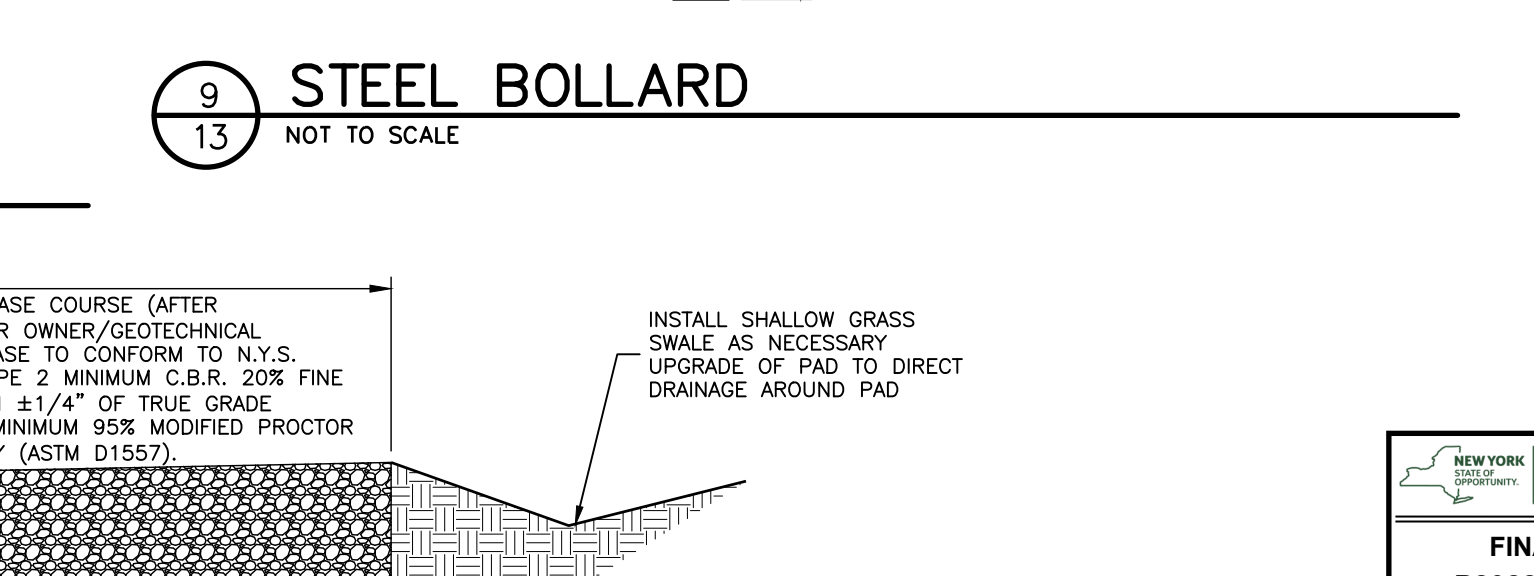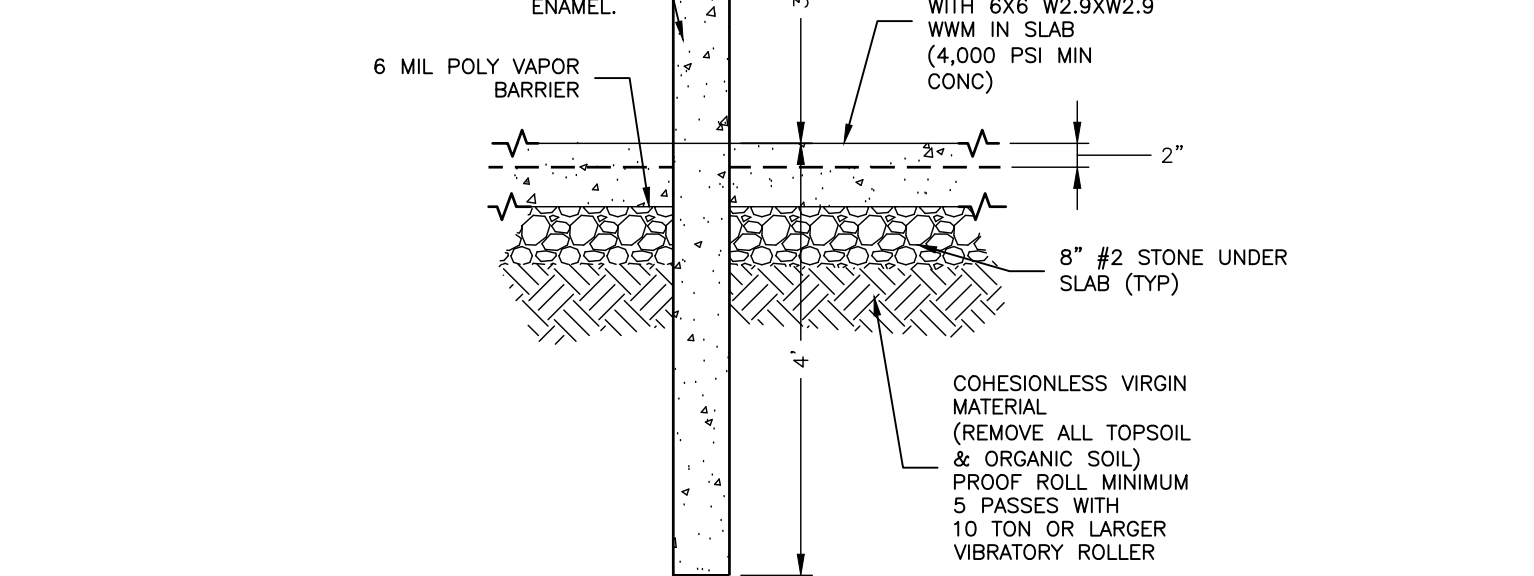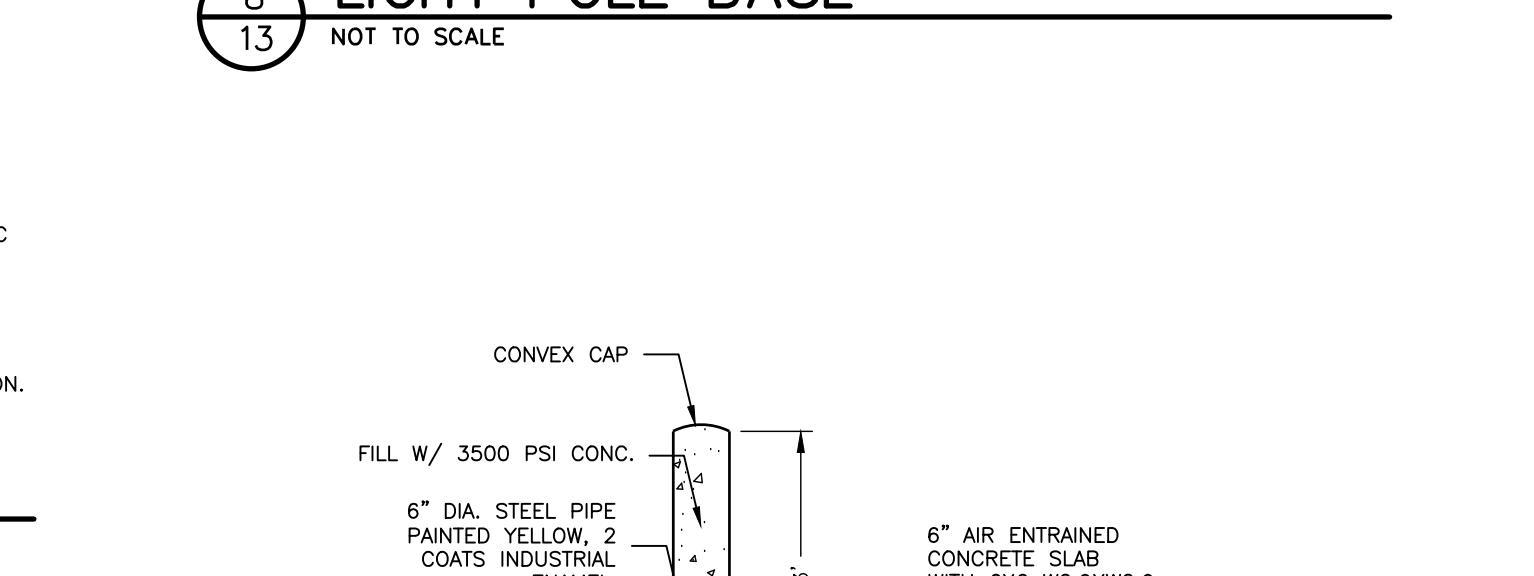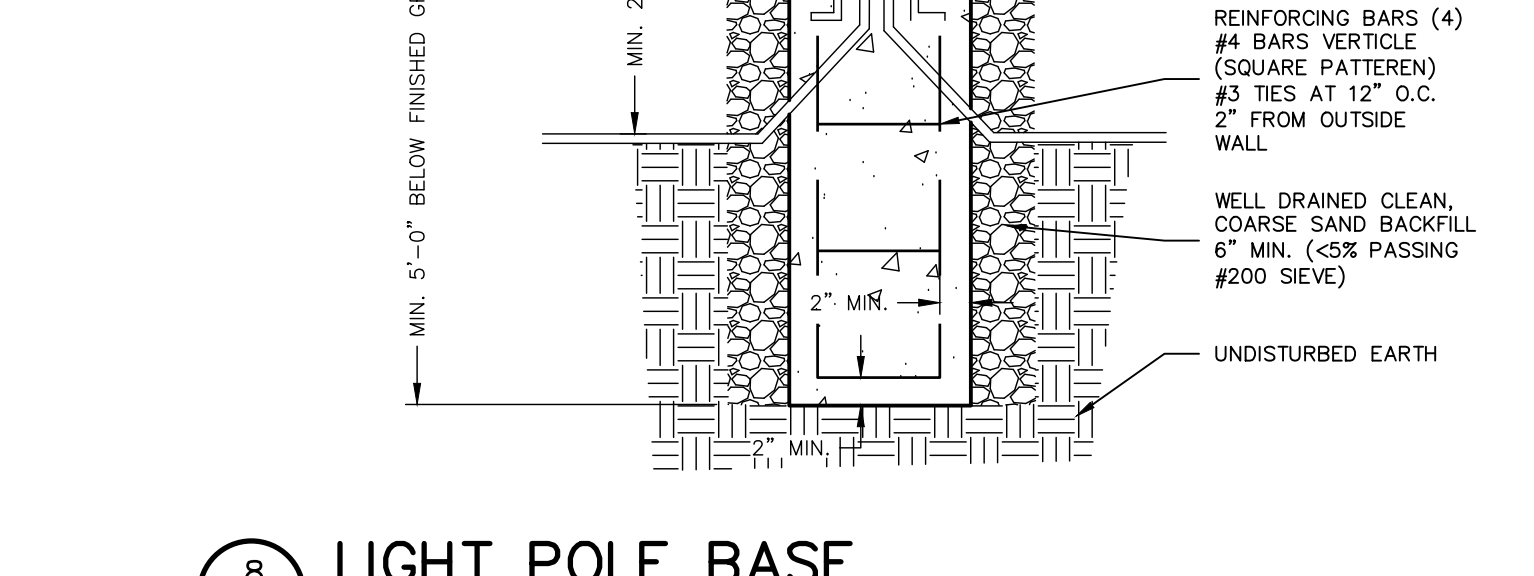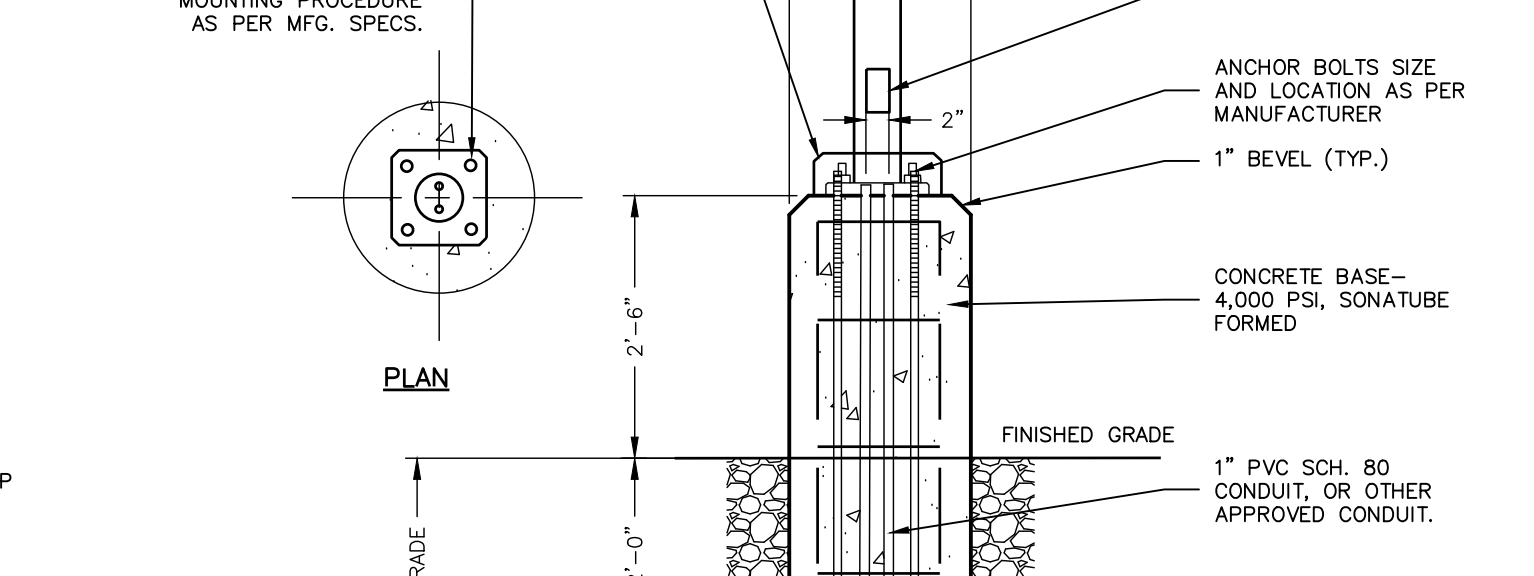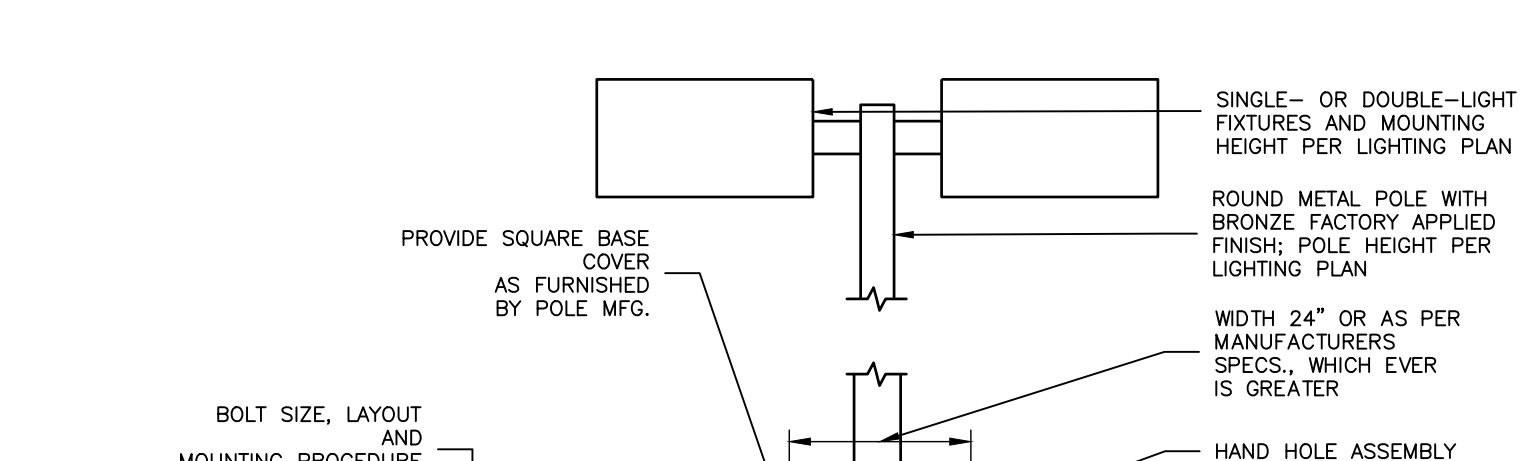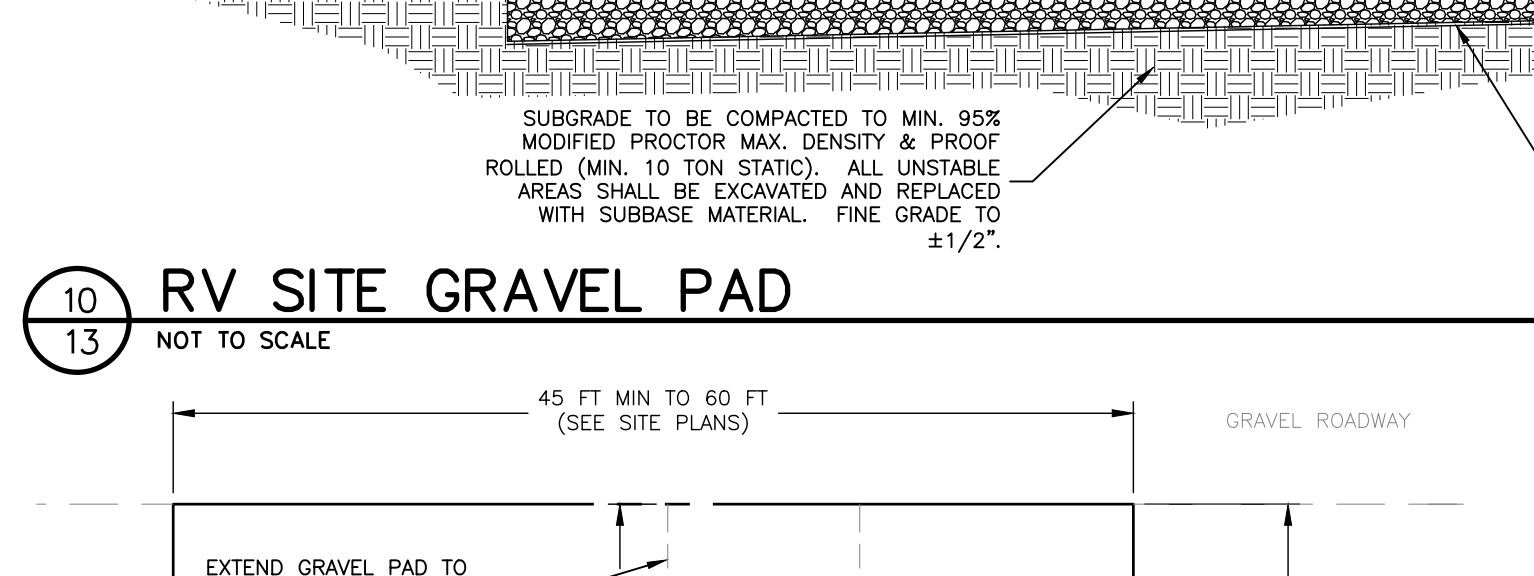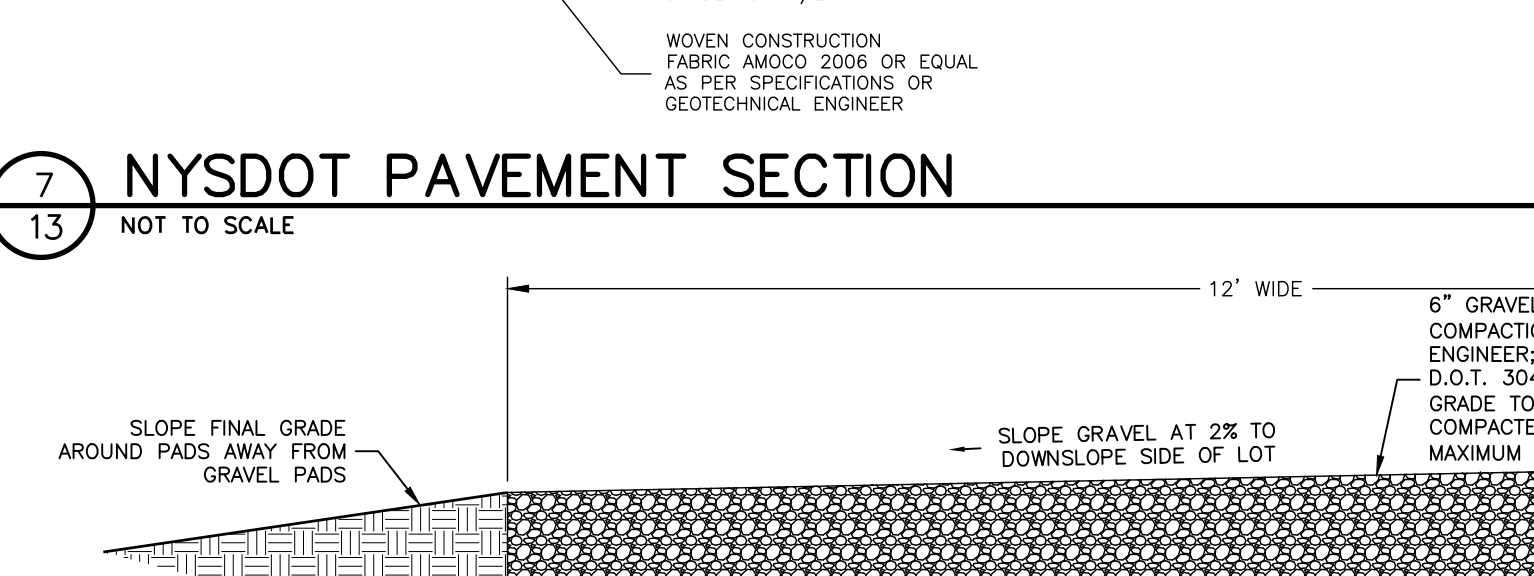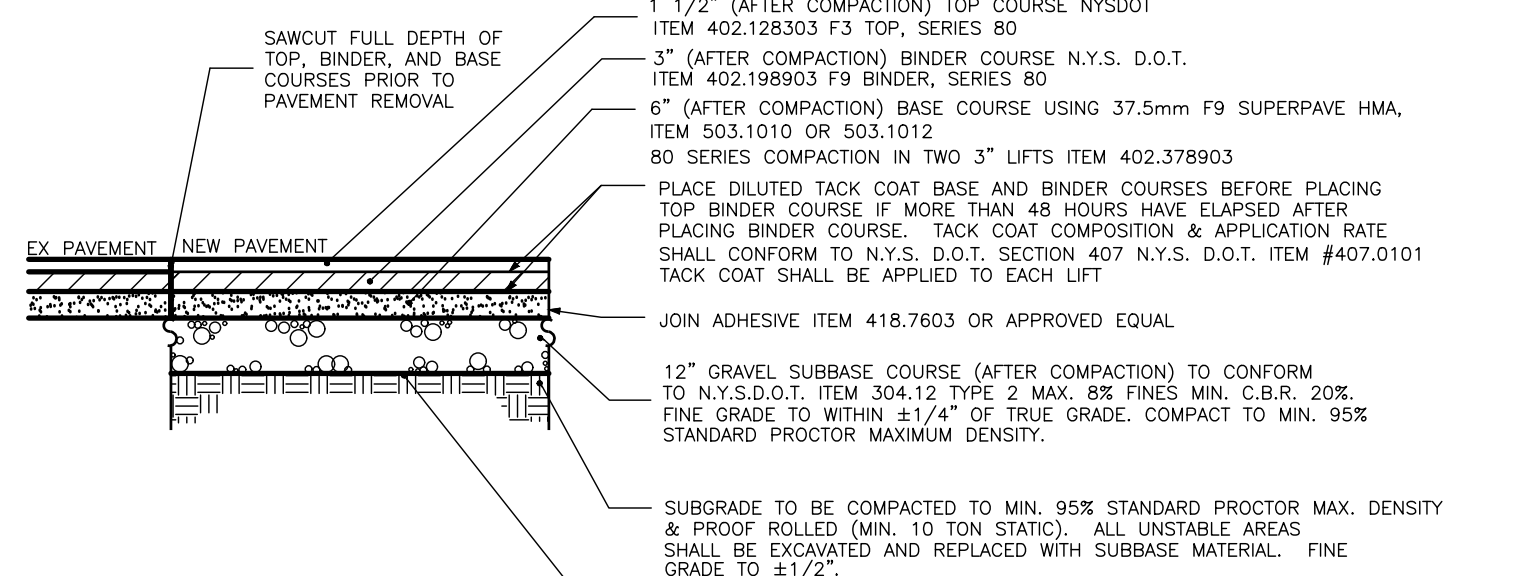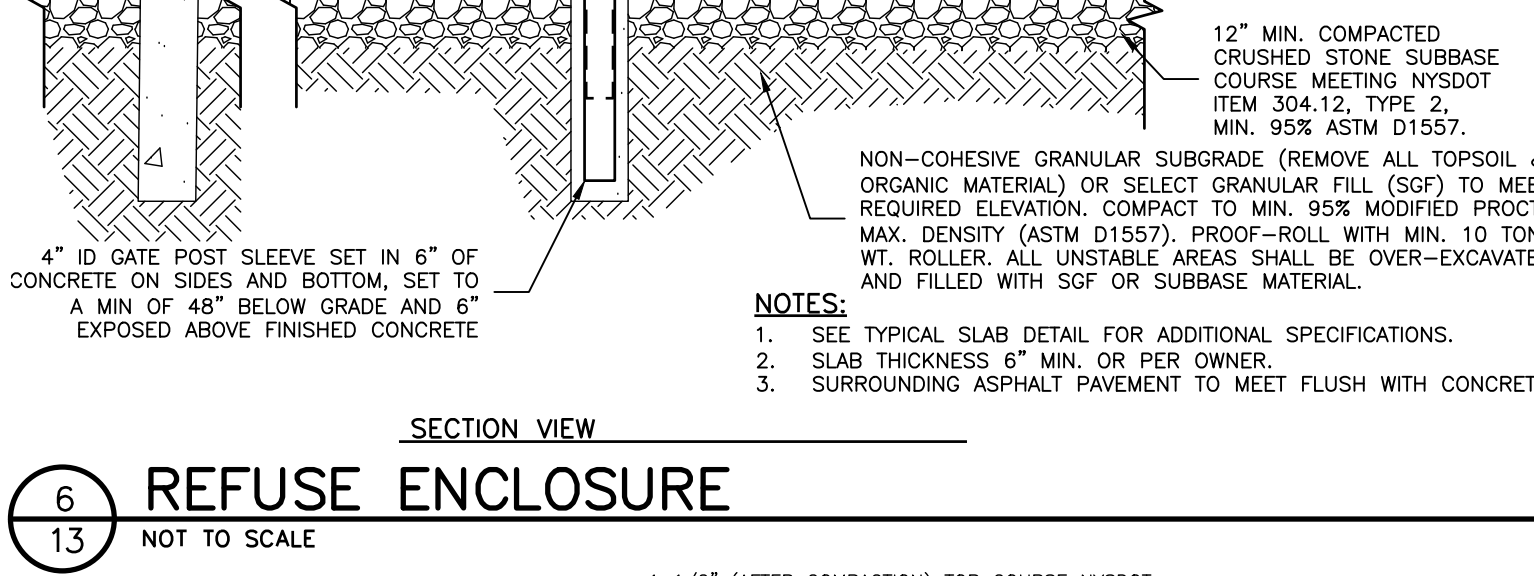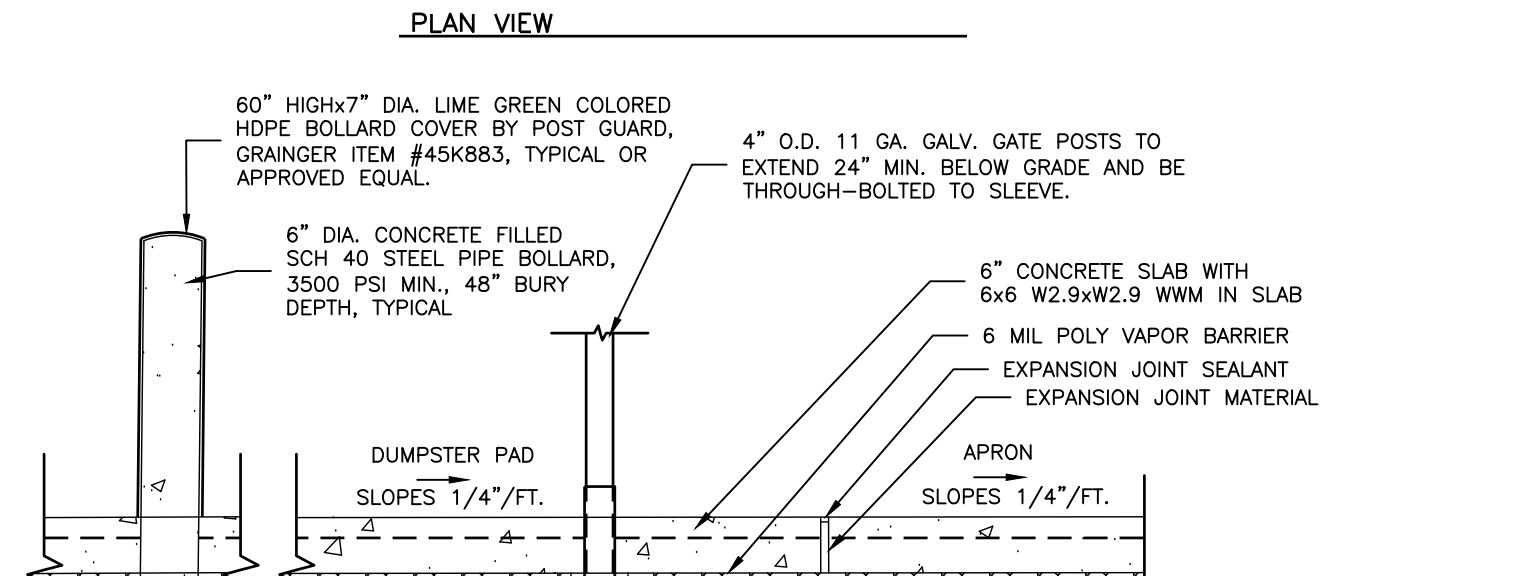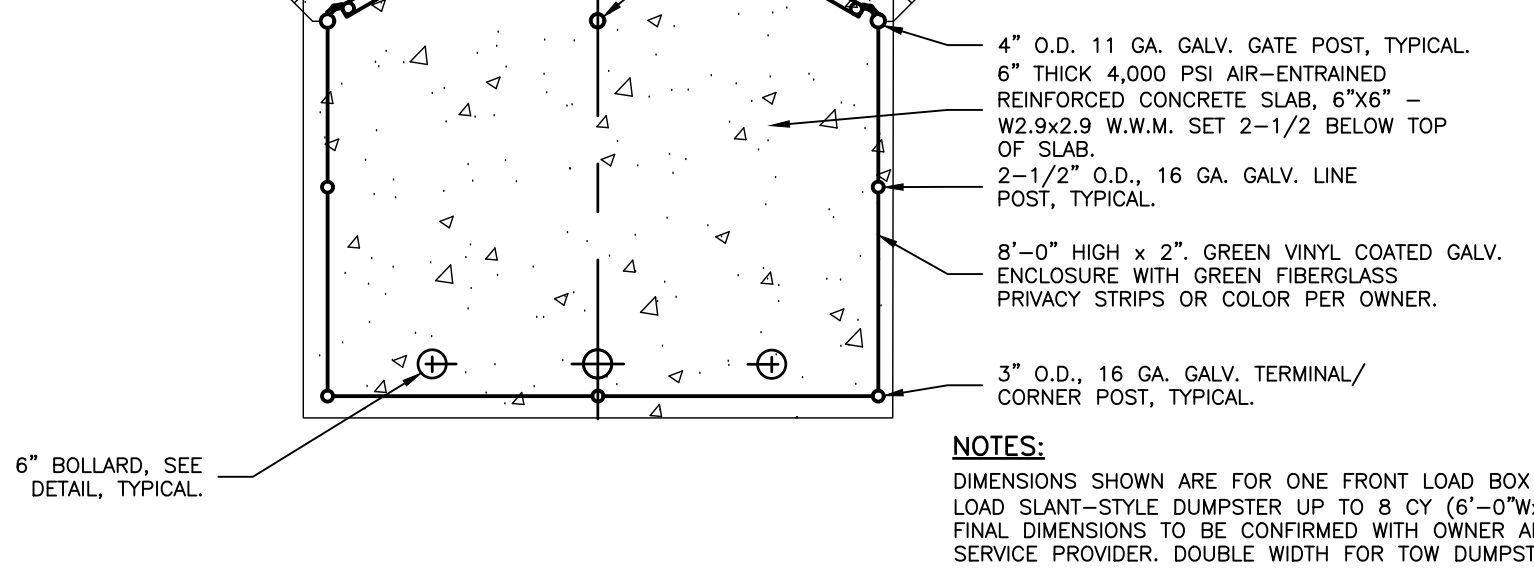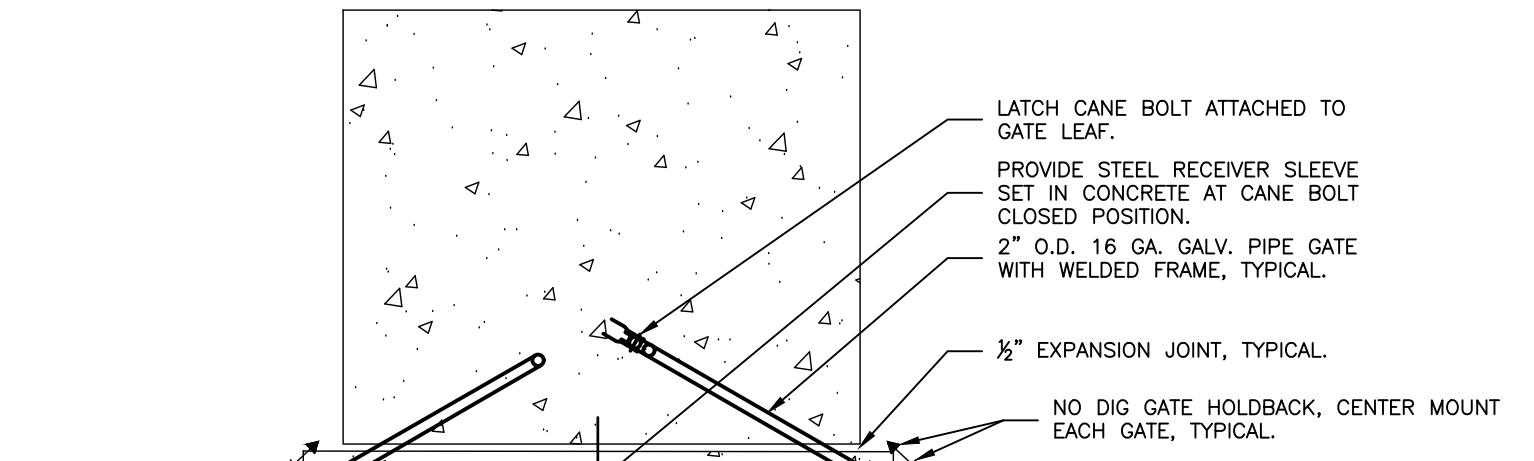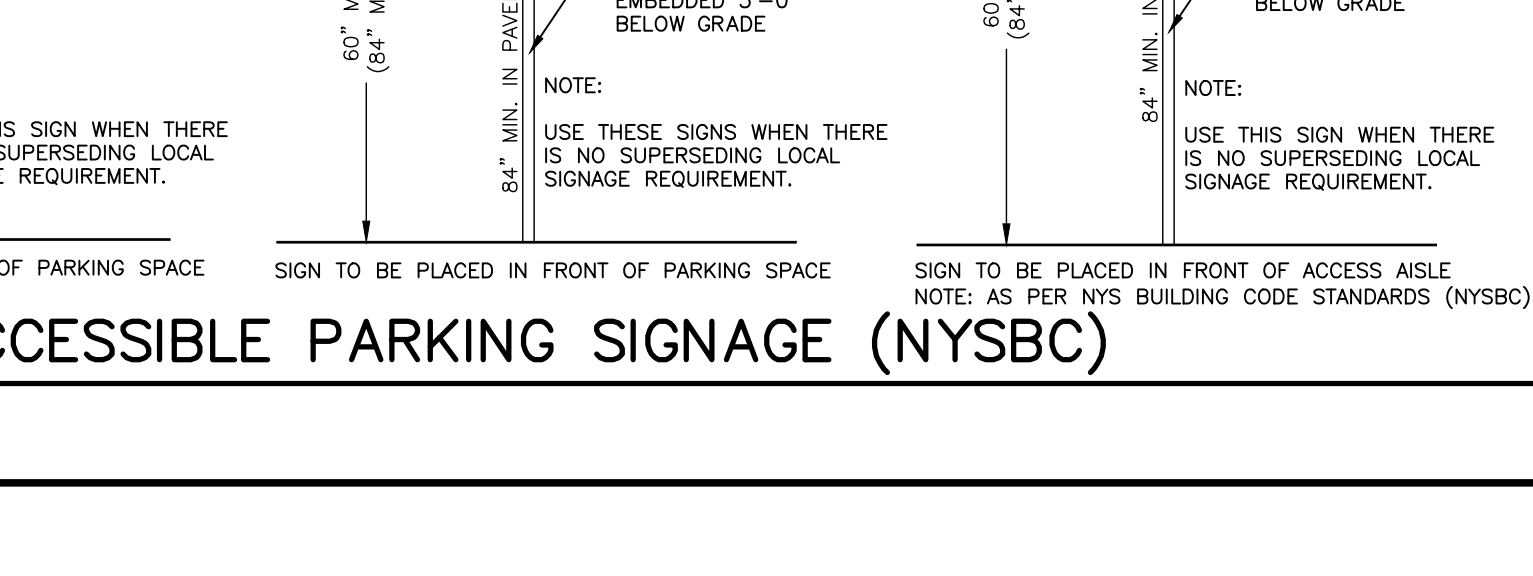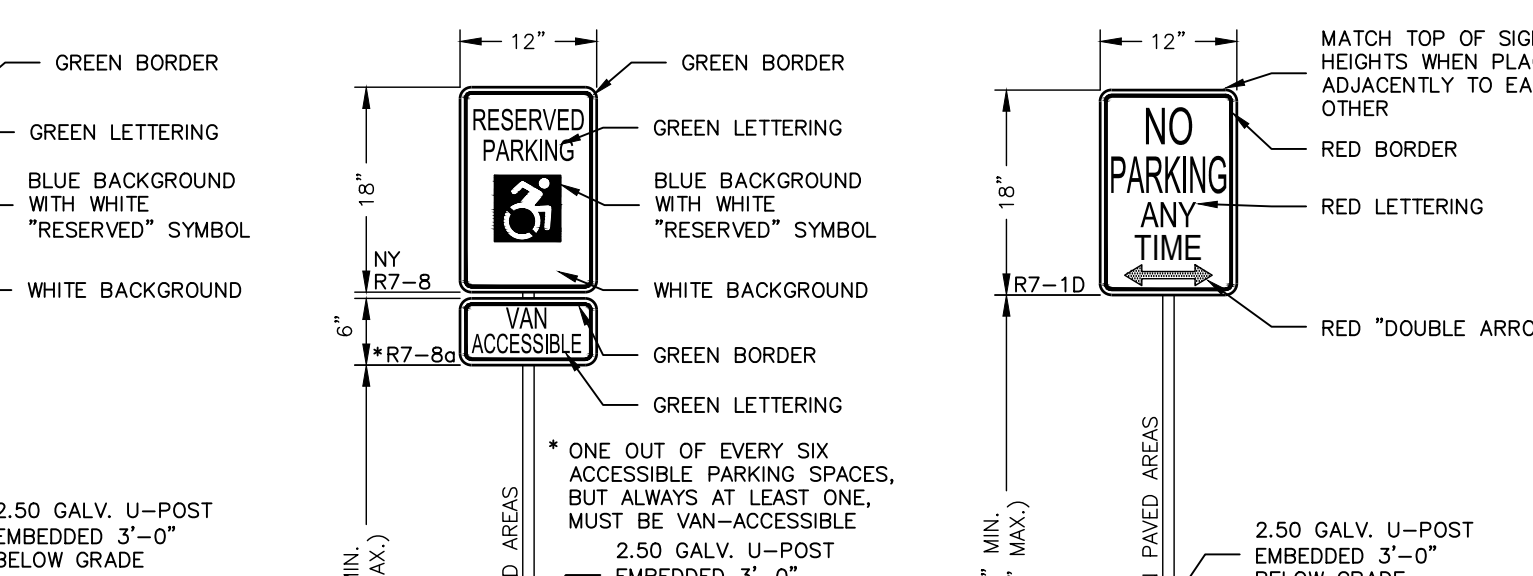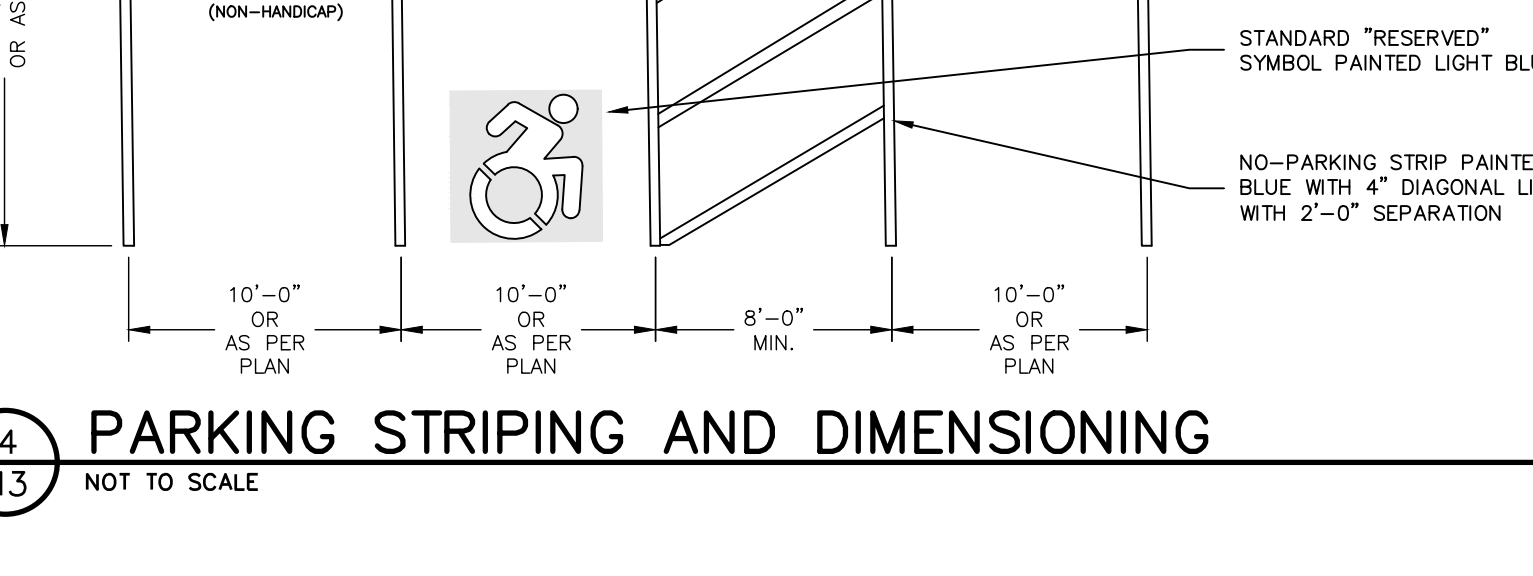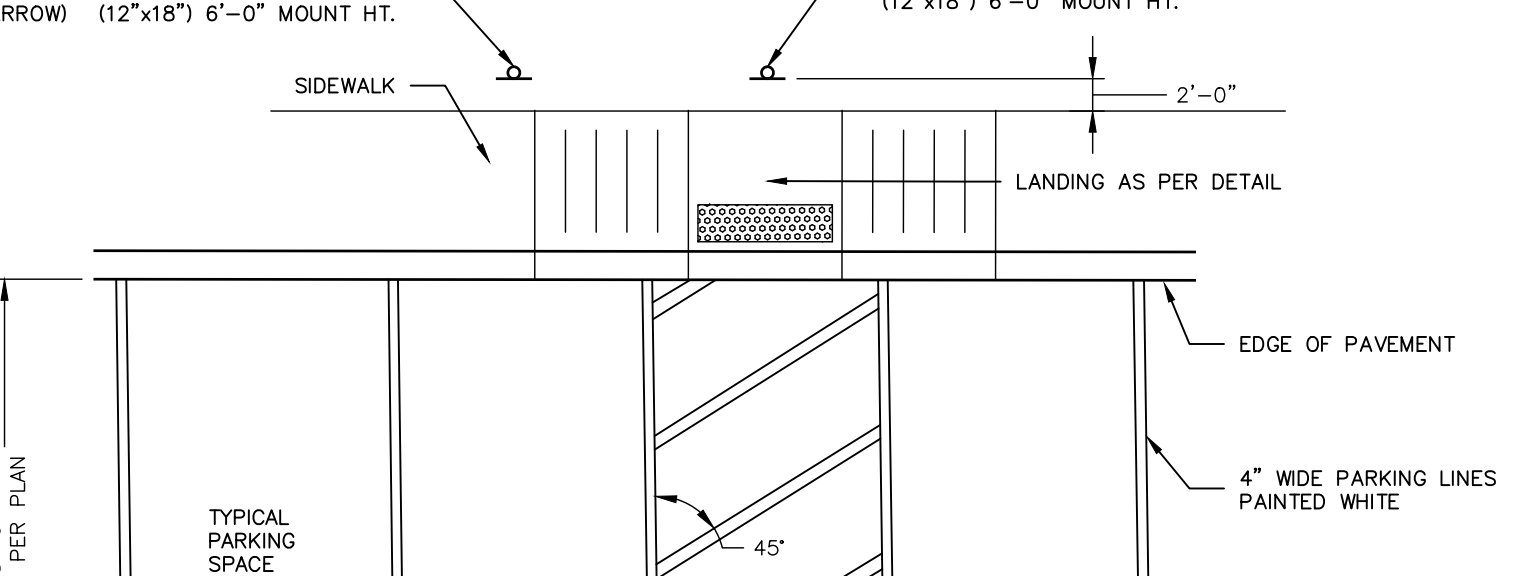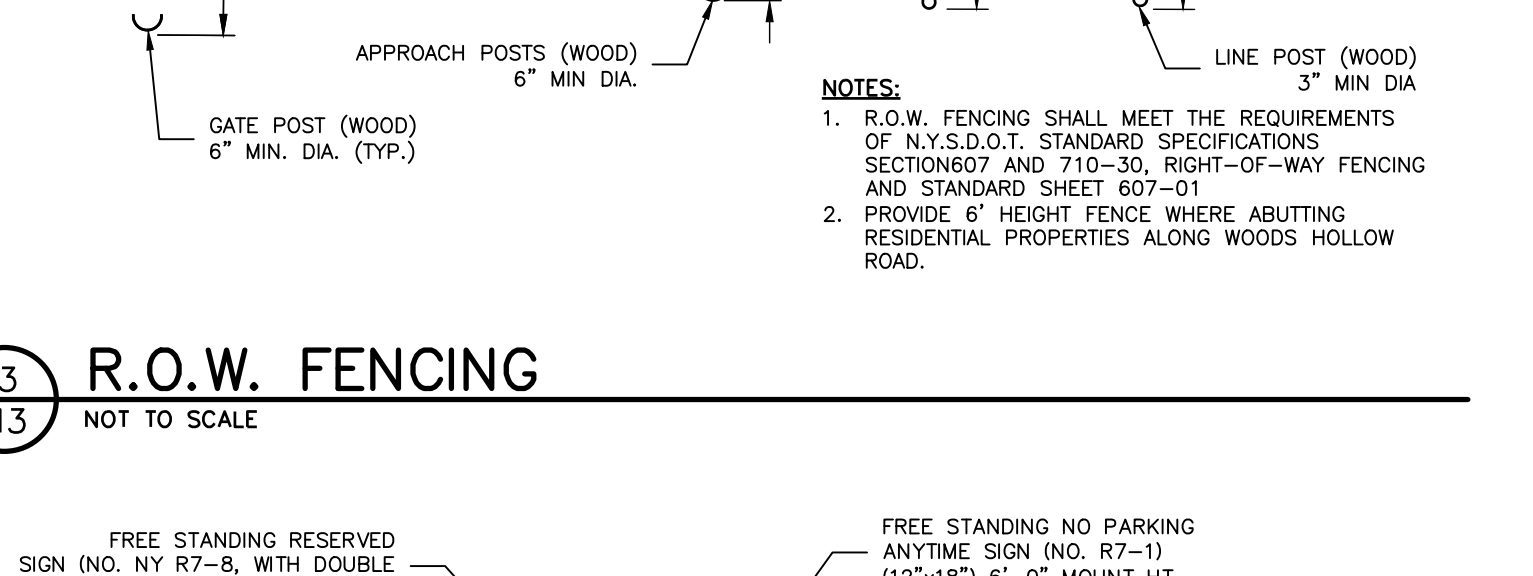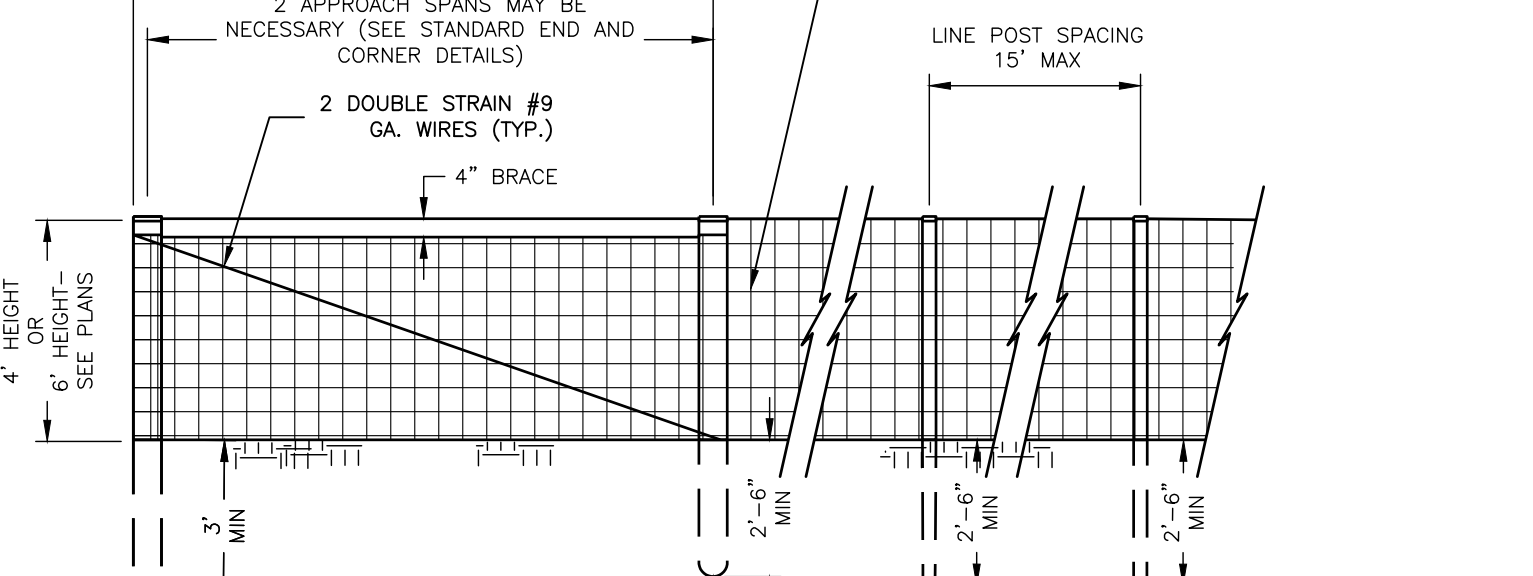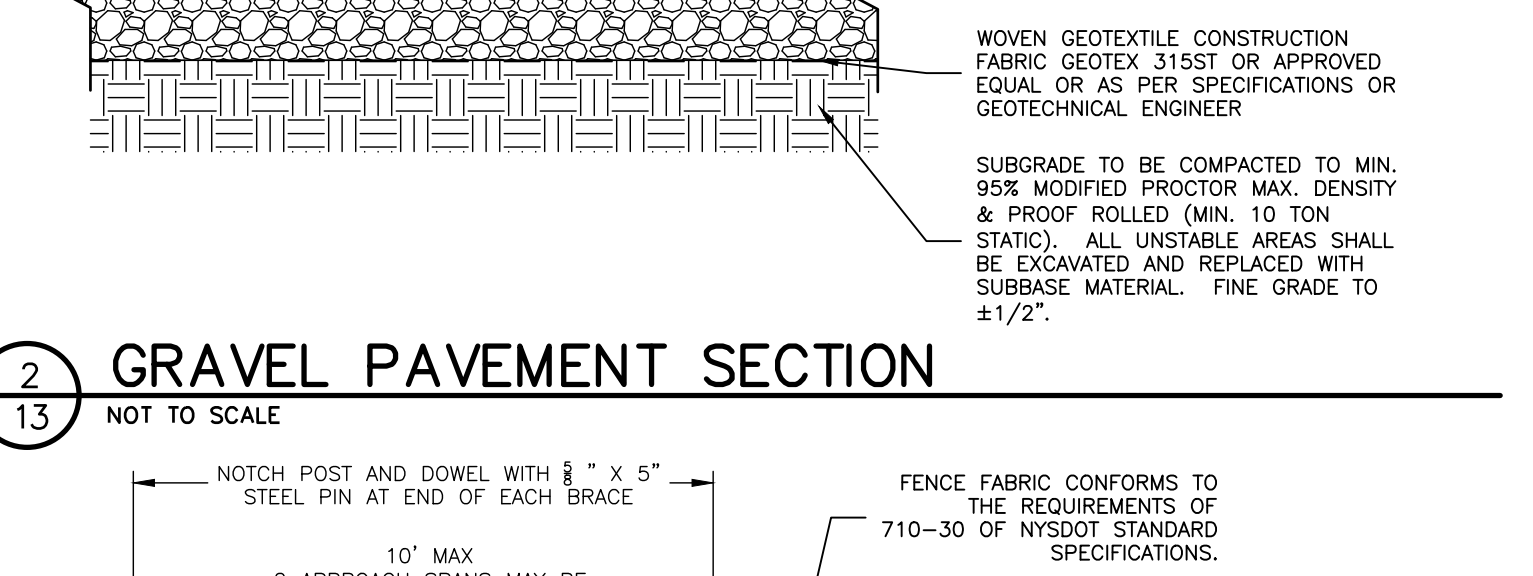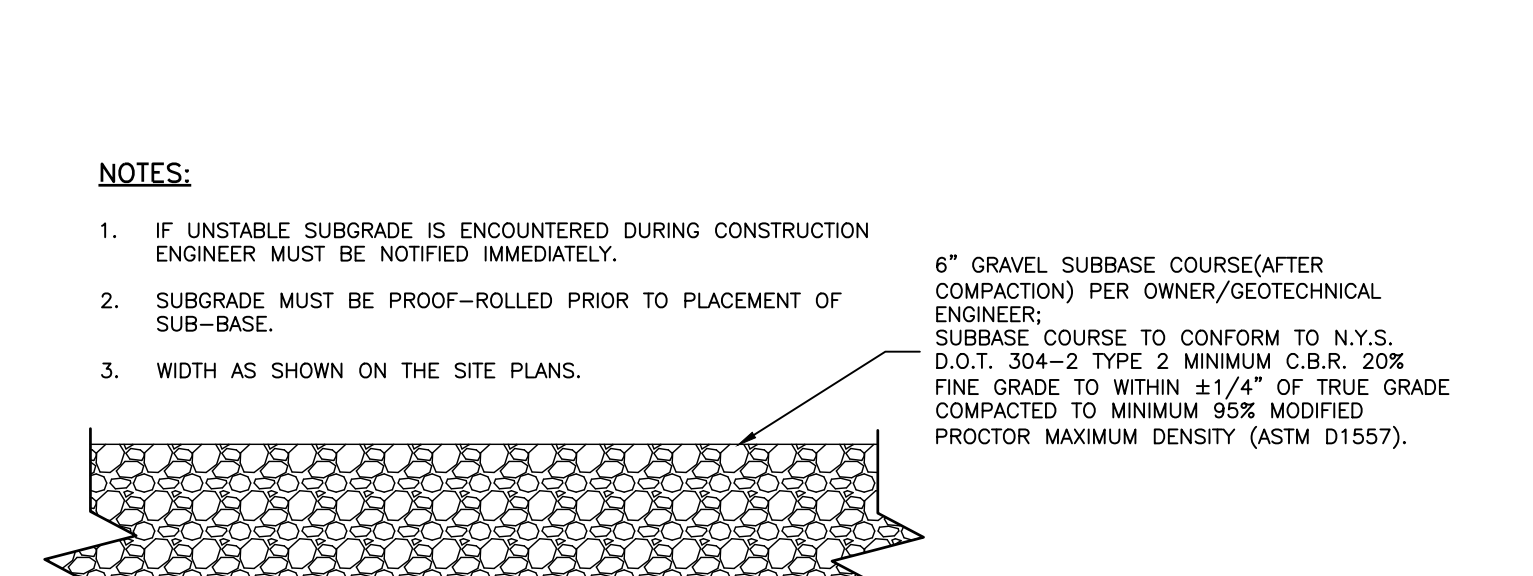

ENVIRONMENTAL DESIGN PARTNERSHIP, LLP. 900 Route 446 Cortland Park, New York, 14856 (518) 251-1212

TAX MAP NO. 137-4-51, 137-4-52, 137-4-53, 137-4-54, 137-4-55, 137-4-56, 137-4-54(1), 137-4-54(2), 137-4-54(3), 137-4-54(99), 137-4-54(100).

WOODS HOLLOW ROAD TOWN OF MAXFIELD FULTON COUNTY, NEW YORK

WOODS HOLLOW CAMPGROUND

RV PARK FOR WOODS HOLLOW MINING COMPANY


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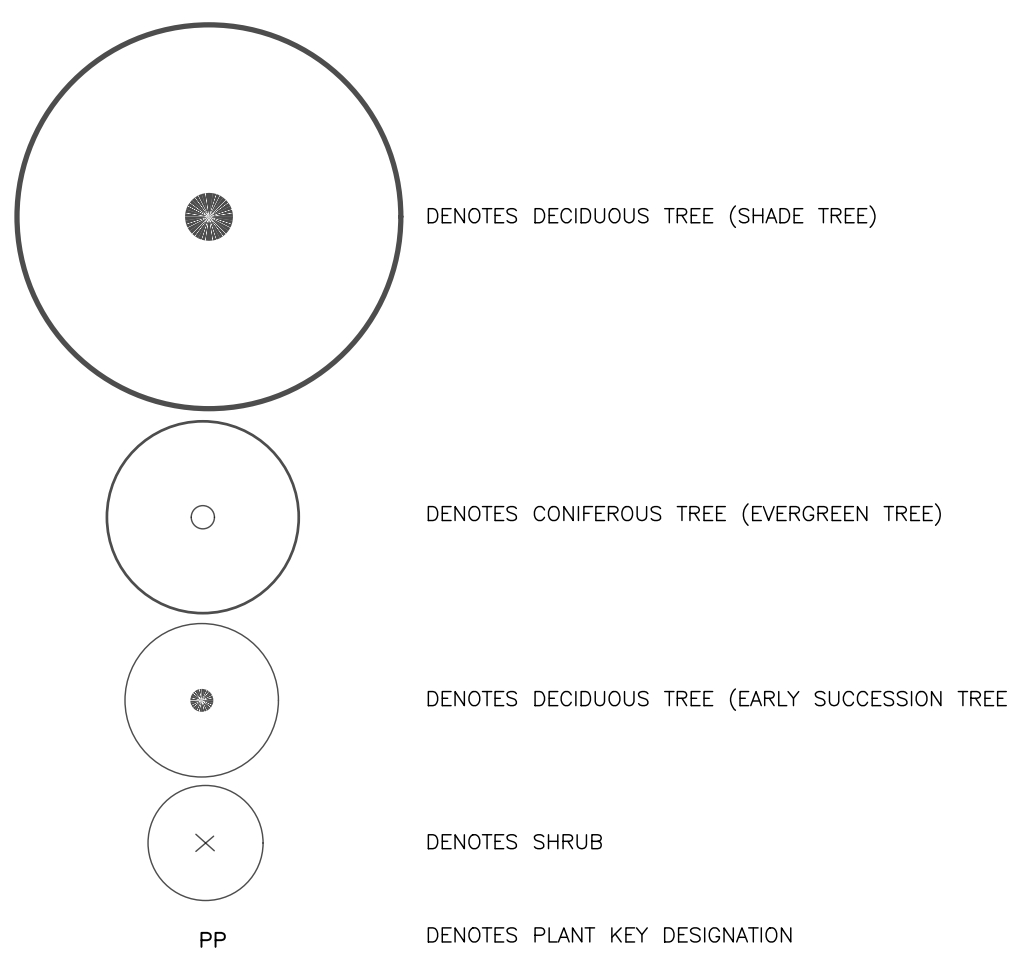
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SITE DETAILS

13 of 19




LEGEND:

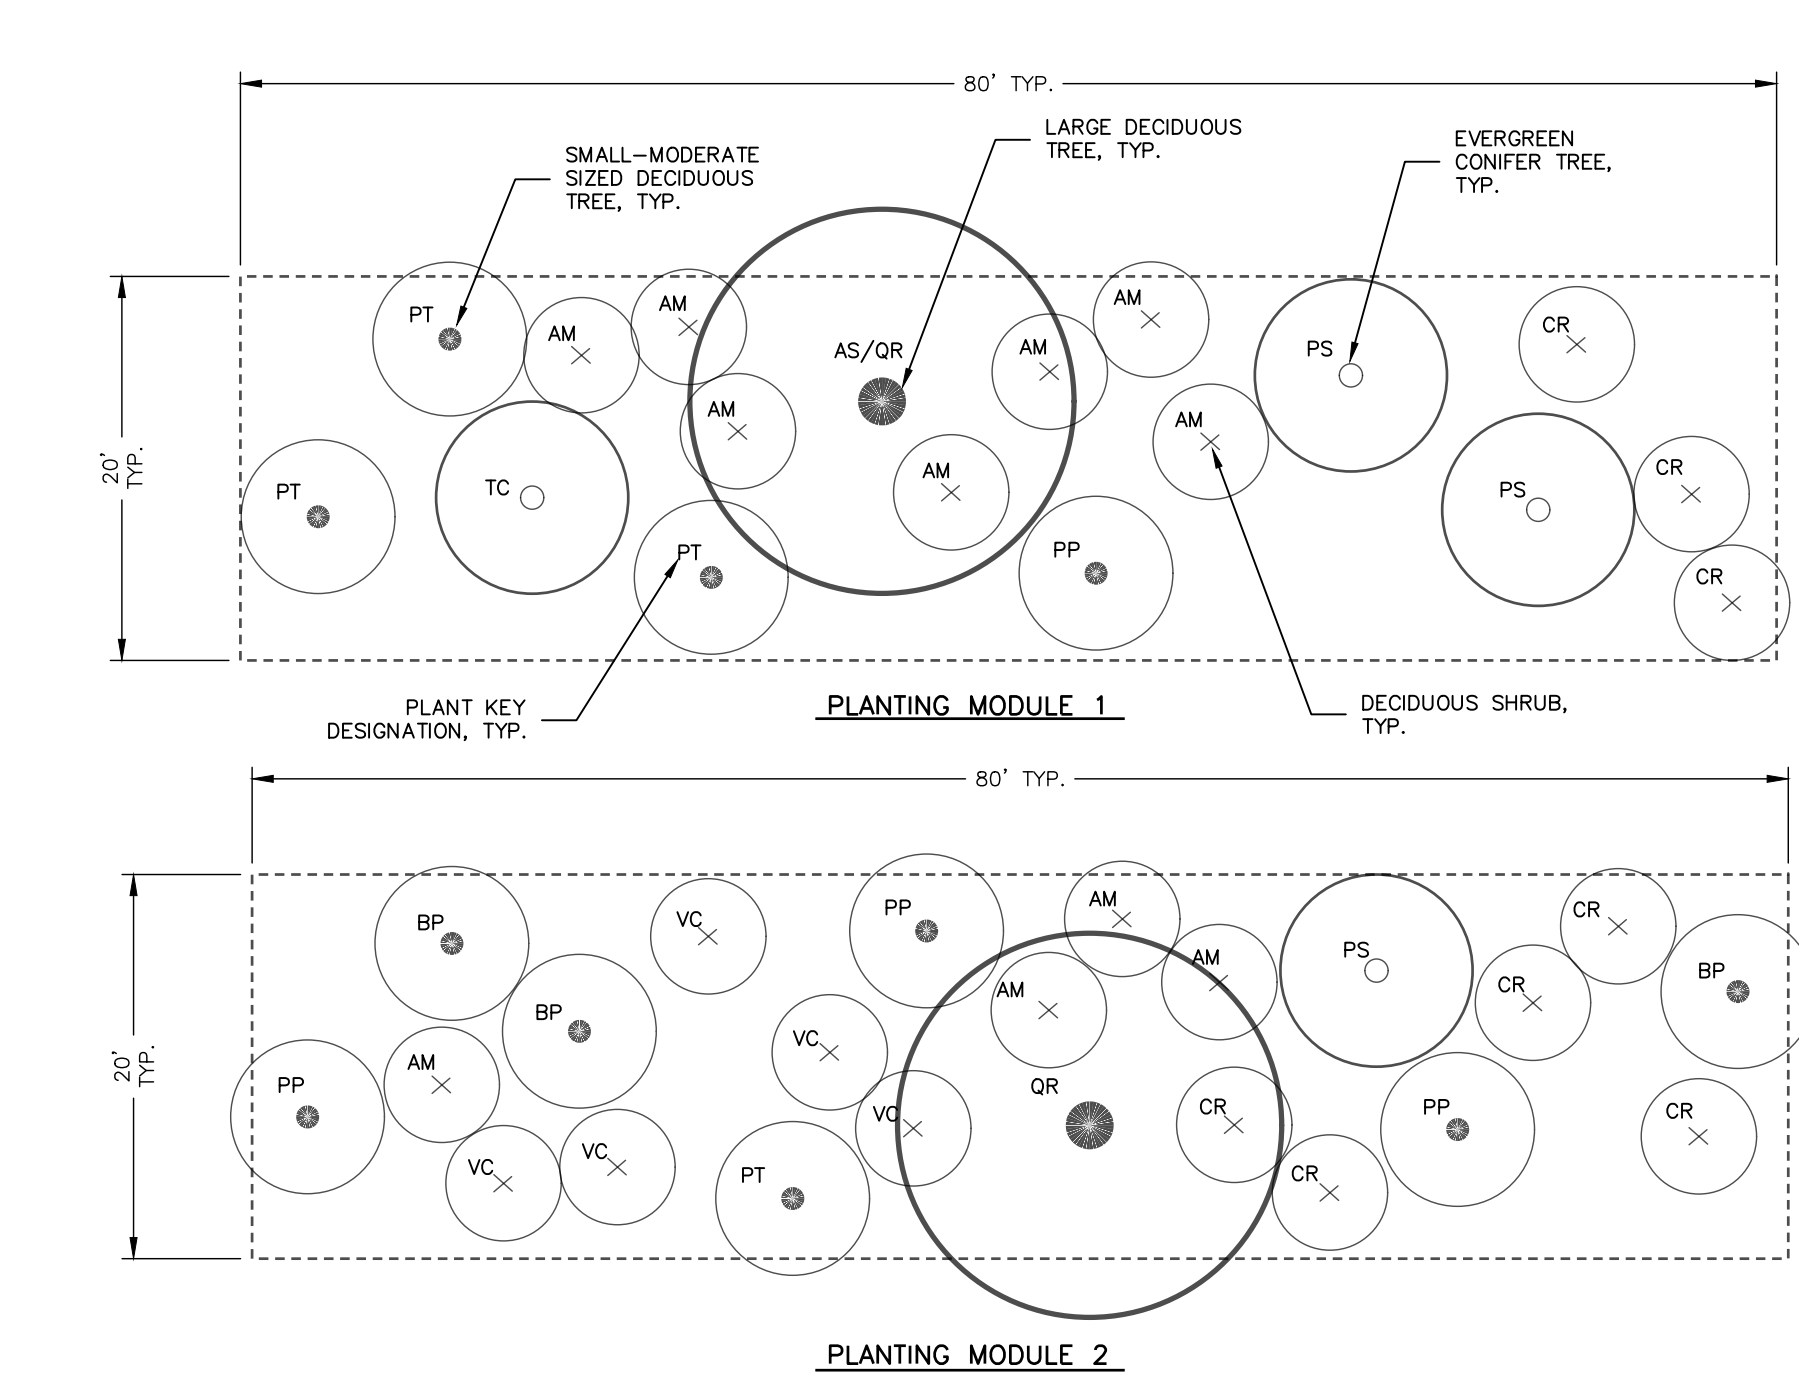

- NOTE:**
- PROVIDE QUANTITY OF PLANTING TO MEET BUFFER LENGTH INDICATED ON PLANS.
 - ALTERNATE MODULE LAYOUTS TO FIT EXISTING NATURALIZED VEGETATION CONDITIONS.
 - PLANT LOCATIONS MAY BE FIELD-A TO IMPROVE SCREENING EFFECT AND UTILITY CONDUITS OR OTHER PHYSICAL CONSTRAINTS.

1 BUFFER PLANTING MODULES

14 NOT TO SCALE

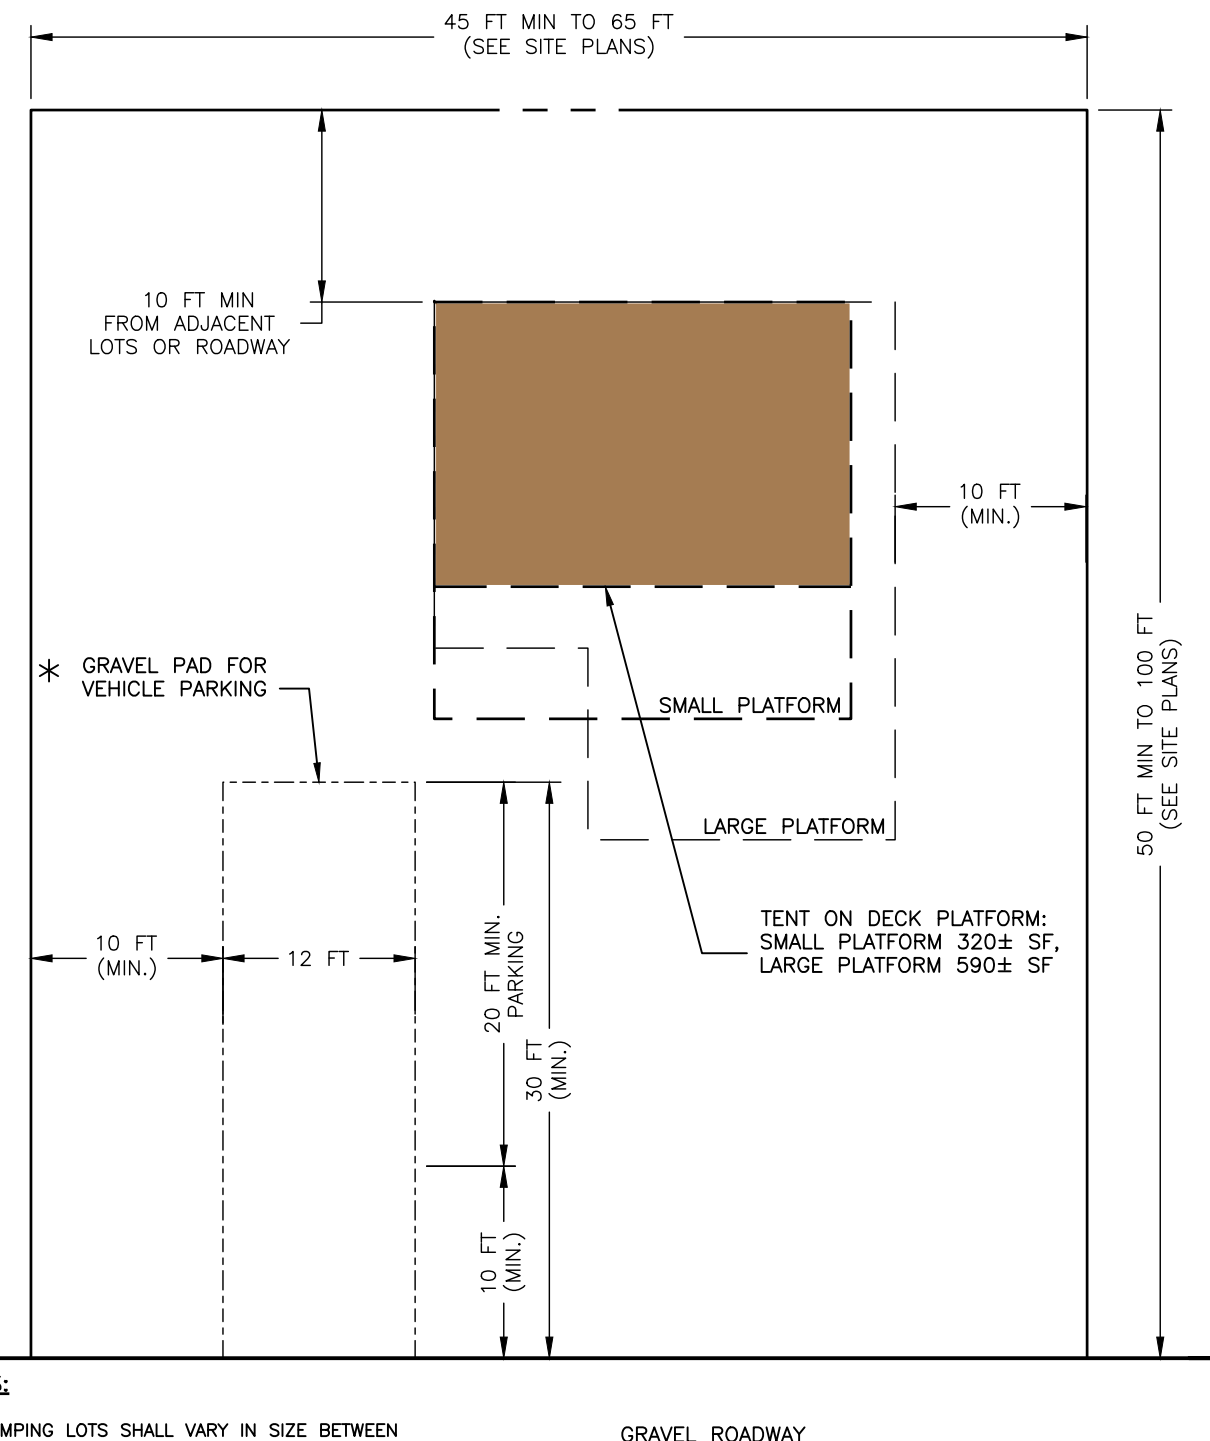

- NOTES:**
- GLAMPING LOTS SHALL VARY IN SIZE BETWEEN 2,500 SF TO 5,200 SF.
 - ALL GRAVEL PADS FOR VEHICLE PARKING SPACES SHALL BE INSTALLED TO MAINTAIN A MINIMUM OF 20 FEET BETWEEN PARKING SPACES.
 - EACH SITE SHALL INCLUDE A MIN. 8'X20' SPACE TO PROVIDE REQUIRED VEHICLE PARKING.
 - LARGER-SIZED TENTS SHALL BE INSTALLED ON SITES WITH 50 MIN. WIDTH.
 - TENT PLATFORM (DECK) SHALL BE INSTALLED WITH 6 INCHES MINIMUM CLEARANCE ABOVE GROUND.

5 GLAMPING SITE TYPICAL LAYOUT

14 NOT TO SCALE

PLANT SCHEDULE - BUFFER PLANTING MODULES

KEY	QUANTITY PER EACH MODULE 1	QUANTITY PER EACH MODULE 2	TOTAL QTY	BOTANICAL NAME	COMMON NAME	SIZE/ ROOT CONDITION	INSTALL SIZE (HT)	**NATIVE SPECIES STATUS
AS	1	—	11	ACER SACCHARUM	SUGAR MAPLE	1.5" CALIPER; CONTAINER	10-12' HT	NATIVE; FULTON COUNTY
QR	—	1	11	QUERCUS RUBRA	NORTHERN RED OAK	1.5" CALIPER; CONTAINER		NATIVE; FULTON COUNTY
PS	2	1	33	PINUS STROBUS	EASTERN WHITE PINE	4' HT; B&B	4' HT	NATIVE; FULTON COUNTY
TC	1	—	11	TSUGA CANADENSIS	CANADIAN HEMLOCK	5' HT; B&B	5' HT	NATIVE; FULTON COUNTY
BP	—	3	33	BETULA POPULIFOLIA	GRAY BIRCH	#7 CONTAINER	4'-6" HT	NATIVE; FULTON COUNTY
PT	3	1	44	POPULUS TREMULOIDES	QUAKING ASPEN	#7 CONTAINER	4'-6" HT	NATIVE; FULTON COUNTY
PP	1	3	44	PRUNUS PENNSYLVANICA	PIN CHERRY	#7 CONTAINER	4'-6" HT	NATIVE; FULTON COUNTY
CR	3	5	88	CORNUS RACEMOSA	GRAY DOGWOOD	#3 CONTAINER	2'-4" HT	NATIVE; FULTON COUNTY
VC	—	4	44	VACCINIUM CORYMBOSUM	HIGHBUSH BLUEBERRY	#5 CONTAINER	2'-3" HT	NATIVE; FULTON COUNTY
AM	7	4	121	ARONIA MELANOCARPA	BLACK CHOKEBERRY	#5 CONTAINER	2'-3" HT	NATIVE; FULTON COUNTY

* NOTE: TOTAL PLANT QUANTITIES ARE BASED ON 1760 FT TOTAL LENGTH OF BUFFER PLANTINGS AS INDICATED ON PLANS, COMPRISED OF 11 EACH OF BOTH MODULE 1 AND MODULE 2, AS FOLLOWS.

- 20' WIDE X 720' LENGTH ALONG WOODS HOLLOW ROAD FRONTAGE, WEST (4 EACH OF MODULE 1, 5 EACH OF MODULE 2)
- 20' WIDE X 480' LENGTH ALONG PROPERTY LINES ABUTTING RESIDENTIAL PROPERTIES NEAR WOODS HOLLOW ROAD FRONTAGE, EAST (3 EACH OF MODULE 1 AND 2)
- 20' WIDE X 480' LENGTH ALONG WOODS HOLLOW ROAD FRONTAGE, EAST (3 EACH OF MODULE 1, 2 EACH OF MODULE 2)
- 20' WIDE X 160' LENGTH ALONG NYS ROUTE 30 (1 EACH OF MODULE 1, 1 EACH OF MODULE 2)

** NOTE: NATIVE SPECIES STATUS DETERMINED BY FIELD-DOCUMENTED OCCURRENCE IN FULTON COUNTY AS LISTED IN THE 2021 NEW YORK FLORA ATLAS (NYSFA - NEW YORK FLORA ASSOCIATION)

PLANTING NOTES:

- PLANTING CONTRACTOR SHALL VERIFY FINAL SELECTION OF PLANT MATERIALS WITH THE LANDSCAPE ARCHITECT PRIOR TO INSTALLATION.
- ALL AREAS OF SITE WHICH ARE DISTURBED AND NOT LANDSCAPED, PAVED, SHALL BE TOPSOILED, SEEDED, AND MULCHED. (MULCH - STRAW, HYDROSEED MIX, OR BIODEGRADABLE NETTING) MIXTURES TO BE APPLIED SHALL BE DETERMINED BY OWNER'S REPRESENTATIVES. TOPSOIL TO BE 4" MINIMUM.
- EXISTING VEGETATION SHALL REMAIN UNDISTURBED WITHIN ALL AREAS OF SITE WHICH DO NOT REQUIRE GRADING.
- ALL PLANTING BEDS TO RECEIVE 3" MINIMUM BARK MULCH WITH FILTER FABRIC WEED CONTROL OR EQUAL.
- THIS PLAN IS FOR PLANTING PURPOSES ONLY. REFER TO SITE PLAN FOR DETAILED GRADING AND UTILITY INFORMATION.
- GUARANTEE:
 - FOR A PERIOD OF TWELVE MONTHS FROM THE DATE THAT THE WORK UNDER CONTRACT IS CERTIFIED AS COMPLETE, THE CONTRACTOR SHALL:
 - GUARANTEE ALL PLANTS AND SEEDED AREAS UNDER THIS CONTRACT:
 - REMOVE AND REPLACE DURING THIS GUARANTEE PERIOD, PLANTS WHICH DIE OR ARE IN A BADLY IMPAIRED CONDITION;
 - REPLANT WITH STOCK OF SAME SIZE AND QUALITY AS ORIGINALLY SPECIFIED;
 - BUY AND MAINTAIN AS SPECIFIED HEREIN, AT NO ADDITIONAL COST.
- REPLACEMENTS MADE WITHIN SIX MONTHS AFTER BEGINNING OF THE "GUARANTEE PERIOD" SHALL NOT EXTEND THE "GUARANTEE PERIOD" OF THESE PARTICULAR PLANTS; THOSE REPLACEMENTS MADE SIX MONTHS OR MORE AFTER THE BEGINNING OF THE "GUARANTEE PERIOD" SHALL BE MAINTAINED AND GUARANTEED FOR A PERIOD OF SIX MONTHS FROM THE TIME OF REPLACEMENT.
- APPLICABLE STANDARDS: "AMERICAN STANDARD FOR NURSERY STOCK" BY THE AMERICAN ASSOCIATION OF NURSERYMEN AND "STANDARDIZED PLANT NAMES" BY THE AMERICAN JOINT COMMITTEE ON HORTICULTURAL NOMENCLATURE ARE A PART OF THIS SPECIFICATION. ALL PLANTS SHALL BE NURSERY GROWN, NOT GATHERED IN THE FIELD.

PLANTING NOTE:

PLANTS LISTED IN THE PLANTING SCHEDULE MAY BE SUBSTITUTED FOR SIMILAR SPECIES OF THE SAME SIZE WITH THE WRITTEN APPROVAL OF THE OWNER/DEVELOPER AND/OR PROJECT LANDSCAPE ARCHITECT. SUBSTITUTIONS SHALL MEET ALL PERMIT AND APPROVAL REQUIREMENTS.

PLANTING BED PREPARATION NOTE:

ALL PAVEMENT, AND GRAVEL BASE SHALL BE REMOVED FROM PROPOSED PLANTING BEDS AREAS. COMPACTED SUBGRADE MATERIALS SHALL BE DECOMPACTED FOR A DEPTH OF 12". PLANTING BEDS SHALL BE FREE OF ROOTS AND FILLED TO A DEPTH 12" INCORPORATE 2" OF COMPOST INTO SOIL. TOP DRESS ALL PLANTINGS WITH 3" OF COMPOSTED SHREDED HARDWOOD MULCH.

TOPSOIL NOTE:


ALL AREAS WHICH ARE DISTURBED AND NOT LANDSCAPED, PAVED OR OTHERWISE RESTORED SHALL RECEIVE A MINIMUM OF 4" OF TOPSOIL. ALL PLANTING BEDS OR INDIVIDUAL PLANTING PITS SHALL RECEIVE A MINIMUM OF 12" OF TOPSOIL. ON-SITE SURFACE SOIL WILL BE STRIPPED AND STOCKPILED FOR REUSE AS TOPSOIL ON SITE. PROVIDE IMPORTED TOPSOIL IF ON-SITE QUANTITY IS INSUFFICIENT TO MEET PROJECT NEEDS. TOPSOIL SHALL HAVE: 25-40% ORGANIC MATTER PH OF 6-7.5; MAXIMUM PARTICLE SIZE 1.5"

SEED MIXES:

PERMANENT VEGETATION: SEED ALL AREAS WHICH ARE DISTURBED AND NOT PLANTED, PAVED OR OTHERWISE RESTORED WITH TURFGRASS SEED CONTAINING A 20% CREEPING RED FESCUE, 30% PERENNIAL RYEGRASS, 30% TALL FESCUE AND A MAXIMUM OF 20% ANNUAL RYE GRASS. SEED SHALL BE APPLIED AT A RATE OF 3-5 LBS PER 1000 SF OR 75-150 LBS PER ACRE.


PLANT MAINTENANCE:

- ESTABLISHMENT PERIOD: BEGIN MAINTENANCE FOLLOWING INSTALLATION AND CONTINUE UNTIL FINAL ACCEPTANCE AT CLOSE OF ONE-YEAR WARRANTY PERIOD.
- MAINTENANCE SHALL INCLUDE:
 - PRUNING, WATERING, CULTIVATING, WEEDING, MULCHING, REPAIR OF STAKES AND GUYS, RESETTING TO PROPER POSITION, RESTORATION OF THE PLANTING SAUCER, AND FURNISHING AND APPLYING TREATMENTS REQUIRED TO KEEP PLANTS PEST- AND DISEASE-FREE.
 - PROTECT PLANTS AND PLANTING AREAS FREE FROM TRESPASS AND DAMAGE. TREAT OR REPLACE DAMAGED OR INJURED PLANTS. INSTALL TEMPORARY FENCING, TRUNK PROTECTORS OR OTHER BARRIER TO PREVENT DEER BROWSE OR PHYSICAL DAMAGE BY ANIMALS OR INSECTS.
 - WATERING: SATURATE ALL PLANTINGS TWICE PER WEEK AT THE RATE OF 1" DEPTH APPLIED WATER (RAIN BY TEMPORARY IRRIGATION OR AS RECEIVED BY NATURAL PRECIPITATION).
- POST-ESTABLISHMENT:
 - REMOVE ALL STAKES, GUYS WEBS AND ANY PROTECTIVE WRAPPING OR BARRIERS THAT IMPEDES PLANT GROWTH OR HEALTH.
 - INSPECT PLANTINGS ANNUALLY TO ASSESS HEALTH OF BUFFER PLANTINGS. PROVIDE MAINTENANCE LISTED ABOVE TO PROMOTE AND SUPPORT HEALTHY PLANT GROWTH.
 - AESTHETIC GOAL: NATURALIZED VEGETATION THAT BLENDS INTO THE SURROUNDING EXISTING VEGETATION. PROVIDE PRUNING AND MAINTAIN ONLY AS NEEDED TO SUSTAIN PLANT HEALTH AND PROVIDE SAFE TREE STRUCTURE. DO NOT SHEAR PLANTS OR TOP TREES.

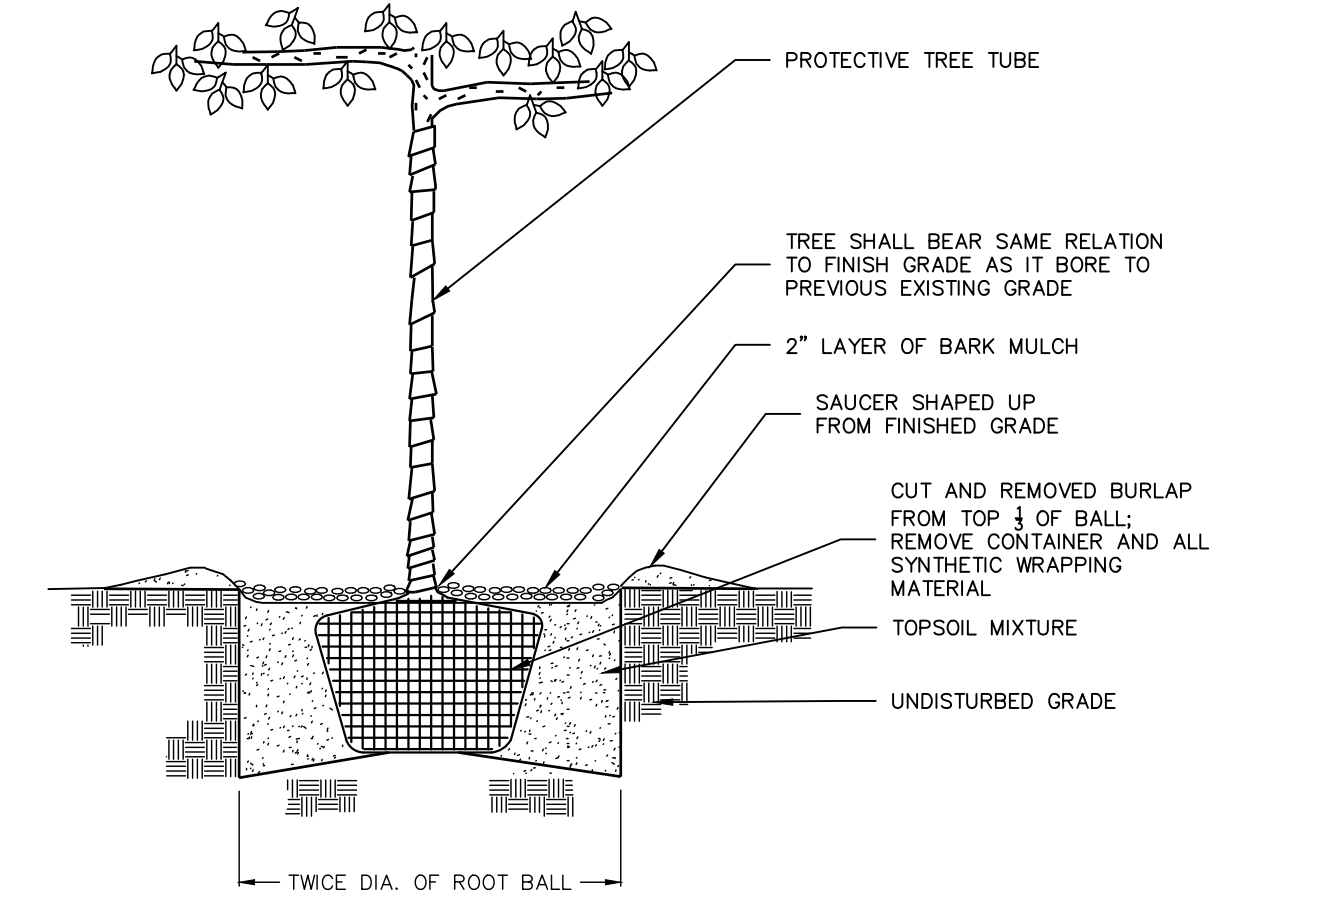


2 DECIDUOUS TREE

14 NOT TO SCALE

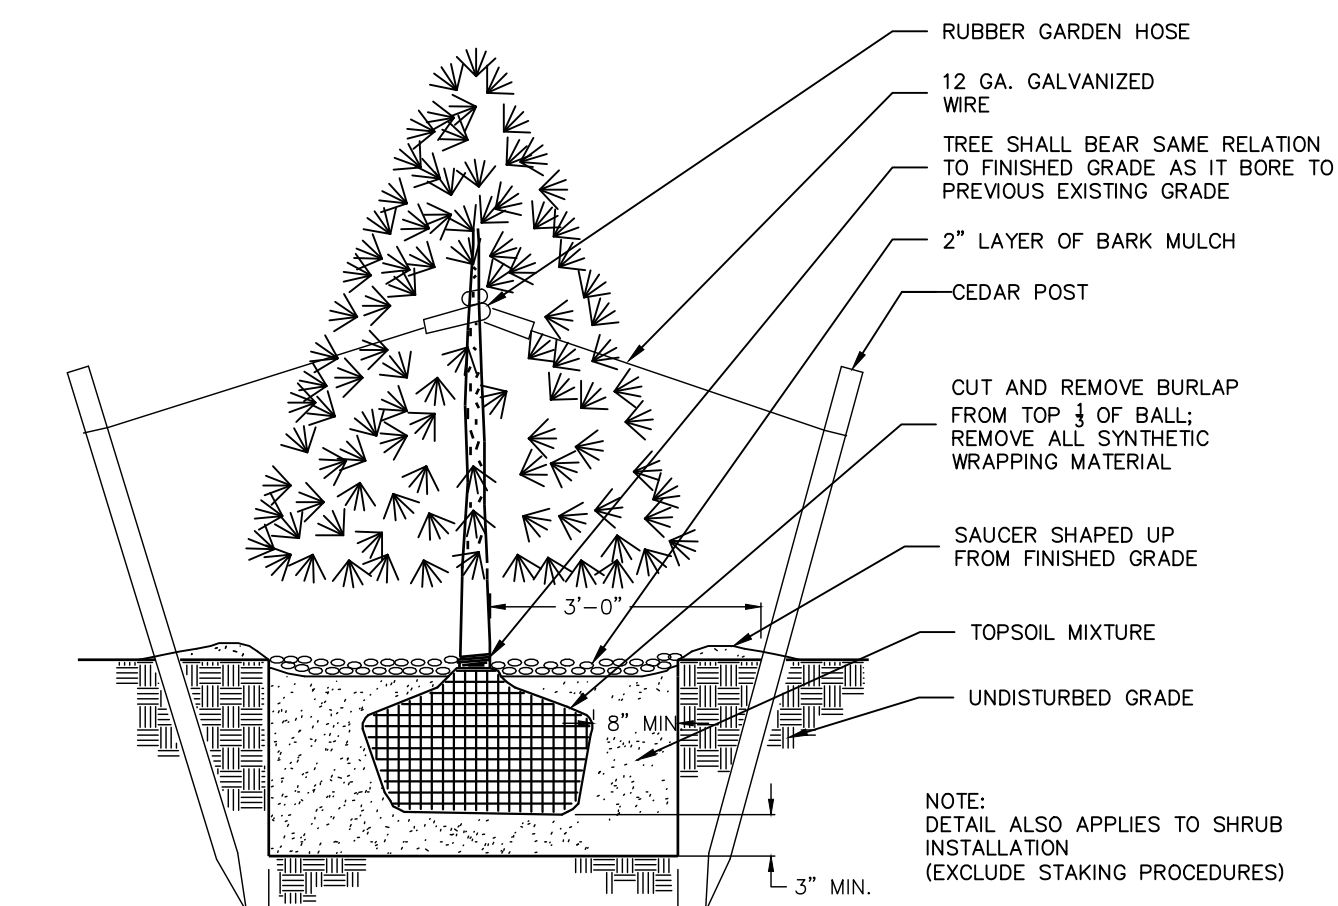


3 CONIFEROUS TREE

14 NOT TO SCALE

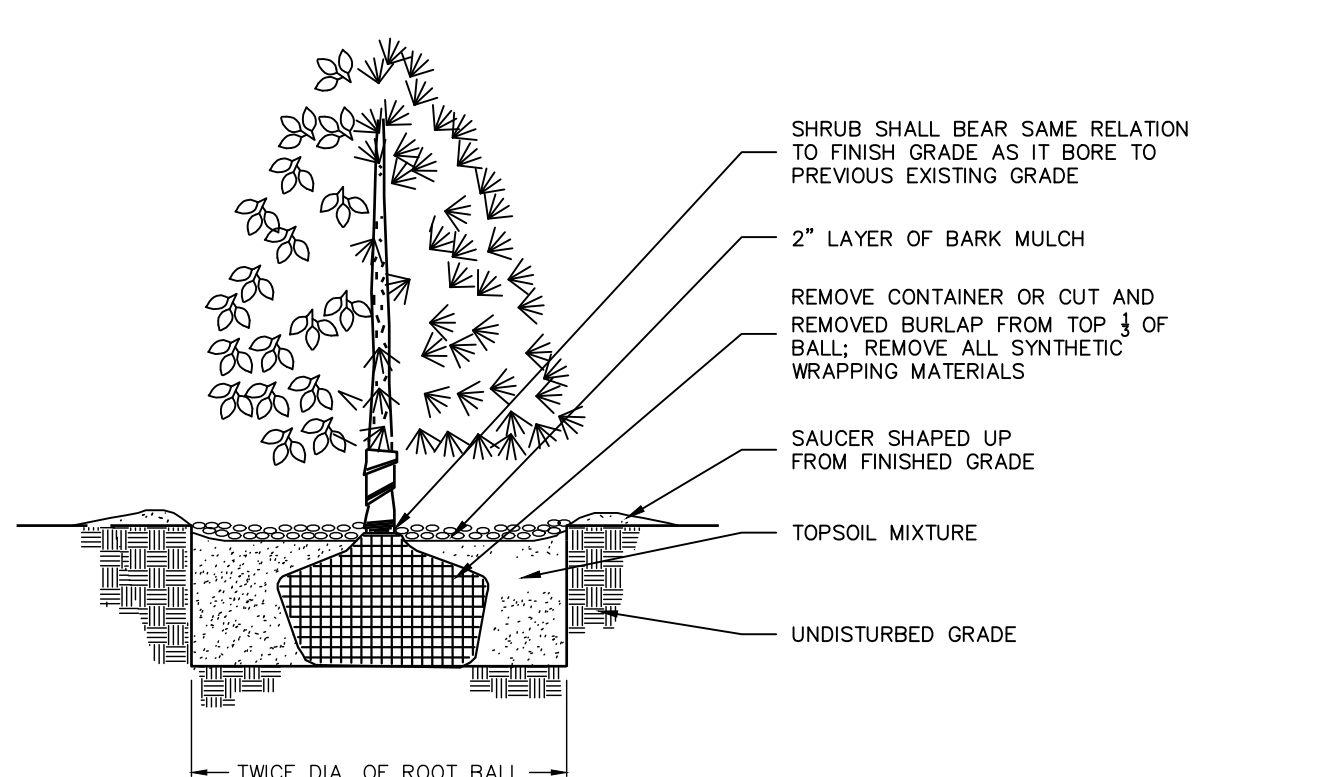

4 SHRUB PLANTING

14 NOT TO SCALE

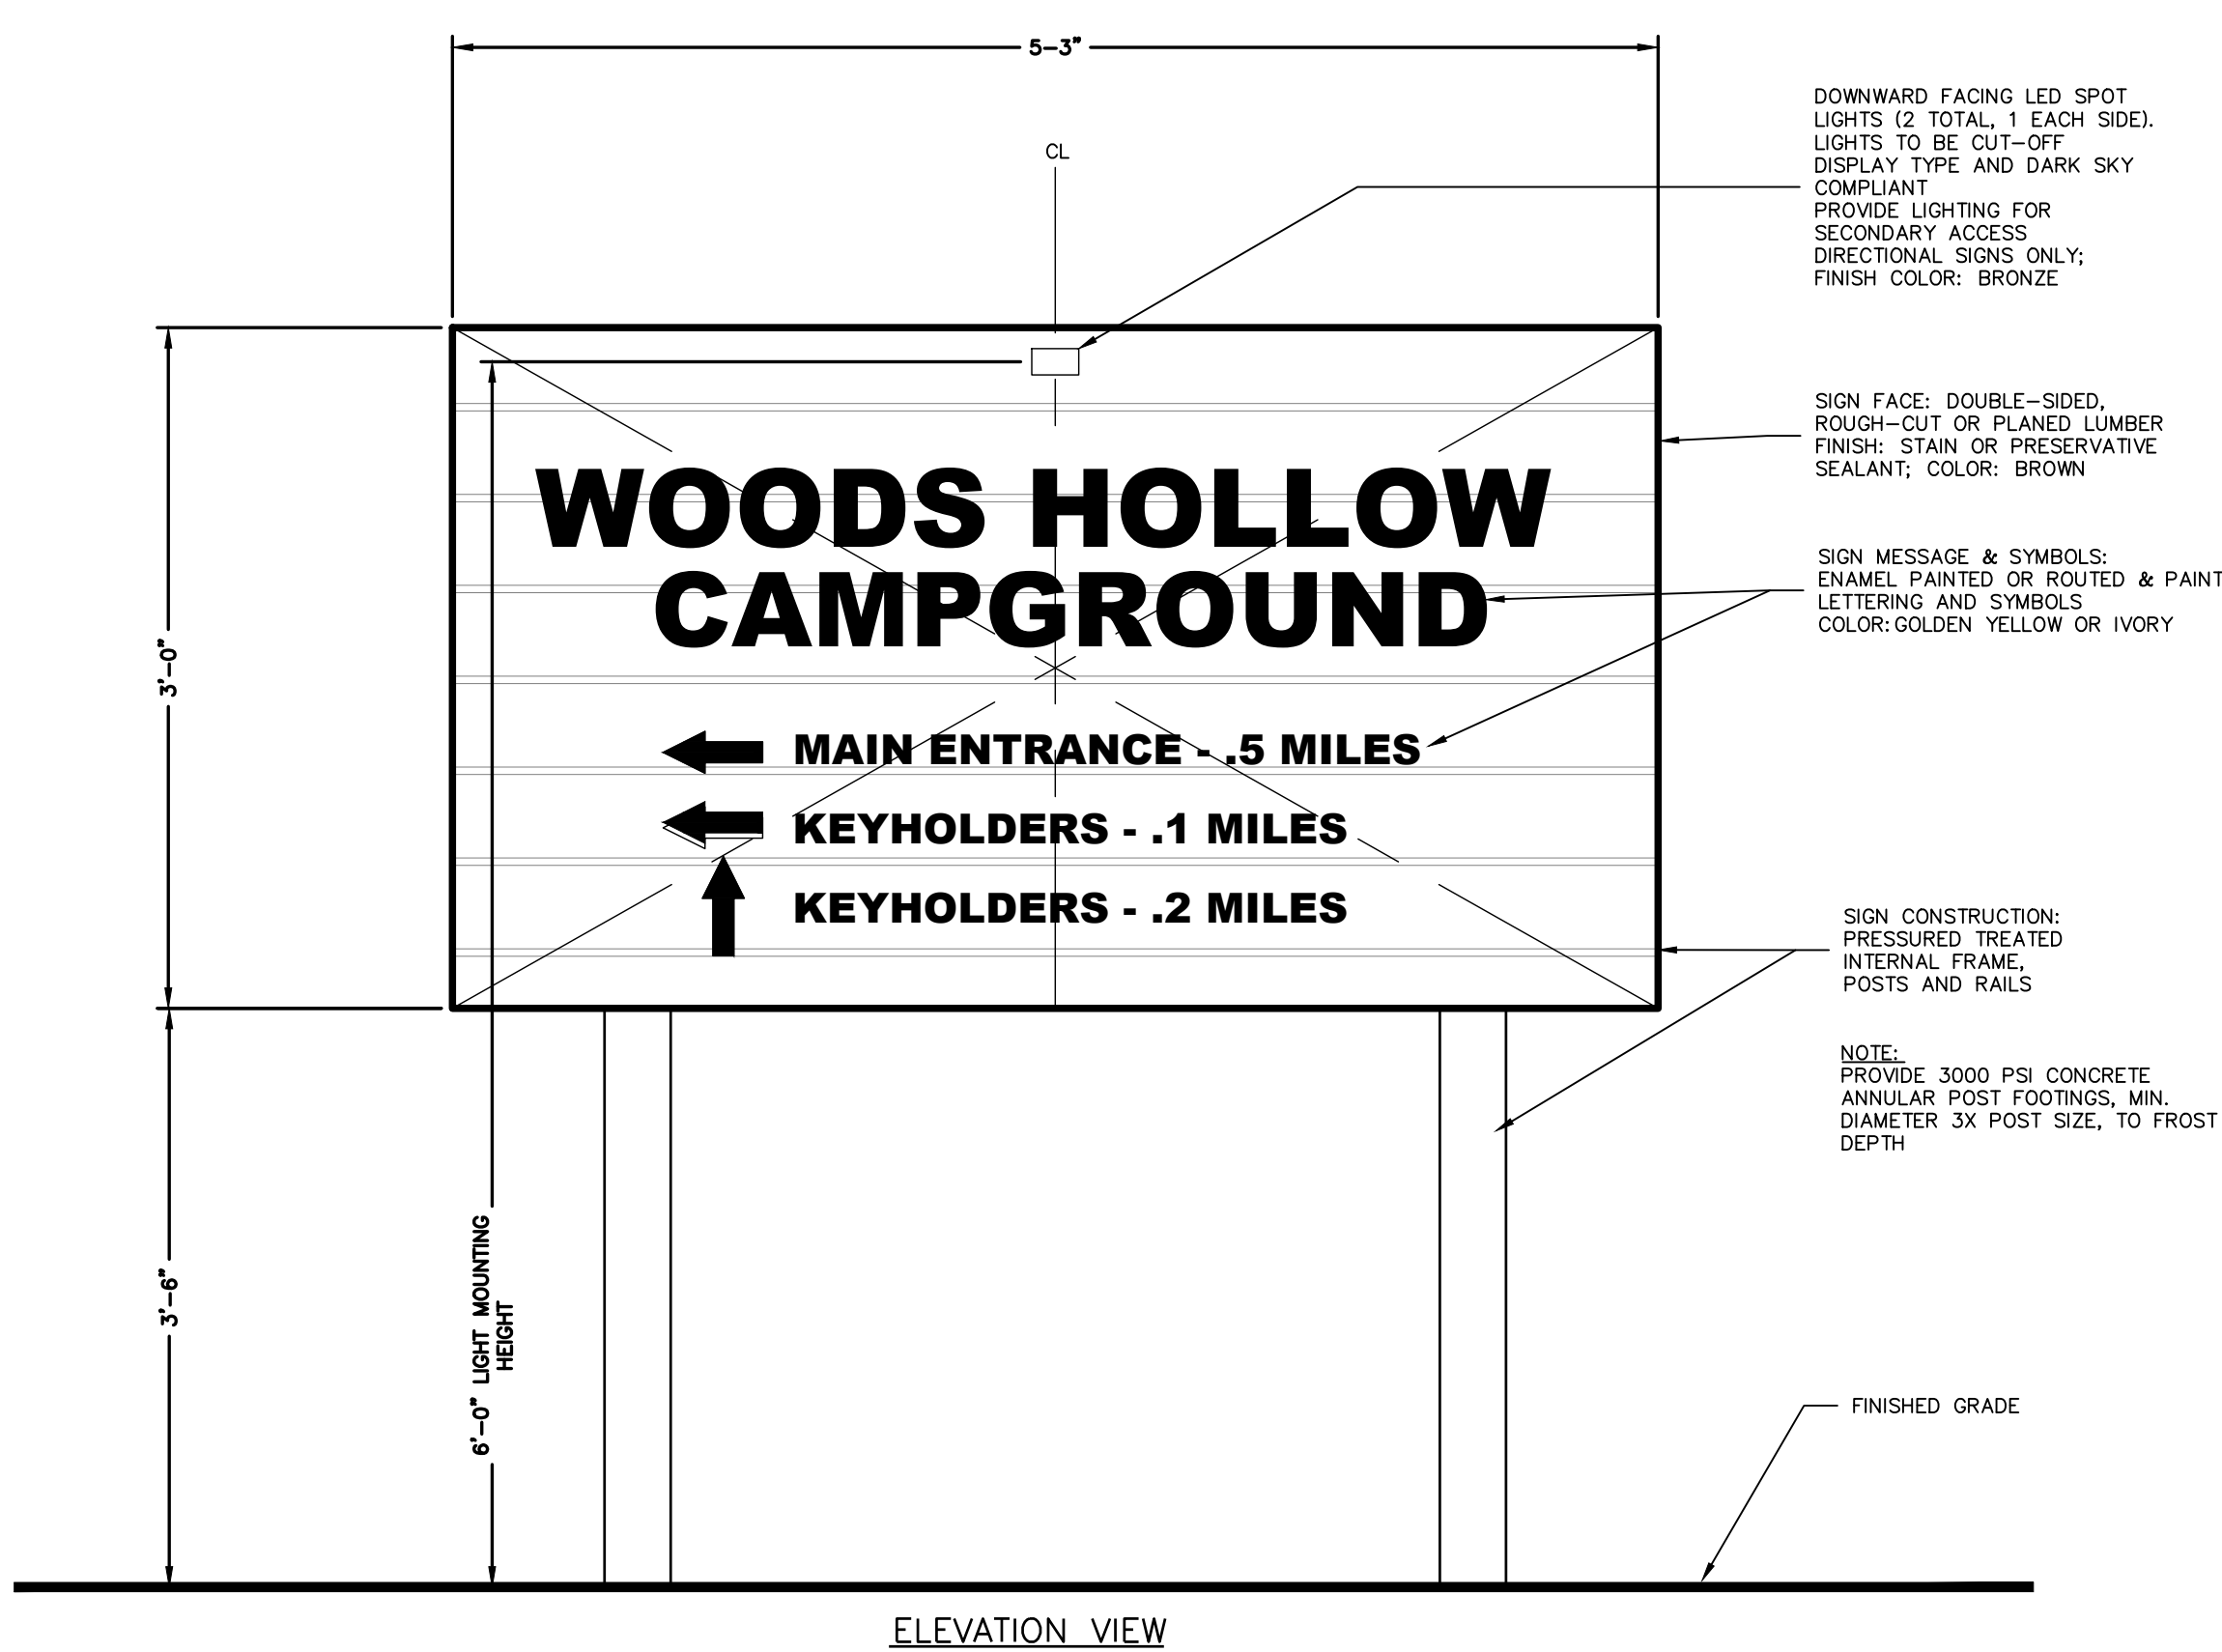

6 DIRECTIONAL SIGN

14 NOT TO SCALE

7 TENT SITE TYPICAL LAYOUT

14 NOT TO SCALE

- NOTES:**
- TENT CAMPING LOTS SHALL VARY IN SIZE BETWEEN 2,500 SF TO 4,500 SF.
 - ALL GRAVEL PADS FOR VEHICLE PARKING SPACES SHALL BE INSTALLED TO MAINTAIN A MINIMUM OF 20 FEET BETWEEN PARKING SPACES.
 - EACH SITE SHALL INCLUDE A MIN. 8'X20' SPACE TO PROVIDE REQUIRED VEHICLE PARKING.



8 PRIMITIVE SITE TYPICAL LAYOUT



14 NOT TO SCALE

- NOTES:**
- PRIMITIVE CAMPING LOTS SHALL VARY IN SIZE BETWEEN 2,500 SF TO 4,500 SF.
 - ALL GRAVEL PADS FOR VEHICLE PARKING SPACES SHALL BE INSTALLED TO MAINTAIN A MINIMUM OF 20 FEET BETWEEN PARKING SPACES.
 - EACH SITE SHALL INCLUDE A MIN. 8'X20' SPACE TO PROVIDE REQUIRED VEHICLE PARKING.
 - PRIMITIVE CAMPING SITES: LIMIT PARKING PAD TO MAXIMUM 30 FT LENGTH.



9 IDENTIFICATION SIGN

14 NOT TO SCALE

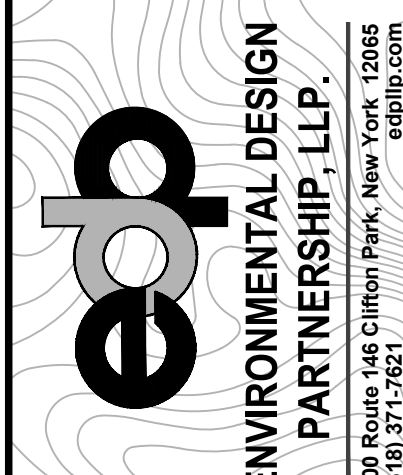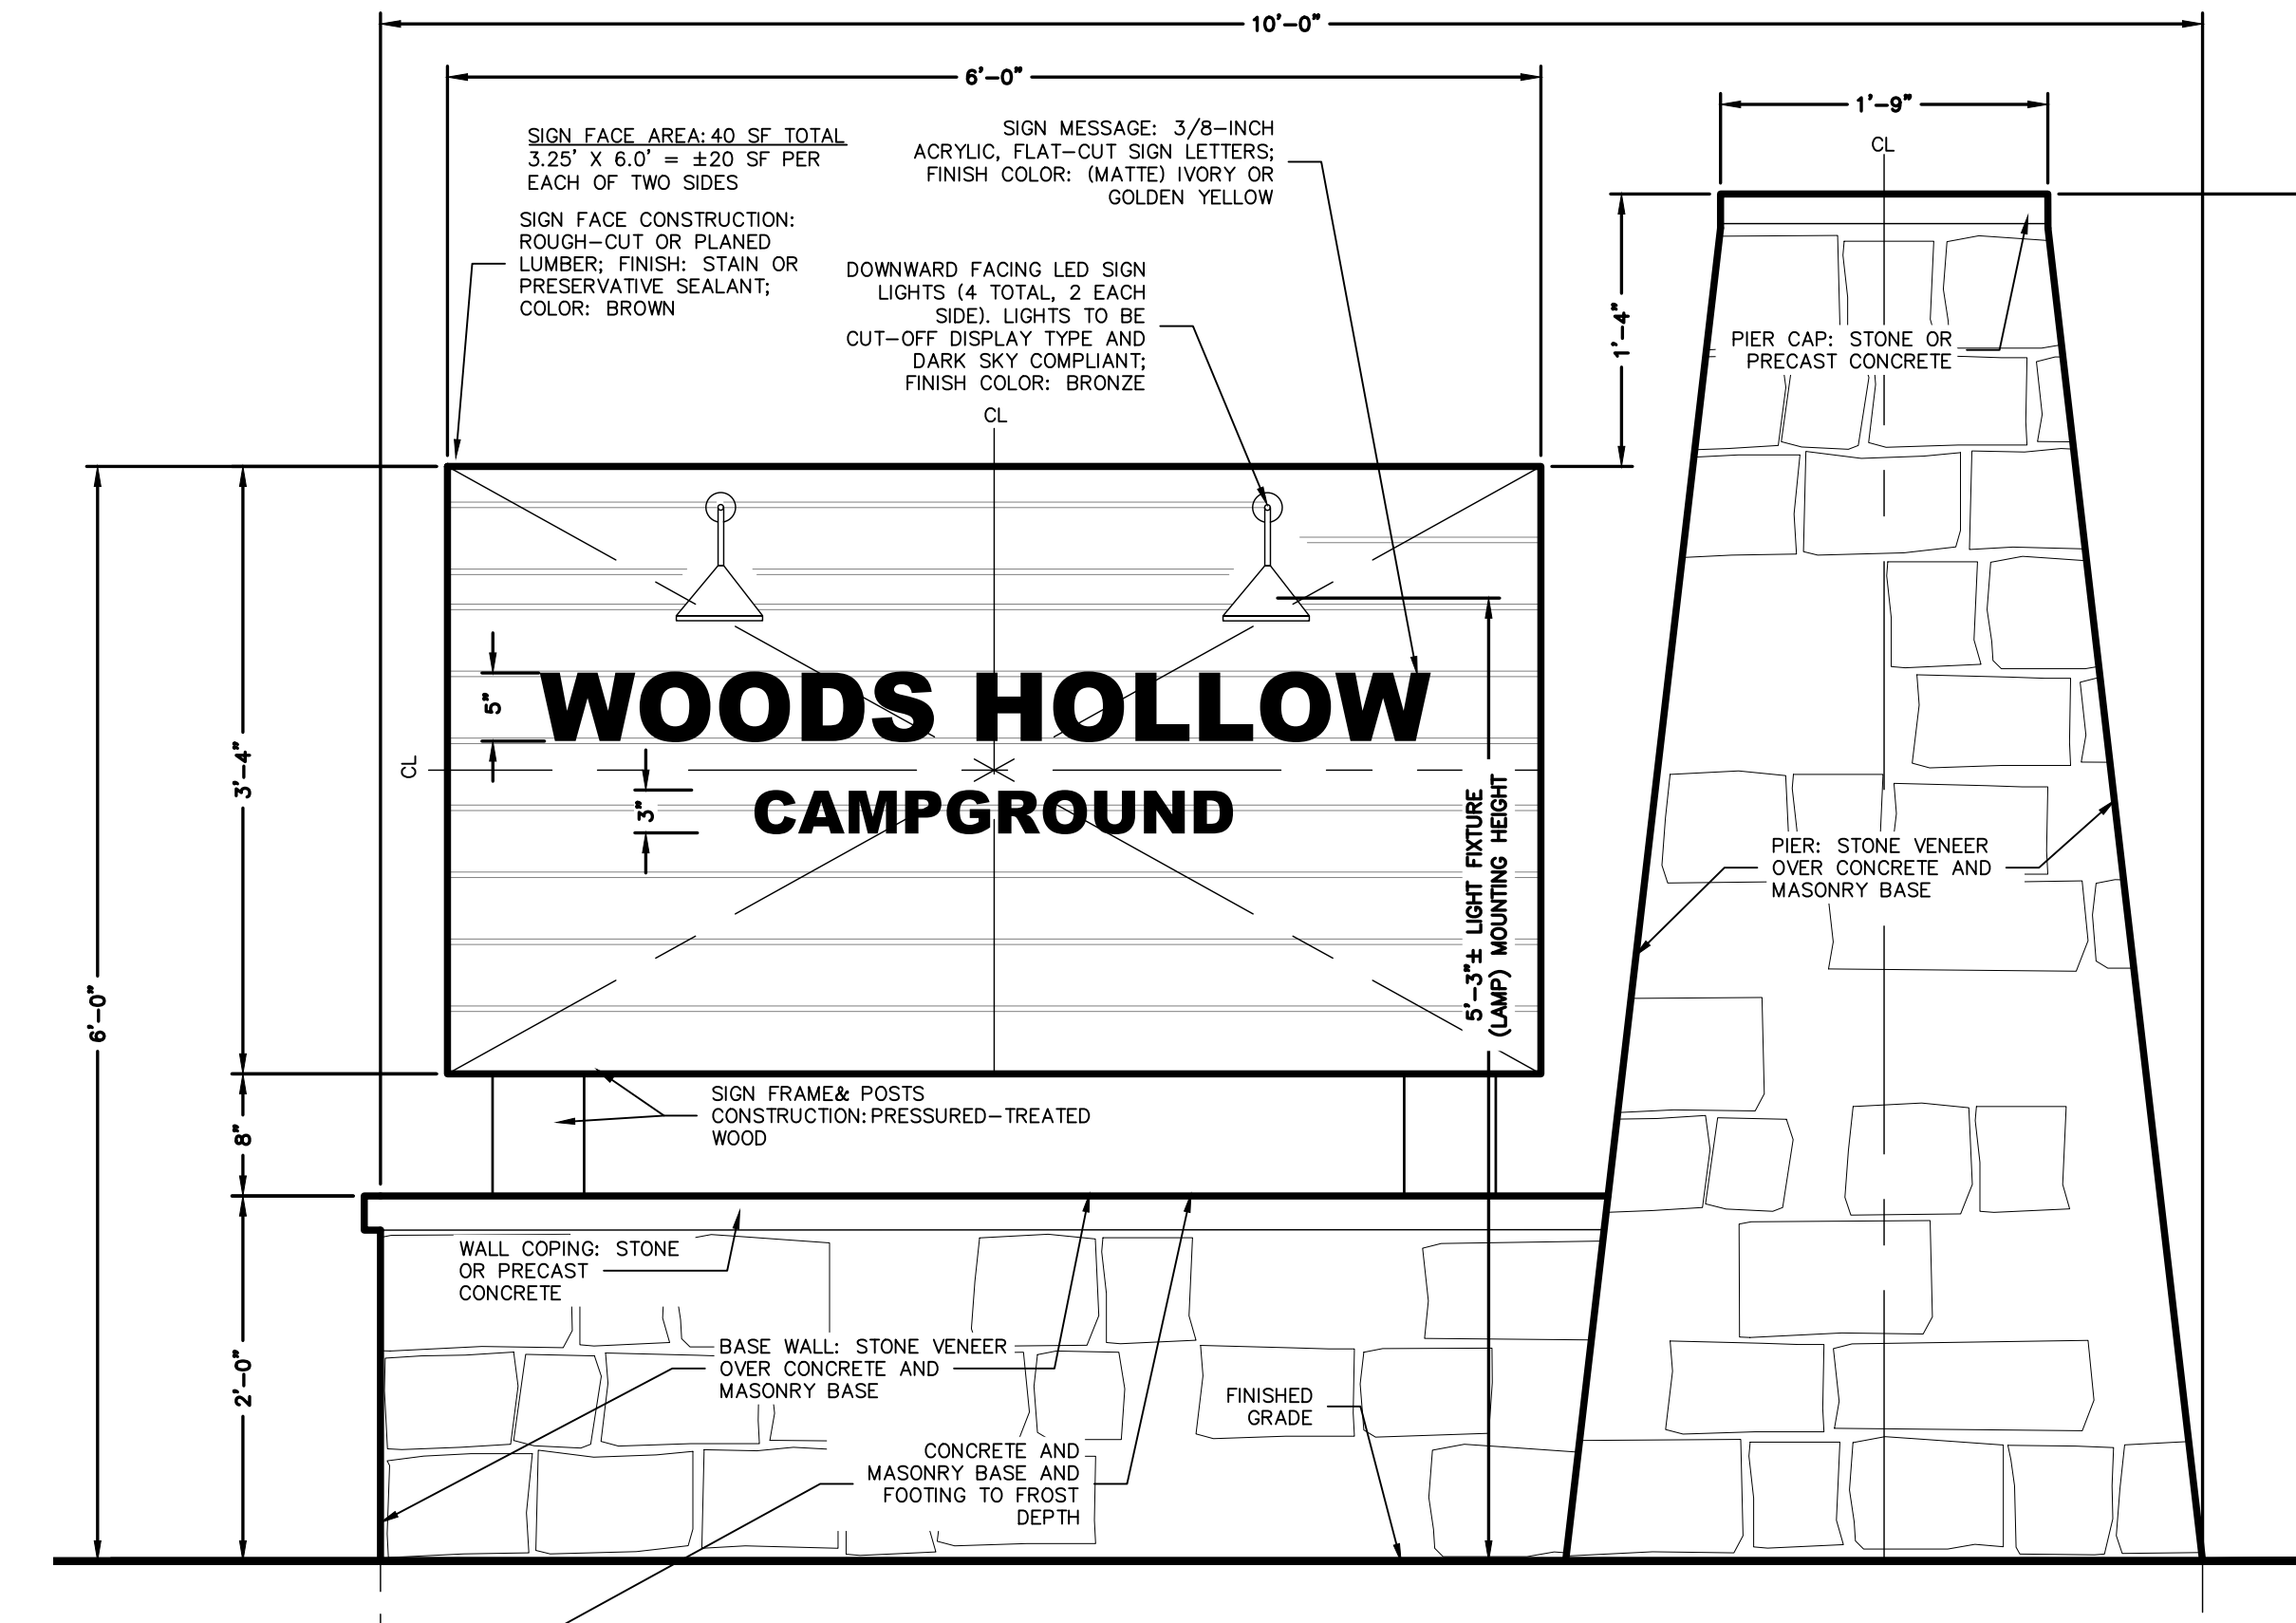

TAX MAP No. 137-4-51, 137-4-52, 137-4-53, 137-4-56
OCTOBER 6, 2021

RV PARK FOR WOODS HOLLOW CAMPGROUND
WOODS HOLLOW MINING COMPANY
WOODS HOLLOW ROAD
TOWN OF MAYFIELD
FULTON COUNTY, NEW YORK

DATE	BY	REVISION
1/21/22	TM	REVISION FOR MARKING COMMENTS
7/21/22	TM	SUBMITAL TO APA
8/16/22	TM	SUBMITAL TO APA AND DDH









FINAL
P2022-0008

SCALE: AS NOTED

NOT FOR CONSTRUCTION

SHEET TITLE: PLANTING AND SIGN DETAILS

SHEET: 14 of 19

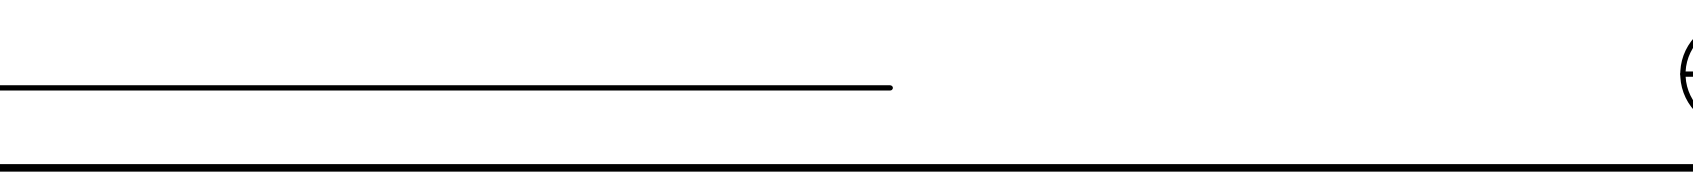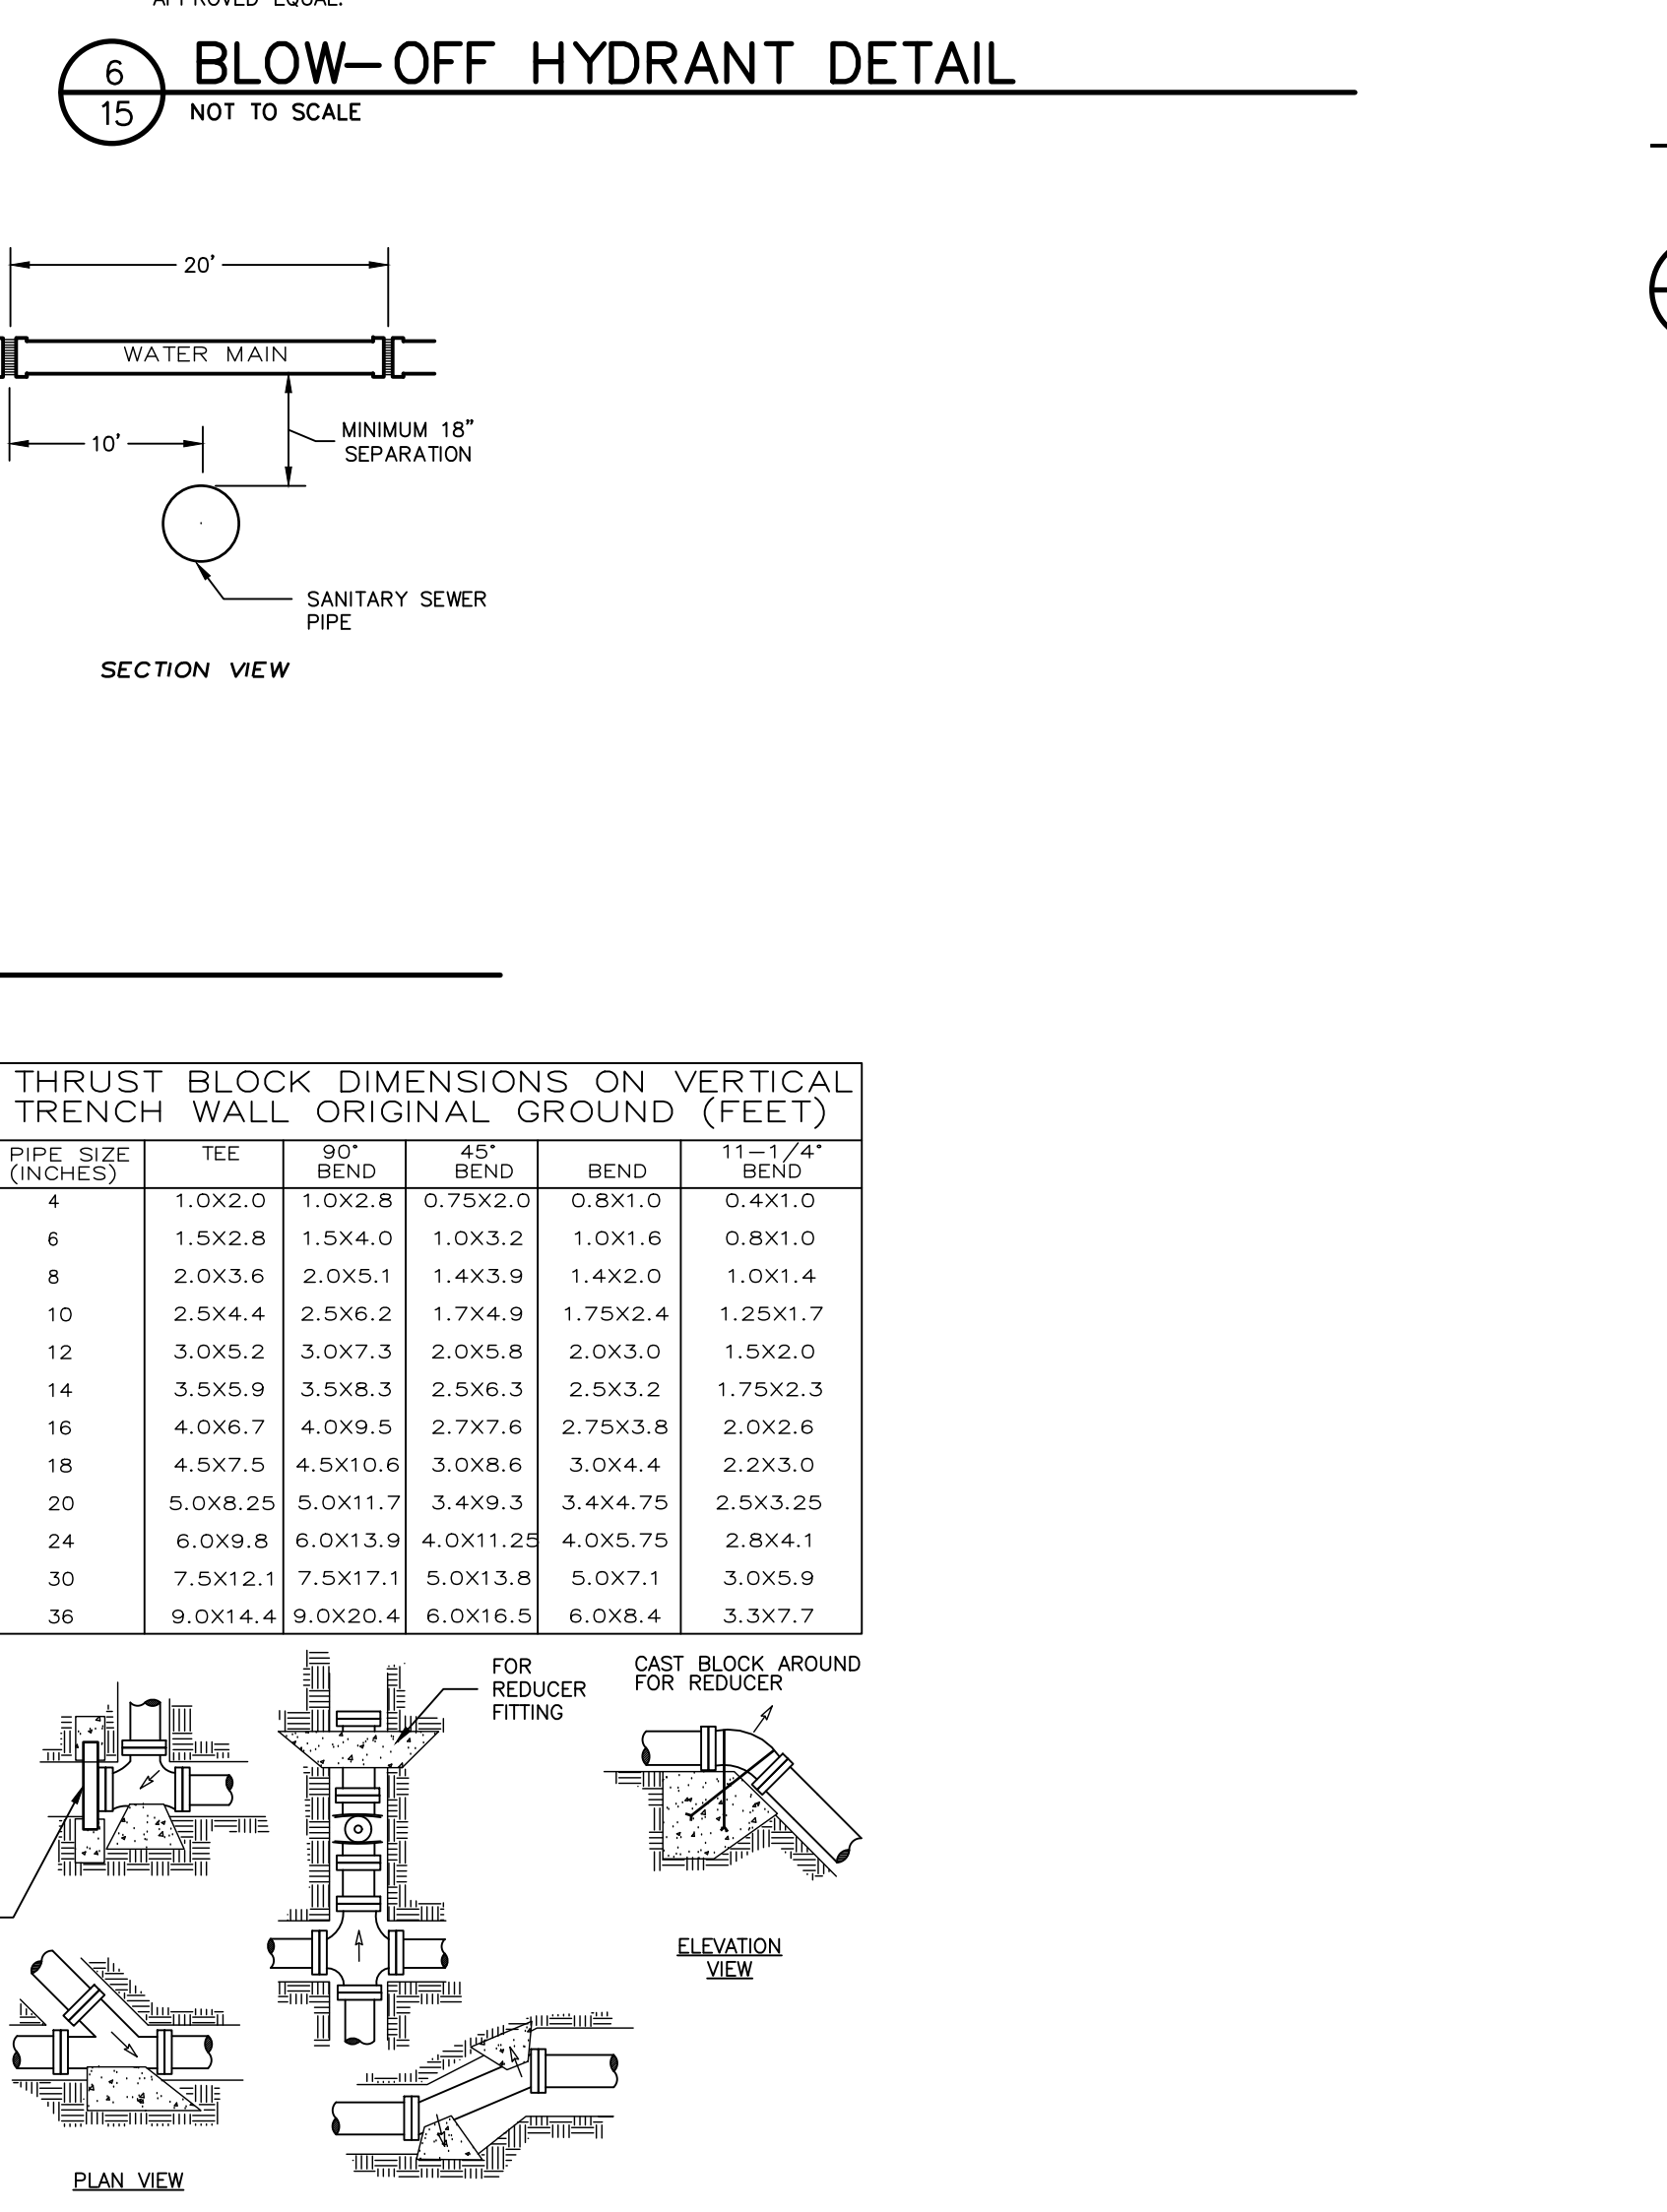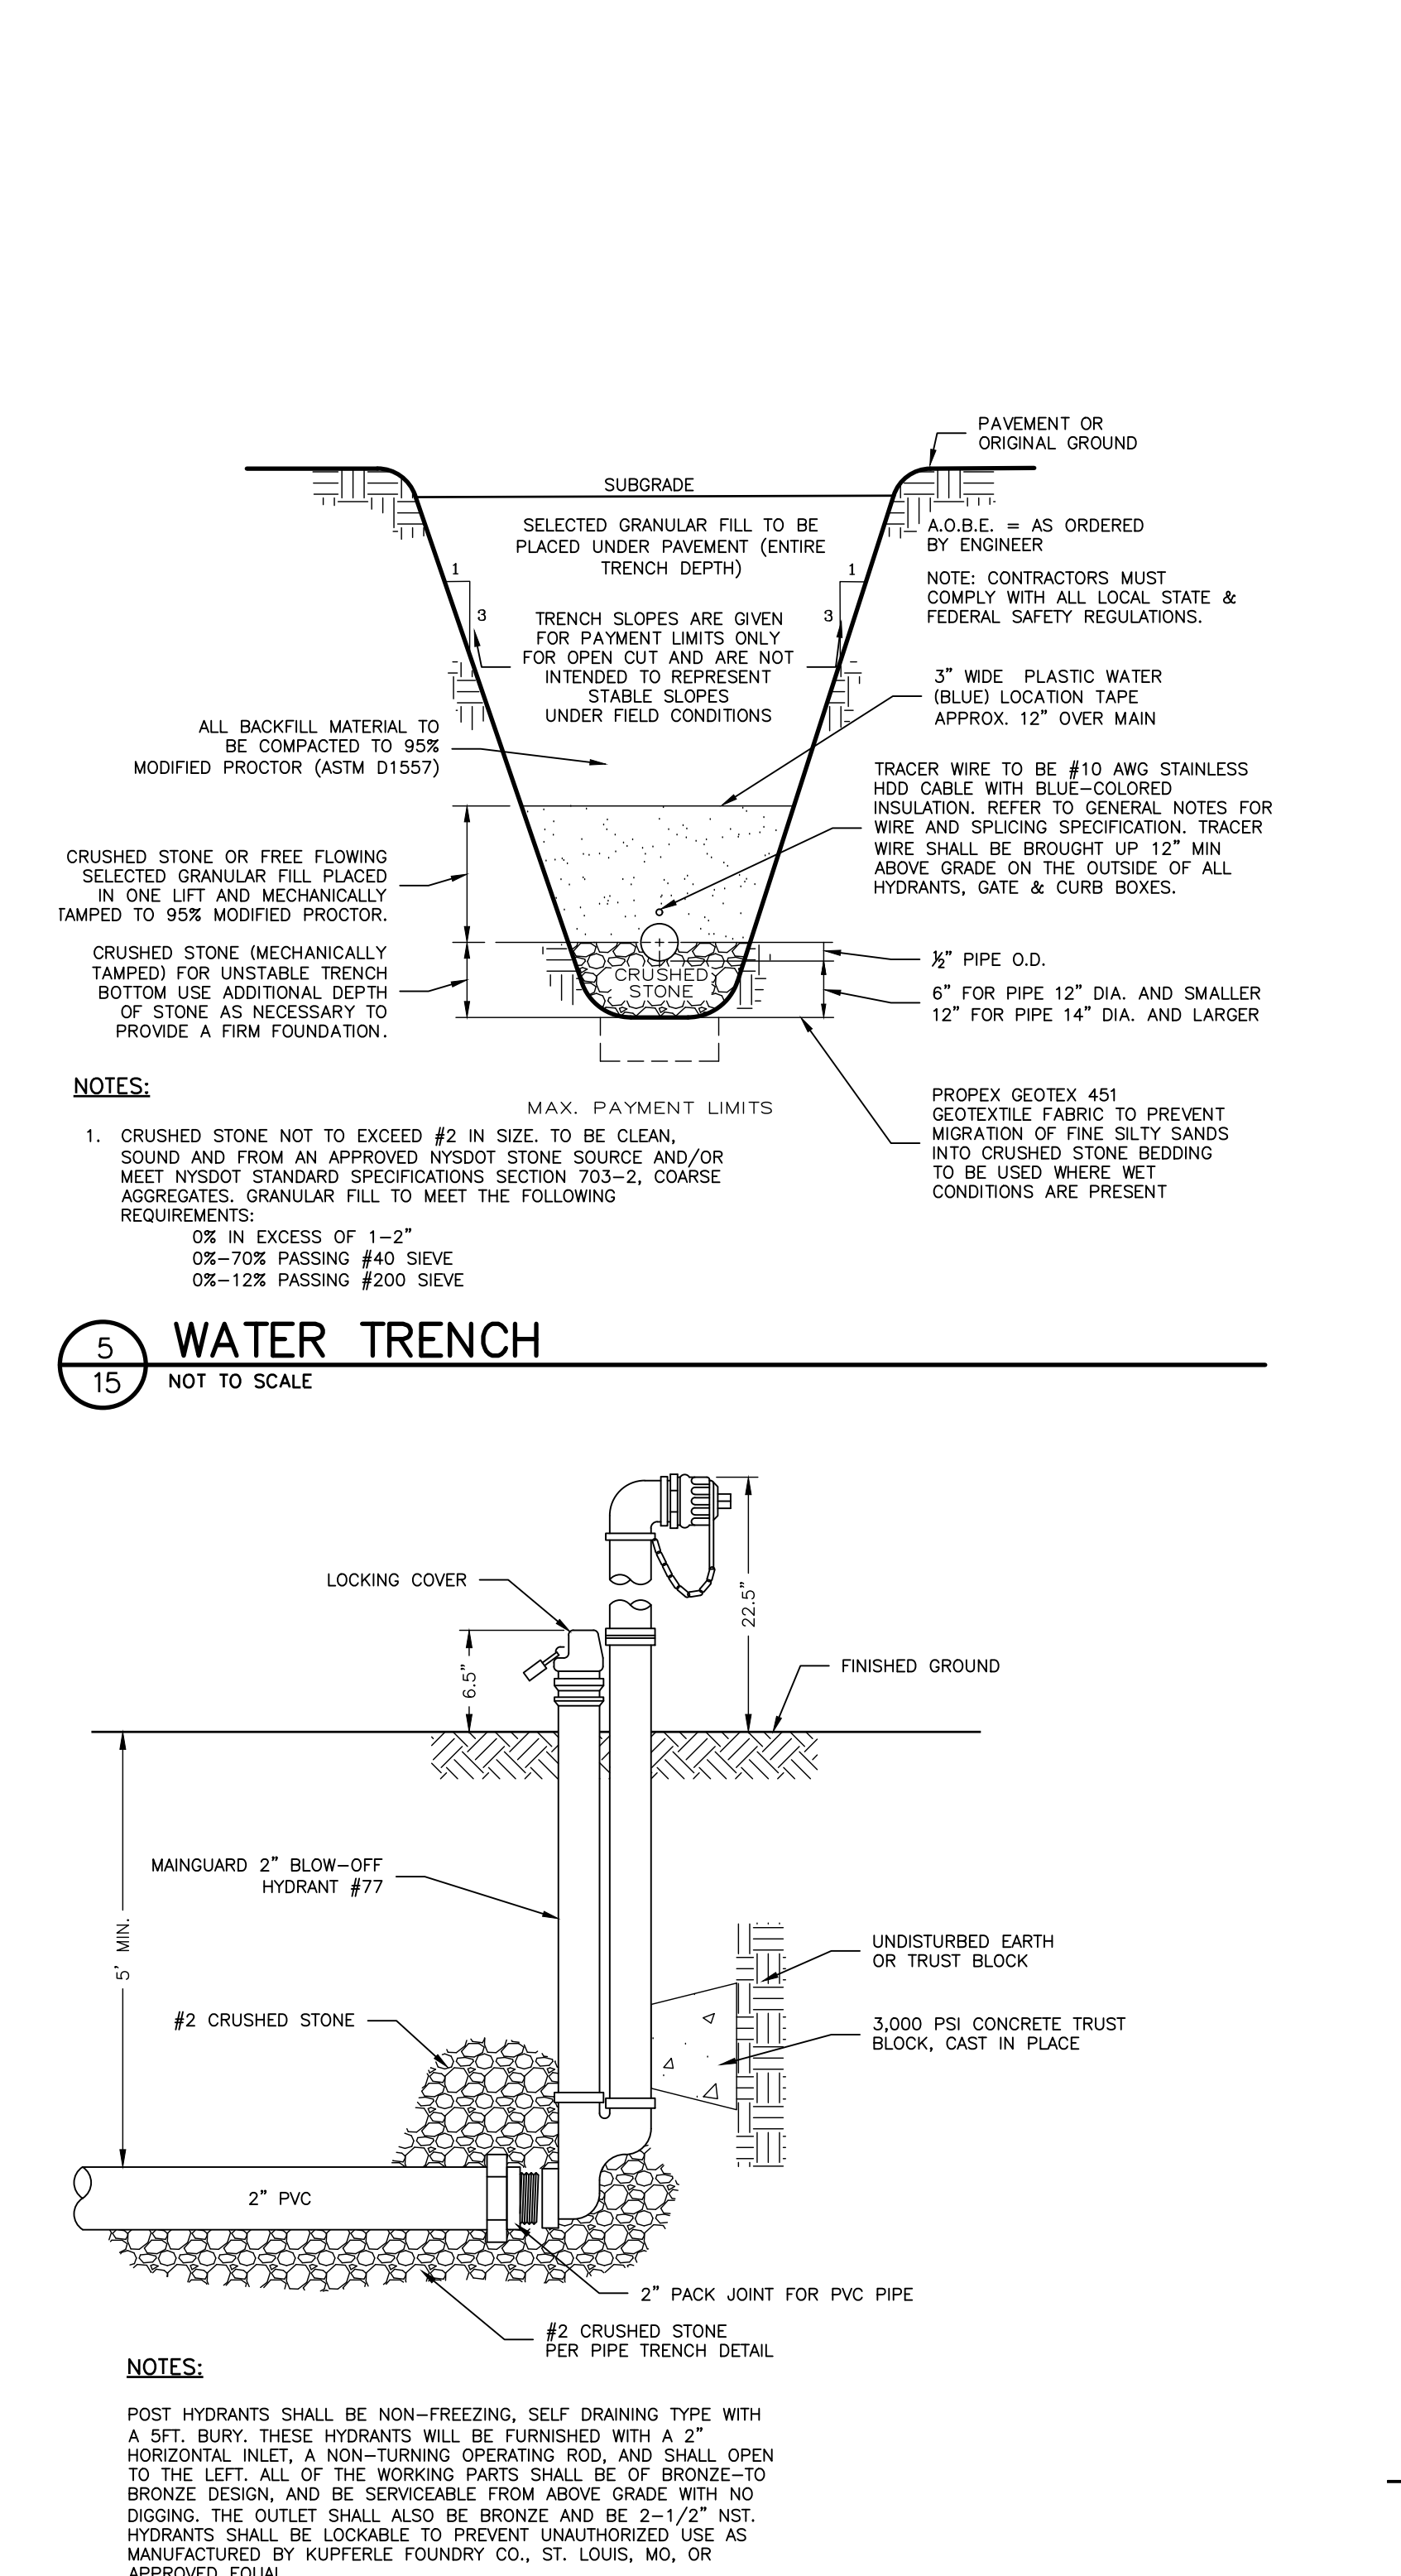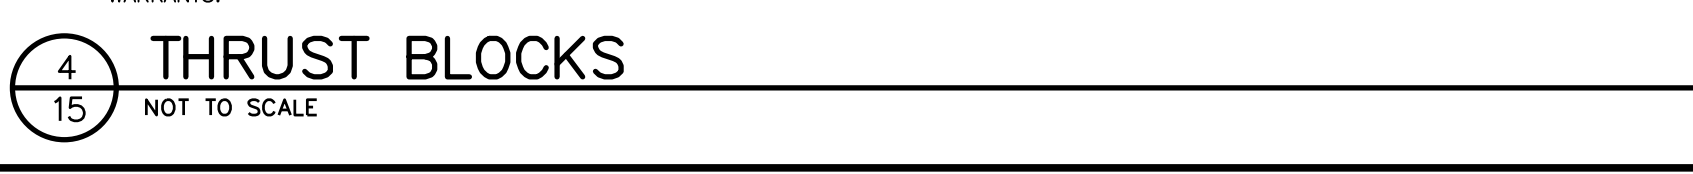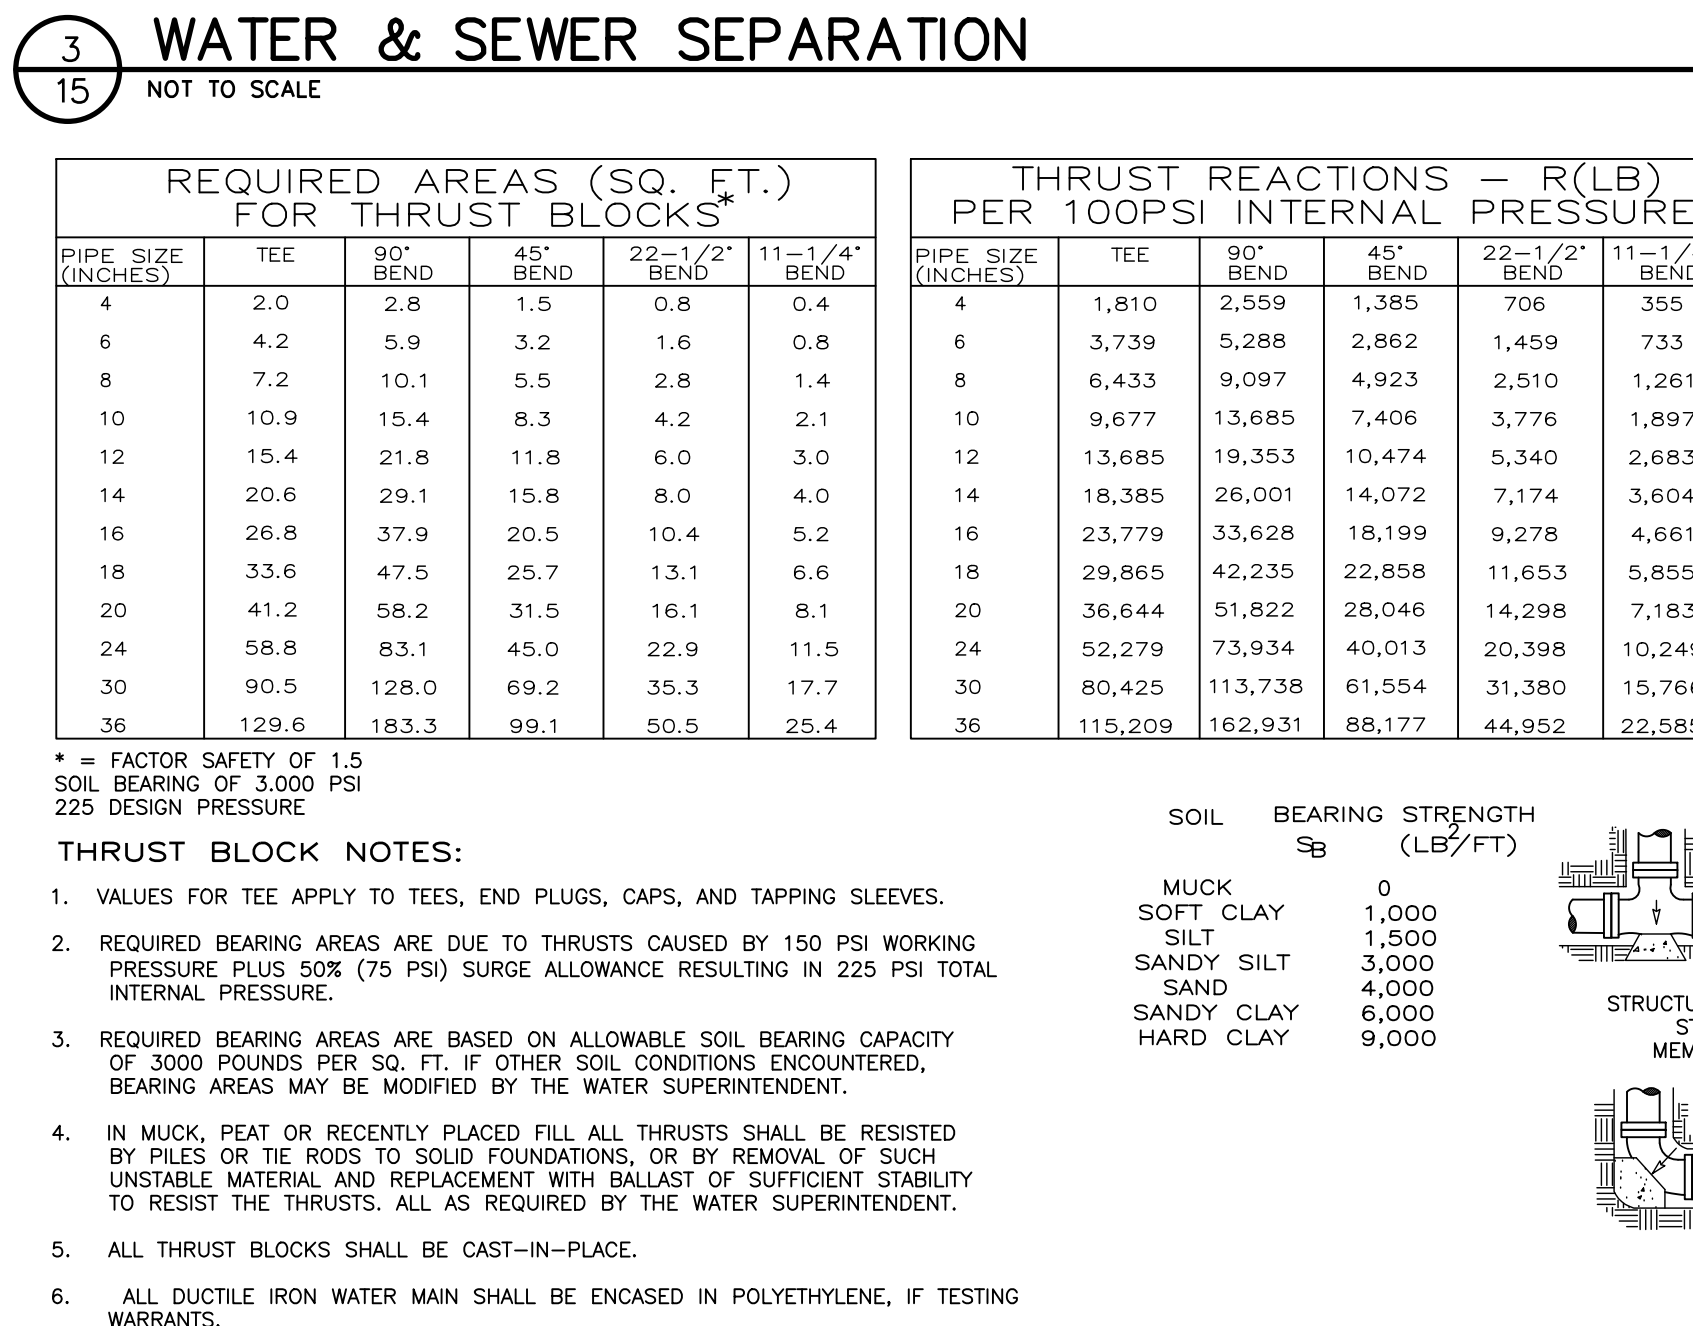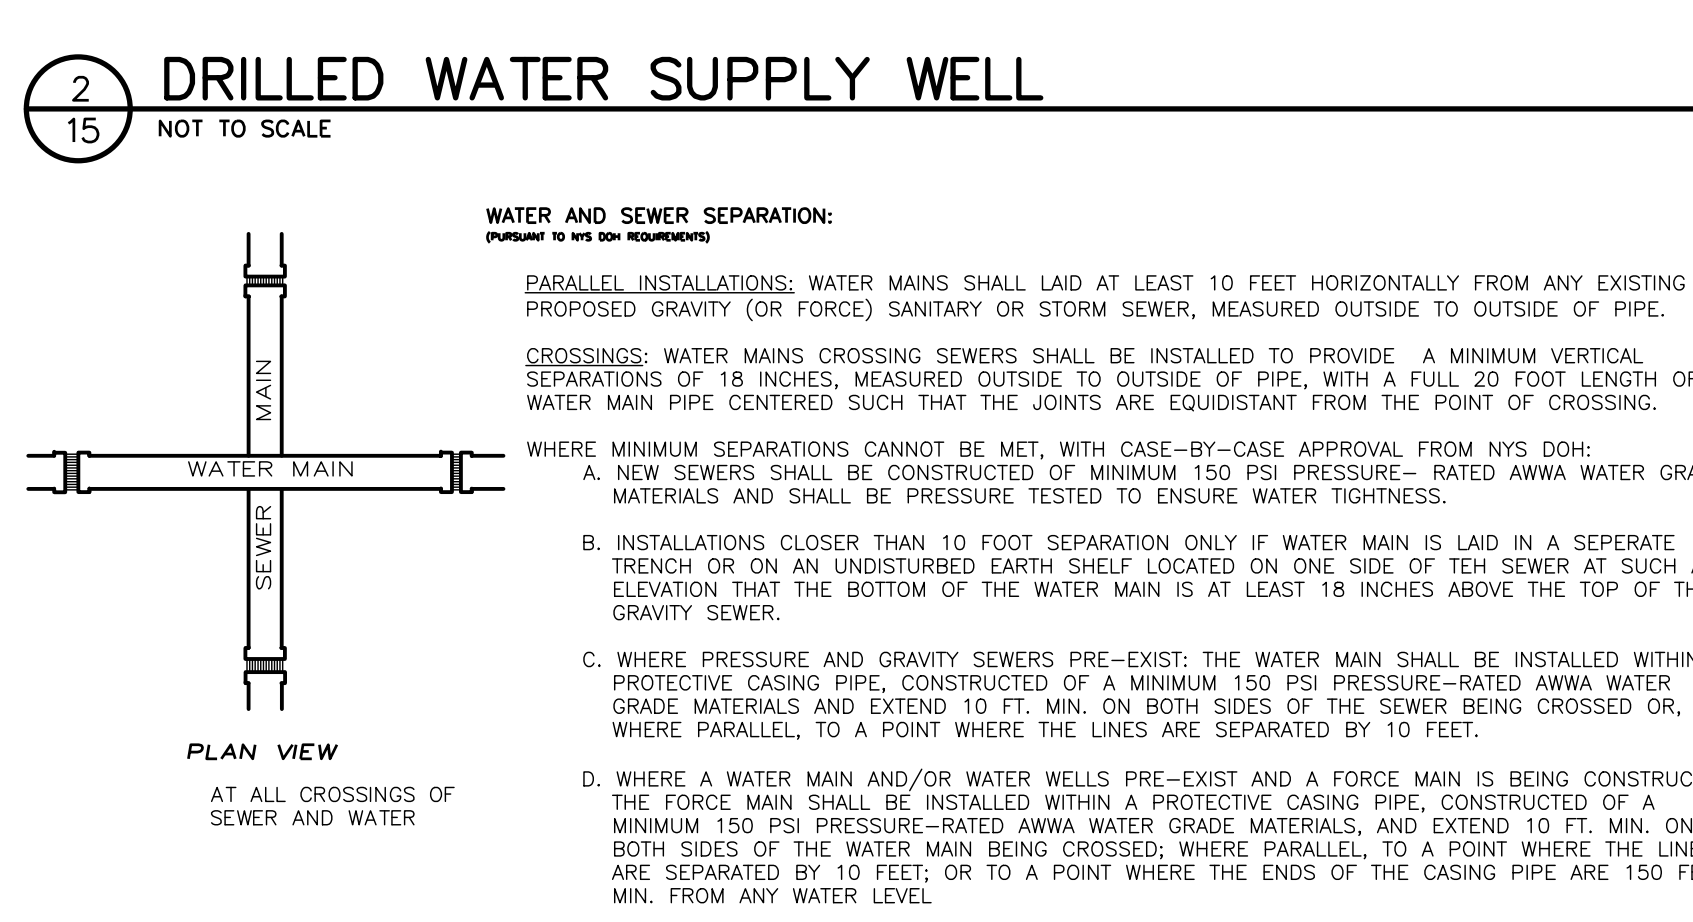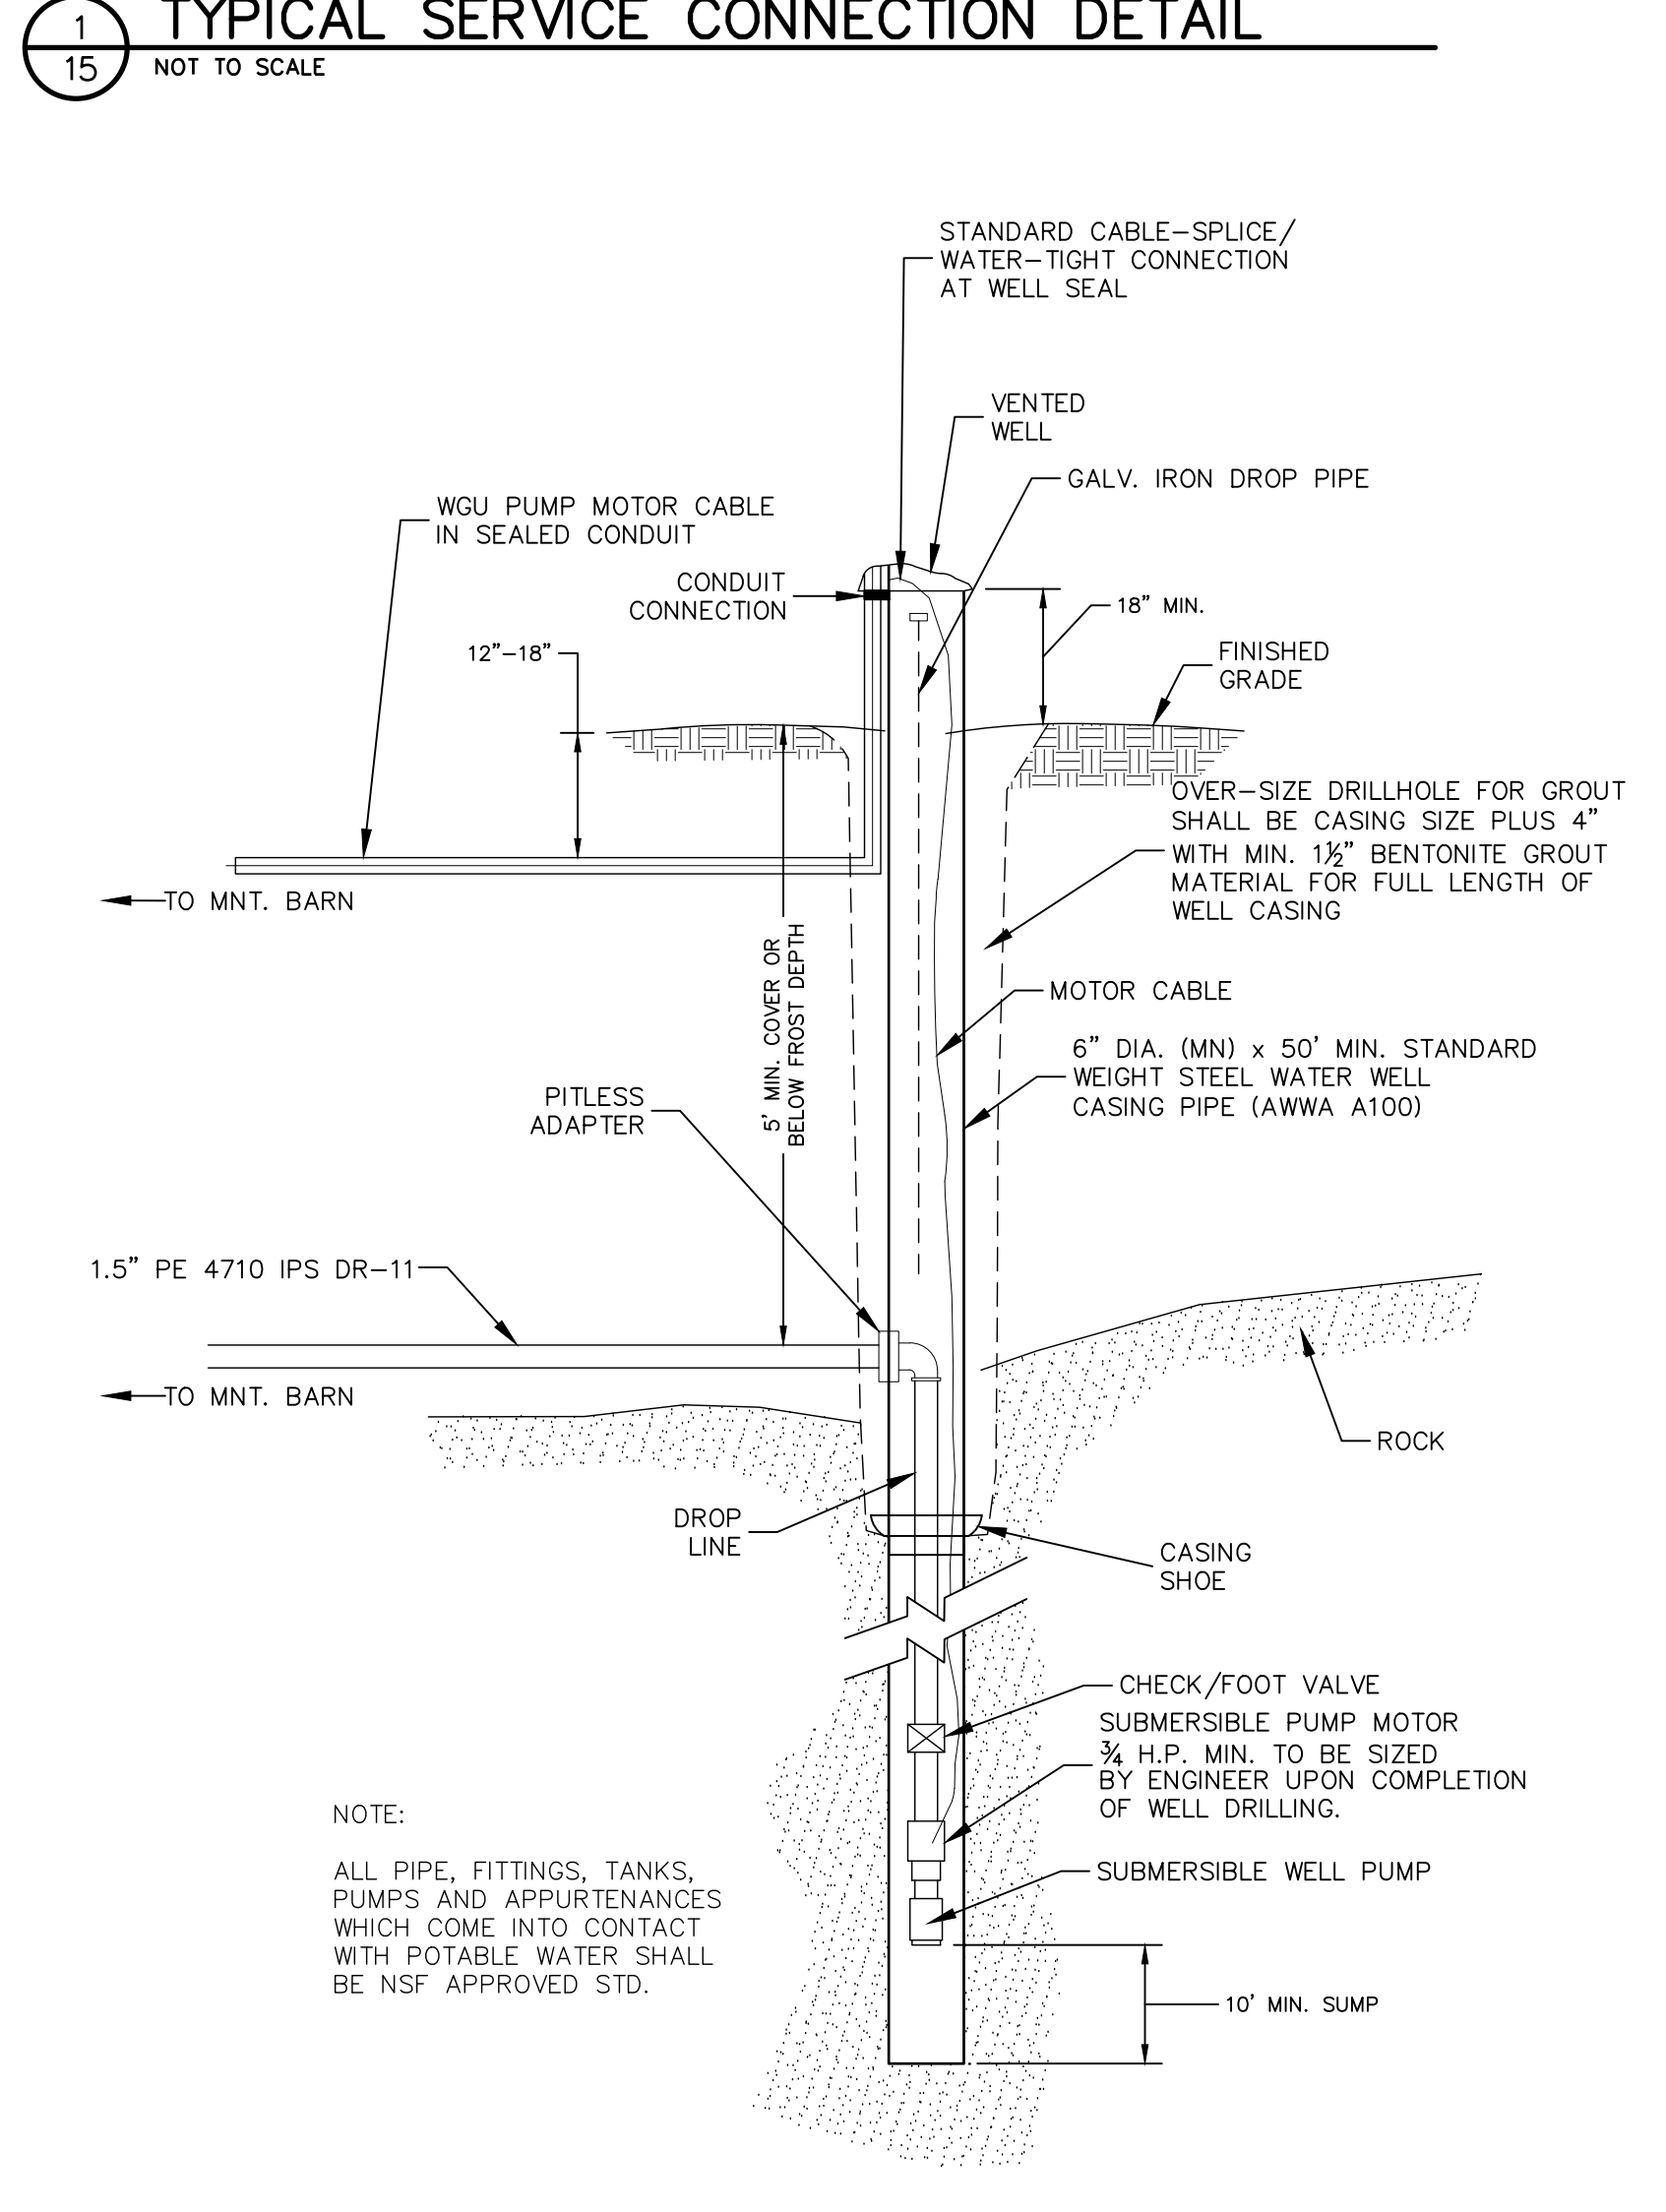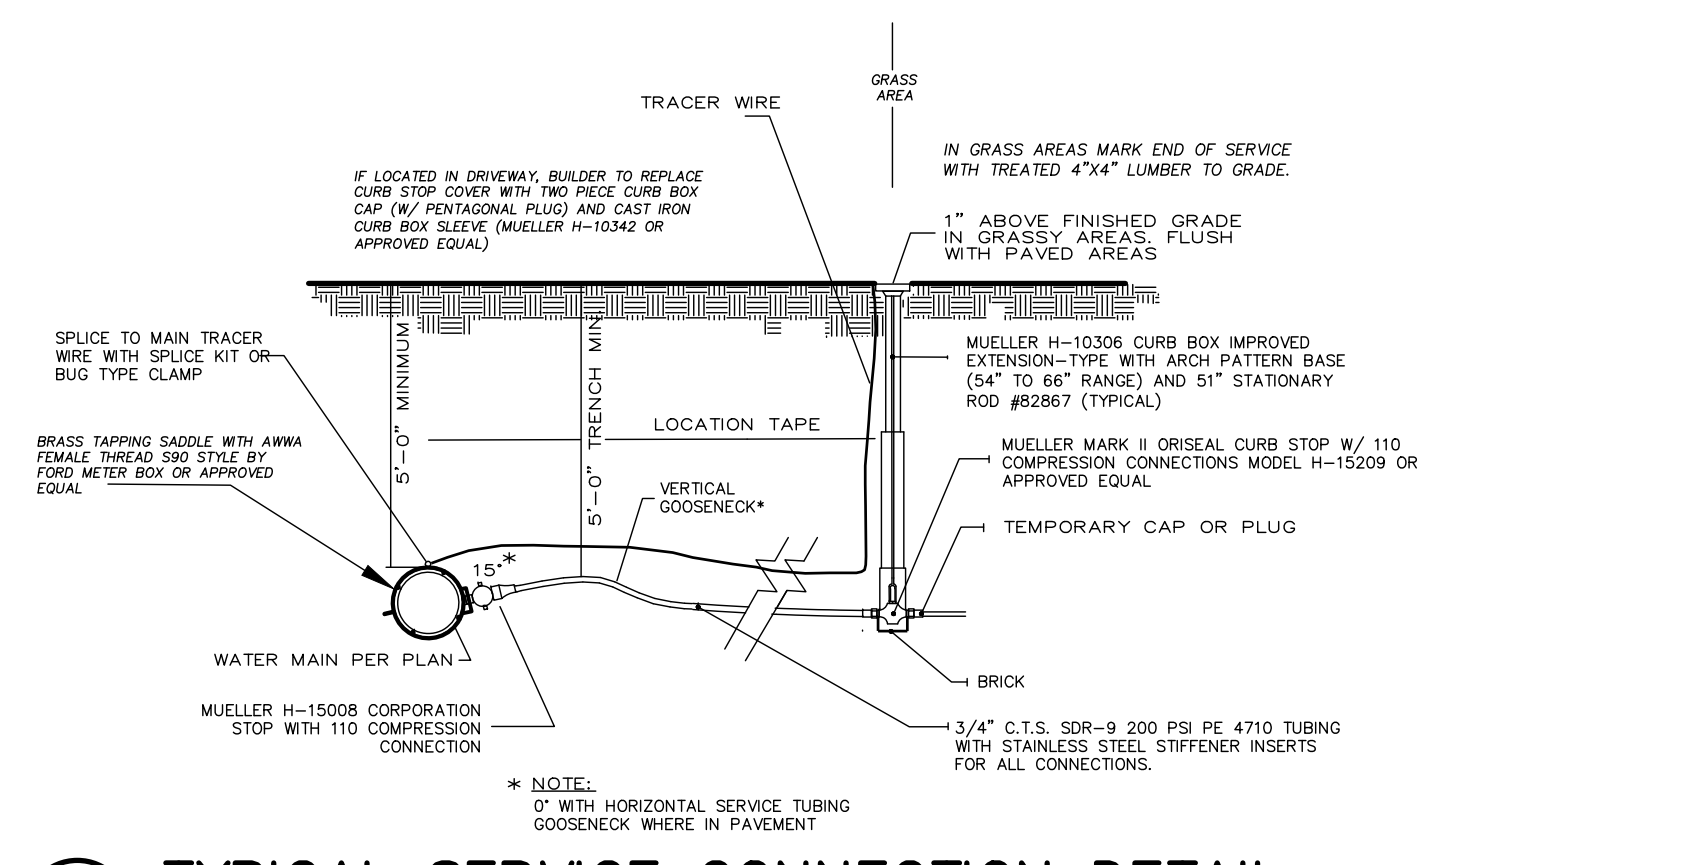

DISINFECTION PROCEDURE

DISINFECTION: ALL POTABLE WATER PIPE SHALL BE DISINFECTED AND BACTERIOLOGICALLY VERIFIED (TESTED) PRIOR TO USE IN ACCORDANCE WITH AWWA C601-14, AS FOLLOWS:

DISINFECTION PROCEDURE:

NEW MAINS SHALL BE DISINFECTED IN ACCORDANCE WITH THE CURRENT AWWA STANDARD FOR DISINFECTING WATER MAINS, AND AWWA C601-14, SECTION 4.4. CONTINUOUS FEED THE TABLET METHOD IS NOT PERMITTED BY NYS/DOH AND SHALL NOT BE USED. THE SLUG METHOD, SECTION 4.5, MAY BE USED WHEN APPROVED BY THE ENGINEER. SPRAY OR SWAB, PER PARAGRAPH 4.11.3.2, WHEN CUTTING INTO OR REPAIRING EXISTING MAINS. REQUIRED STEPS ARE:

- WORK CLEAN: PREVENT CONTAMINATING MATERIALS FROM ENTERING THE WATER MAIN DURING STORAGE, CONSTRUCTION, OR REPAIR.
- PREVENT BACKFLOW: PROTECT THE EXISTING DISTRIBUTION SYSTEM FROM ANY BACKFLOW CAUSED BY HYDROSTATIC PRESSURE TESTING AND DISINFECTION PROCEDURES. THE SUPPLY VALVE SHALL BE KEPT CLOSED AT ALL TIMES, EXCEPT DURING FLUSHING AND DISINFECTANT FEED OPERATIONS.
- PRE-FLUSH:
 - FILL THE WATER MAIN AND ELIMINATE ALL AIR POCKETS.
 - FLUSH THE WATER MAIN AT A VELOCITY NOT LESS THAN 2.5 FT/SEC TO REMOVE PARTICULATES.
- DOSE CHLORINE (CONTINUOUS METHOD):
 - INSTALL A TEST TAP NOT MORE THAN 10 FT. DOWNSTREAM FROM THE BEGINNING OF THE NEW MAIN.
 - TO WATER ENTERING THE NEW MAIN, FEED A DOSE OF CHLORINE AT A CONSTANT RATE SUCH THAT THE WATER SHALL HAVE A RESIDUAL NOT LESS THAN 25 MG/L OF FREE CHLORINE. VERIFY CHLORINE CONCENTRATIONS AT ALL HYDRANTS, TAPS, AND SERVICE LATERALS. DOING SHALL CONTINUE UNTIL HEAVILY CHLORINATED WATER IS CONTINUOUS THROUGHOUT THE NEW MAIN AND ALL VALVES AND HYDRANTS HAVE BEEN OPERATED TO PROVIDE CHLORINE CONTACT.
- CONTACT TIME: AFTER A 24-HOUR MINIMUM RETENTION PERIOD, THE TREATED WATER SHALL HAVE A RESIDUAL OF NOT LESS THAN 10 MG/L OF FREE CHLORINE. VERIFY CHLORINE CONCENTRATIONS AT ALL HYDRANTS, TAPS, AND SERVICE LATERALS. REPEAT STEP 4.B. IF RESIDUAL IS LESS THAN 10 MG/L.
- FLUSH/NEUTRALIZE: FLUSH THE HEAVILY CHLORINATED WATER FROM THE MAIN UNTIL A RESIDUAL OF NOT MORE THAN 1.0 MG/L REMAINS. APPLY A NEUTRALIZING CHEMICAL TO ELIMINATE THE RESIDUAL CHLORINE IF THERE IS ANY POSSIBILITY THAT HEAVILY CHLORINATED WATER DISCHARGE WILL CAUSE DAMAGE TO THE ENVIRONMENT.
- BACTERIOLOGICAL VERIFICATION PER SECTION 5.1: TWO CONSECUTIVE SETS OF ACCEPTABLE SAMPLES, TAKEN FROM THE SAME SAMPLING SITES, A MINIMUM OF 18 HOURS APART, SHALL BE COLLECTED FROM THE WORKS AS FOLLOWS: ONE SET PER 1200 LF OF NEW MAIN PLUS ONE SET FROM THE END-OF-THE-LINE AND ONE SET FROM EACH BRANCH. EACH SAMPLE SHALL BE TESTED FOR BOTH HPC (HETEROLOGIC PLATE COUNT) AND TOTAL COLIFORM (TC). THE HPC TEST IS WAIVED FOR THE GREAT SAMPLES IF THE INITIAL RESULTS ARE LESS THAN 500 CFU/ML. WHEN HPC RESULTS EXCEED 500 CFU/ML, THE WORKS SHALL BE FLUSHED AND SAMPLED UNTIL NO COLIFORM ARE PRESENT AND THE HPC IS LESS THAN 500 CFU/ML. IF REPEAT SAMPLES FAIL, THE MAIN SHALL BE RECHLORINATED, FLUSHED AND SAMPLED UNTIL SATISFACTORY RESULTS ARE OBTAINED. ALL TEST RESULTS SHALL BE FURNISHED TO THE ENGINEER.

WATER NOTES:

- ALL PIPE MATERIALS AND APPURTENANCES ARE SUBJECT TO APPROVAL BY THE WATER SUPERINTENDENT.
- THE CONTRACTOR SHALL VERIFY SIZE, TYPE HORIZONTAL AND VERTICAL LOCATION OF THE MAIN AT THE PROPOSED CONNECTION POINTS PRIOR TO CONSTRUCTION. CONFLICTS WITH OTHER UTILITIES TO BE AVOIDED. DISCREPANCIES OR CONFLICTS WITH EXISTING UTILITIES SHALL BE REPORTED TO THE WATER SUPERINTENDENT IMMEDIATELY.
- MINIMUM WATER MAIN DEPTH (TOP OF PIPE TO FINISH GRADE) SHALL BE 5'-0".
- ALL FILL BELOW WATER MAIN SHALL BE COMPACTED GRANULAR MATERIAL (MIN 95% MODIFIED PROCTOR TYP)
- ALL TRENCH BACKFILL SHALL BE MECHANICALLY COMPACTED TO PREVENT SETTLEMENT. TRENCH WITH 12" MIN. APPROVED GRAVEL IN PAVED AREAS AND ALONG SIDE OF EXISTING ROAD FOR SHOULDER BASE. REPLACE DAMAGED PAVEMENTS WITH LIKE KIND AND LIKE THICKNESS.
- WATER MAINS SHALL BE SDR-21 POLYETHYLENE GLYCOL (PE) OR P.E. 3408 DR-9 (H.P.S.) AWWA C906 BLUE/STPE.
- WATER MAINS ARE TO BE INSTALLED IN ACCORDANCE WITH AWWA STANDARDS: C600 FOR DUCTILE IRON, C900 FOR PVC.
- ALL DUCTILE IRON PIPE AND FITTINGS SHALL BE CEMENT LINED IN ACCORDANCE WITH AWWA STANDARD C602.
- ALL DUCTILE IRON PIPE SHALL BE POLYETHYLENE ENCASED IN ACCORDANCE WITH AWWA C105 UNLESS TEST RESULTS PROVIDED BY THE CONTRACTOR INDICATE THE ABSENCE OF SEVERELY AGGRESSIVE SOILS.
- ALL WATER PIPE AND APPURTENANCES SHALL BE EITHER NSF OR UL APPROVED FOR USE WITH POTABLE WATER AND SHALL BEAR THEIR RESPECTIVE SEAL.
- HYDRANTS SHALL BE LOCATED AT STREET INTERSECTIONS AND AT INTERMEDIATE POINTS AS INDICATED ON THE PLANS. CARE SHALL BE USED, WHEN LAYING MAINS, SO AS TO AVOID CREATING HIGH POINTS BETWEEN HYDRANTS.
- MINIMUM SEPARATIONS BETWEEN WATER MAINS AND SANITARY AND STORM SEWERS ARE REQUIRED PER NYS/DOH AND TEN STATE STANDARDS AT CROSSINGS, 18" MIN. WHERE PARALLEL, 10 FT. MIN. (MEASURED O.D. TO O.D.).
- THRUST BLOCKING SHALL BE CAST-IN-PLACE CONCRETE AND SHALL BE SIZED AS PER THRUST BLOCK SCHEDULE. MECHANICAL RESTRAINTS MUST BE APPROVED BY THE WATER SUPERINTENDENT.
- ALL NEW WATER MAINS ARE TO BE HYDROSTATICALLY TESTED IN ACCORDANCE WITH AWWA STANDARDS: C600-99/SEC. 4 FOR DUCTILE IRON AND MANUAL M23 FOR PVC. RESULTS TO BE SUBMITTED TO WATER SUPERINTENDENT. MODIFICATIONS TO EXISTING MAINS SHALL BE DISINFECTED BY SWAB METHOD AND VISUALLY TESTED FOR LEAKS UNDER NORMAL WORKING PRESSURE PRIOR TO BACKFILL.
- ALL WATER MAINS SHALL BE DISINFECTED AND BACTERIOLOGICALLY TESTED IN ACCORDANCE WITH AWWA STANDARD C651-99 (SEE DISINFECTION PROCEDURE THIS SHEET) RESULTS TO BE SUBMITTED TO THE WATER SUPERINTENDENT.
- CURB BOXES ARE TO BE INSTALLED SO THAT CAPS EXCEED ABOVE FINISHED GRADE 1" AND IDENTIFIED WITH 2x4 LUMBER MARKER IN GRASSY AREAS. IN PAVED AREAS, USE TWO PIECE CURB BOX GAP (PENTAGONAL PLUG) AND CAST IRON CURB BOX SLEEVE TO ALLOW ADJUSTMENT OF THE GROUND KEY LID (MUELLER H-10342 OR APPROVED EQUAL).
- IT WILL BE THE CONTRACTORS RESPONSIBILITY TO ADHERE STRICTLY TO ALL RELEVANT NYS OSHA LABOR SAFETY STANDARDS INCLUDING, BUT NOT LIMITED TO, THOSE RELATING TO CONSTRUCTION SAFETY AND TRENCH SHORING.
- ALL GENERAL AND SPECIFIC NOTES AND DETAILS ON OTHER PLAN SHEETS THAT ARE PART OF THESE PLANS SHALL APPLY.

WATER AND SEWER SEPARATION:

PARALLEL INSTALLATIONS: WATER MAINS SHALL LAID AT LEAST 10 FEET HORIZONTALLY FROM ANY EXISTING OR PROPOSED GRAVITY (OR FORCED) SANITARY OR STORM SEWER, MEASURED OUTSIDE TO OUTSIDE OF PIPE.

CROSSINGS: WATER MAINS CROSSING SEWERS SHALL BE INSTALLED TO PROVIDE A MINIMUM VERTICAL SEPARATIONS OF 18 INCHES, MEASURED OUTSIDE TO OUTSIDE OF PIPE, WITH A FULL 20 FOOT LENGTH OF WATER MAIN PIPE COVERED SUCH THAT THE JOINTS ARE EQUIDISTANT FROM THE POINT OF CROSSING.

WHERE MINIMUM SEPARATIONS CANNOT BE MET, WITH CASE-BY-CASE APPROVAL FROM NYS DOH:

- NEW SEWERS SHALL BE CONSTRUCTED OF MINIMUM 150 PSI PRESSURE-RATED AWWA WATER GRADE MATERIALS AND SHALL BE PRESSURE TESTED TO ENSURE WATER TIGHTNESS.
- INSTALLATIONS CLOSER THAN 10 FOOT SEPARATION ONLY IF WATER MAIN IS LAID IN A SEPARATE TRENCH OR ON AN UNDISTURBED EARTH SHELF LOCATED ON ONE SIDE OF THE SEWER AT SUCH AN ELEVATION THAT THE BOTTOM OF THE WATER MAIN IS AT LEAST 18 INCHES ABOVE THE TOP OF THE GRAVITY SEWER.
- WHERE PRESSURE AND GRAVITY SEWERS PRE-EXIST, THE WATER MAIN SHALL BE INSTALLED WITHIN A PROTECTIVE CASING PIPE, CONSTRUCTED OF A MINIMUM 150 PSI PRESSURE-RATED AWWA WATER GRADE MATERIALS AND EXTEND 10 FT. MIN. ON BOTH SIDES OF THE SEWER BEING CROSSED OR, WHERE PARALLEL, TO A POINT WHERE THE LINES ARE SEPARATED BY 10 FEET.
- WHERE A WATER MAIN AND/OR WATER WELLS PRE-EXIST AND A FORCE MAIN IS BEING CONSTRUCTED: THE FORCE MAIN SHALL BE INSTALLED WITHIN A PROTECTIVE CASING PIPE, CONSTRUCTED OF A MINIMUM 150 PSI PRESSURE-RATED AWWA WATER GRADE MATERIALS, AND EXTEND 10 FT. MIN. ON BOTH SIDES OF THE WATER MAIN BEING CROSSED, WHERE PARALLEL, TO A POINT WHERE THE LINES ARE SEPARATED BY 10 FEET, OR TO A POINT WHERE THE ENDS OF THE CASING PIPE ARE 150 FEET MIN. FROM ANY WATER LEVEL.

THRUST BLOCK NOTES:

- VALUES FOR TEE APPLY TO TEES, END PLUGS, CAPS, AND TAPPING SLEEVES.
- REQUIRED BEARING AREAS ARE DUE TO THRUSTS CAUSED BY 150 PSI WORKING PRESSURE PLUS 50% (75 PSI) SURGE ALLOWANCE RESULTING IN 225 PSI TOTAL INTERNAL PRESSURE.
- REQUIRED BEARING AREAS ARE BASED ON ALLOWABLE SOIL BEARING CAPACITY OF 3000 POUNDS PER SQ. FT. IF OTHER SOIL CONDITIONS ENCOUNTERED, BEARING AREAS MAY BE MODIFIED BY THE WATER SUPERINTENDENT.
- IN MUCK, PEAT OR RECENTLY PLACED FILL ALL THRUSTS SHALL BE RESISTED BY PILES OR THE ROADS TO SOLID FOUNDATIONS, OR BY REMOVAL OF SUCH UNSTABLE MATERIAL AND REPLACEMENT WITH BALAST OF SUFFICIENT STABILITY TO RESIST THE THRUSTS. ALL AS REQUIRED BY THE WATER SUPERINTENDENT.
- ALL THRUST BLOCKS SHALL BE CAST-IN-PLACE.
- ALL DUCTILE IRON WATER MAIN SHALL BE ENCASED IN POLYETHYLENE, IF TESTING WARRANTS.

REQUIRED AREAS (SQ. FT.) FOR THRUST BLOCKS

PIPE SIZE (INCHES)	TEE	90° BEND	45° BEND	22-1/2° BEND	11-1/4° BEND
4	2.0	2.8	1.5	0.8	0.4
6	4.2	5.9	3.2	1.6	0.8
8	7.2	10.1	5.5	2.8	1.4
10	10.9	15.4	8.3	4.2	2.1
12	15.4	21.8	11.8	6.0	3.0
14	20.6	29.1	15.8	8.0	4.0
16	26.8	37.9	20.5	10.4	5.2
18	33.6	47.5	25.7	13.1	6.6
20	41.2	58.2	31.5	16.1	8.1
24	58.8	83.1	45.0	22.9	11.5
30	90.5	128.0	69.2	35.3	17.7
36	129.6	183.3	99.1	50.5	25.4

THRUST REACTIONS - R(LB) PER 100 PSI INTERNAL PRESSURE

PIPE SIZE (INCHES)	TEE	90° BEND	45° BEND	22-1/2° BEND	11-1/4° BEND
4	1,810	2,559	1,385	706	355
6	3,739	5,288	2,862	1,459	733
8	6,433	9,097	4,923	2,510	1,261
10	9,677	13,685	7,406	3,776	1,897
12	13,585	19,353	10,474	5,340	2,683
14	18,385	26,001	14,072	7,174	3,604
16	23,779	33,628	18,199	9,278	4,661
18	29,865	42,235	22,858	11,653	5,855
20	36,644	51,822	28,046	14,298	7,183
24	52,279	73,934	40,013	20,398	10,249
30	80,425	113,738	61,554	31,380	15,766
36	115,209	162,931	88,177	44,952	22,585


THRUST BLOCK DIMENSIONS ON VERTICAL TRENCH WALL ORIGINAL GROUND (FEET)

PIPE SIZE (INCHES)	TEE	90° BEND	45° BEND	BEND	11-1/4° BEND
4	1.0x2.0	1.0x2.8	0.75x2.0	0.8x1.0	0.4x1.0
6	1.5x2.8	1.5x4.0	1.0x3.2	1.0x1.6	0.6x1.0
8	2.0x3.6	2.0x5.1	1.4x3.9	1.4x2.0	1.0x1.4
10	2.5x4.4	2.5x6.2	1.7x4.9	1.7x2.4	1.25x1.7
12	3.0x5.2	3.0x7.1	2.0x5.8	2.0x3.0	1.5x2.0
14	3.5x6.9	3.5x8.3	2.5x6.3	2.5x3.2	1.75x2.3
16	4.0x6.7	4.0x9.5	2.7x7.6	2.7x3.8	2.0x2.6
18	4.5x7.5	4.5x10.6	3.0x8.6	3.0x4.4	2.2x3.0
20	5.0x8.25	5.0x11.7	3.4x9.3	3.4x4.75	2.5x3.25
24	6.0x9.8	6.0x13.9	4.0x11.28	4.0x5.75	2.8x4.1
30	7.5x12.1	7.5x17.1	5.0x13.8	5.0x7.1	3.0x5.9
36	9.0x14.4	9.0x20.4	6.0x16.5	6.0x8.4	3.3x7.7

SOIL BEARING STRENGTH (LB/FT²)

SOIL	SOIL BEARING STRENGTH (LB/FT ²)
MUCK	0
SOFT CLAY	1,000
SILT	1,500
SANDY SILT	3,000
SAND	4,000
SANDY CLAY	6,000
HARD CLAY	9,000

15 OF 19

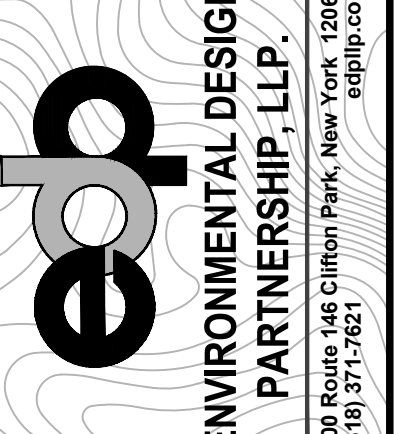


ENVIRONMENTAL DESIGN PARTNERSHIP, LLP
900 Route 446 Clinton Park, New York, 10865
(516) 251-1212

WOODS HOLLOW CAMPGROUND
WOODS HOLLOW MINING COMPANY
WOODS HOLLOW ROAD
TOWN OF MAYFIELD
FULTON COUNTY, NEW YORK


DATE	BY	REVISION
12/21/22	LM	ISSUED PER MUNICIPAL COMMENTS
12/21/22	LM	SUBMITAL TO A&A
9/16/22	LM	SUBMITAL TO A&A AND DOH

FINAL
P2022-008


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NOT FOR CONSTRUCTION
SHEET TITLE: WATER DETAILS
SHEET: 15 OF 19

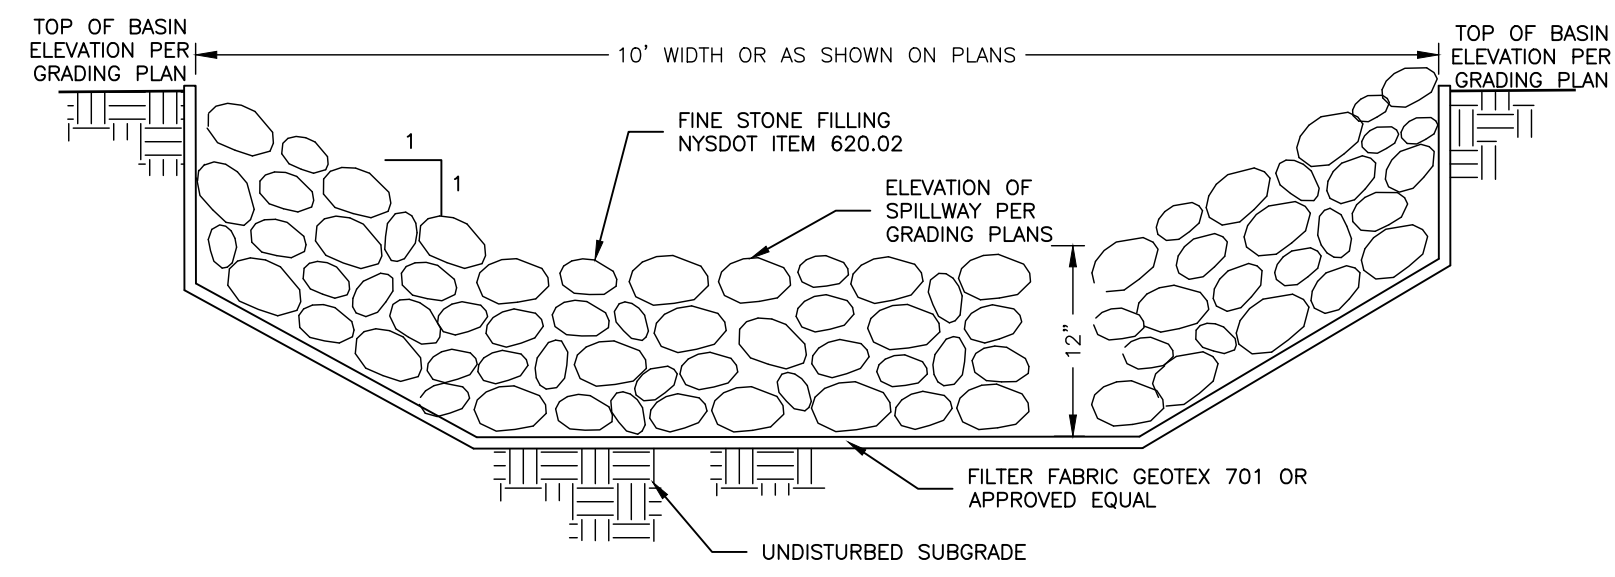


1 OVERFLOW SPILLWAY
16 NOT TO SCALE

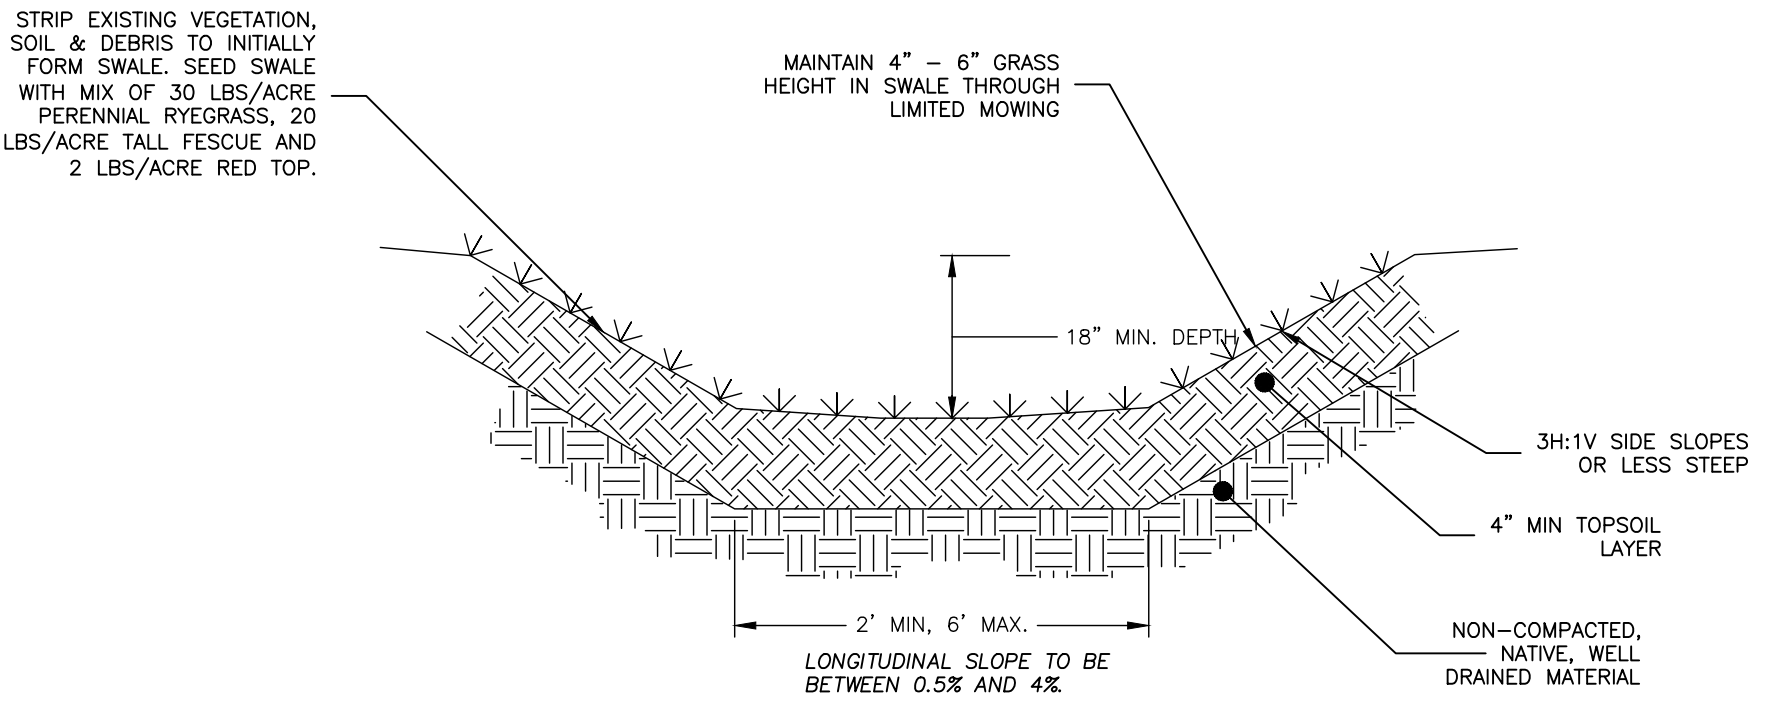


4 VEGETATED SWALE
16 NOT TO SCALE

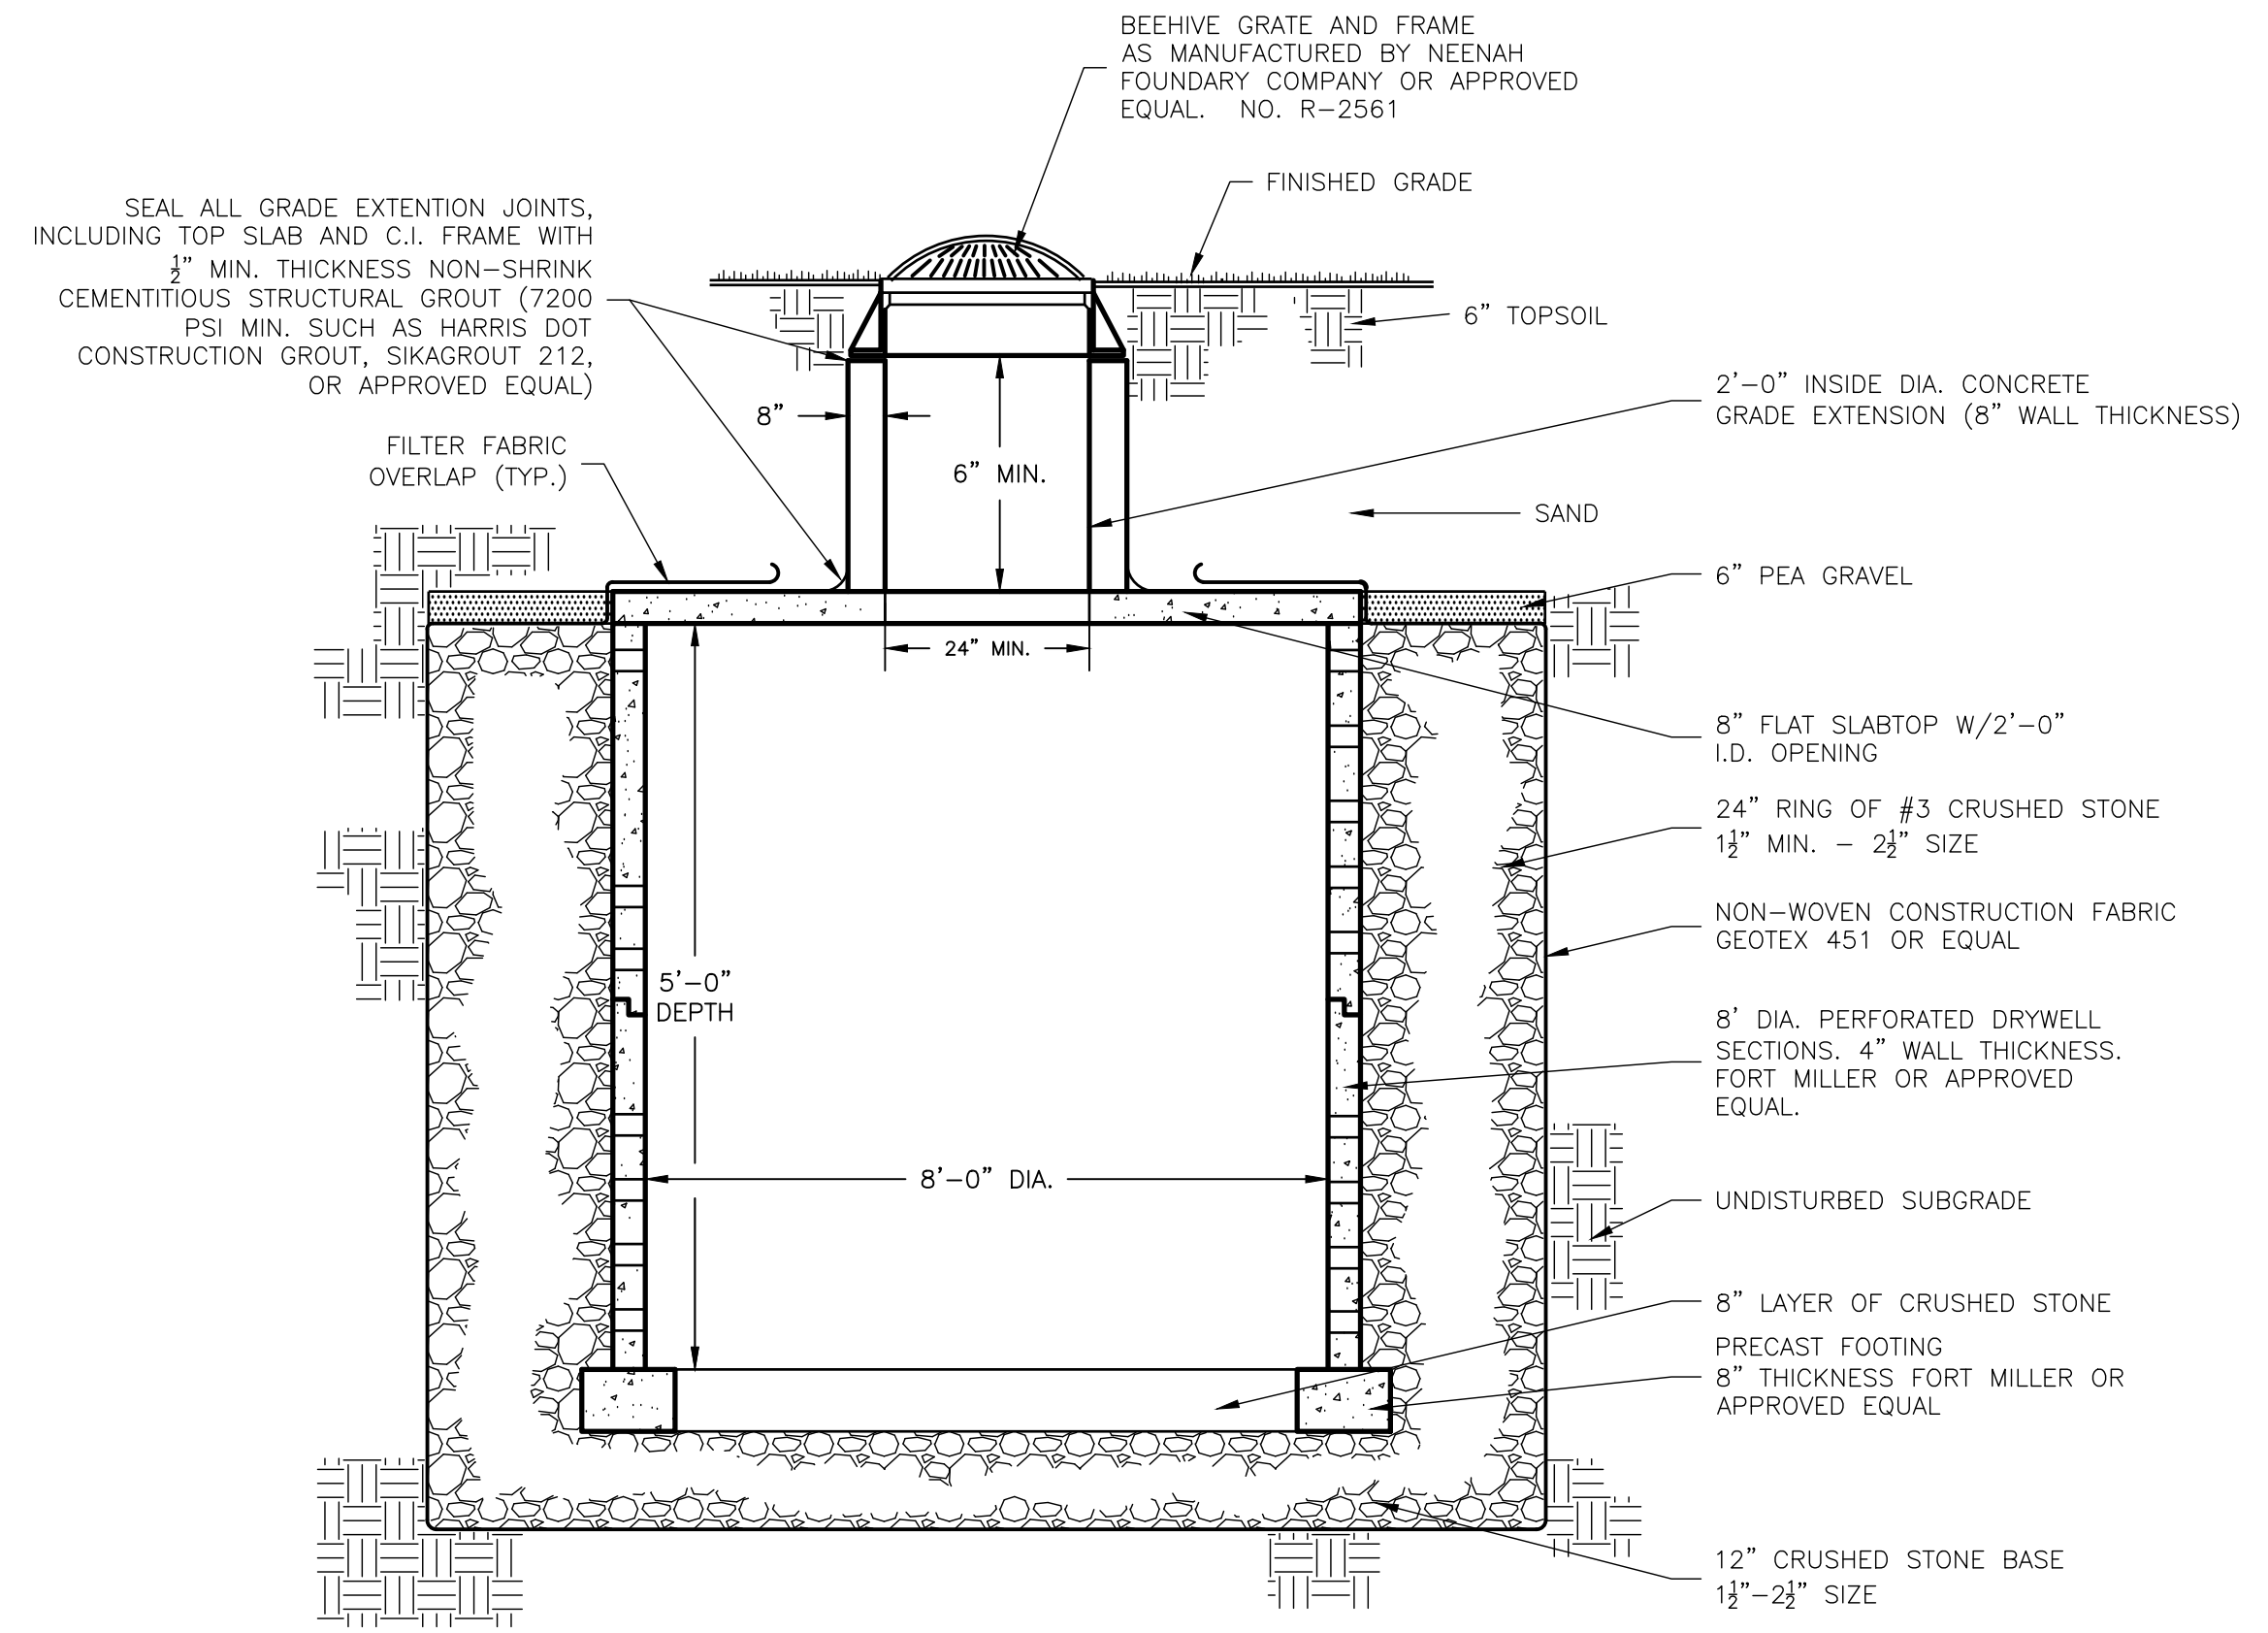


6 PRECAST CONCRETE DRYWELL
16 NOT TO SCALE

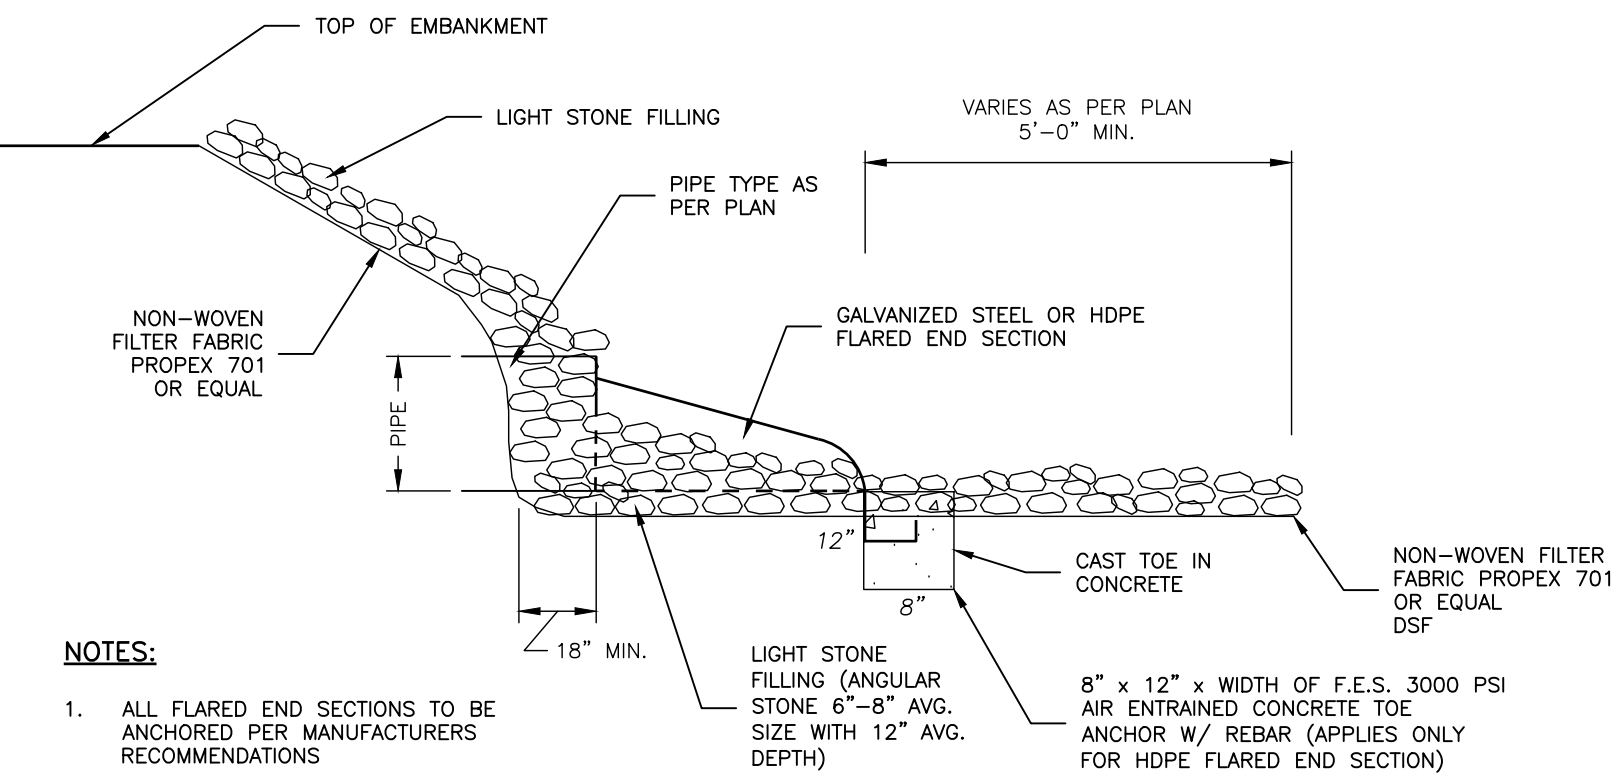

2 FLARED END SECTION
16 NOT TO SCALE

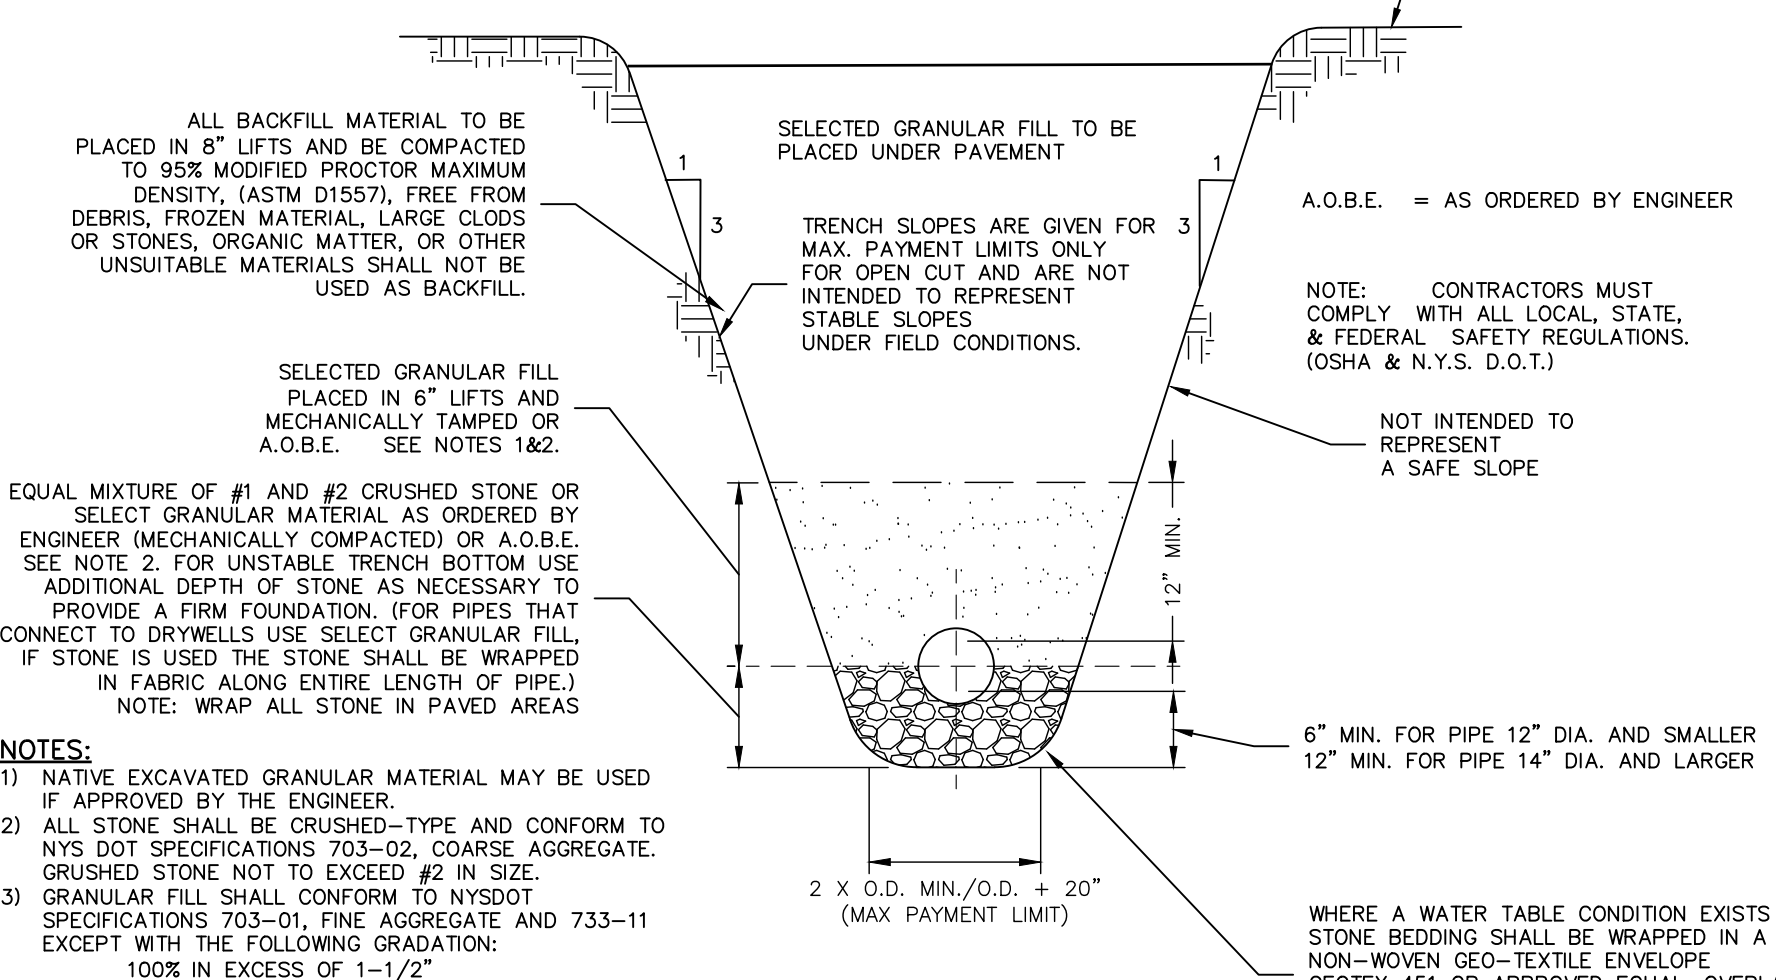

5 STORM TRENCH (TYP.)
16 NOT TO SCALE

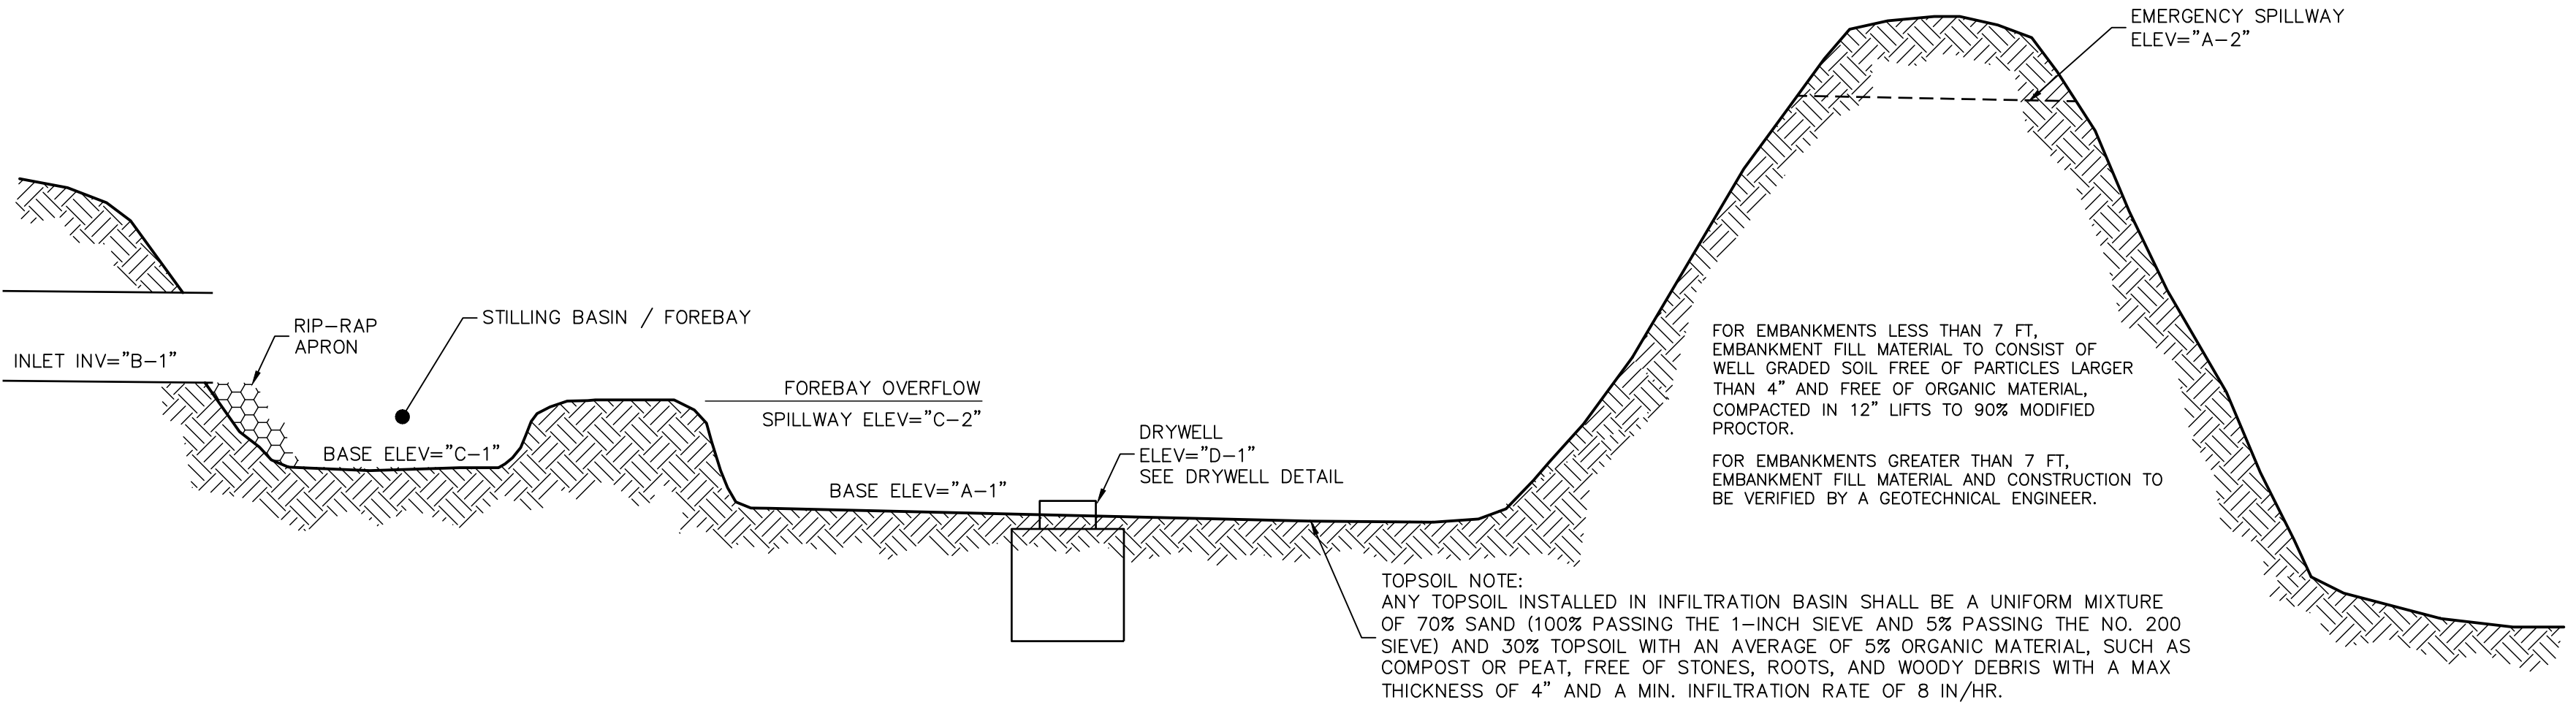

3 INFILTRATION BASIN AND OUTLET DETAIL
16 NOT TO SCALE

Adrianstad
Park Agency
FINAL
P2022-0008

DRAWN BY:	STA:
CHECKED BY:	DATE:
FOR PROJECT NUMBER:	148201
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REVISION:	DATE:
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SUBMITTAL TO APA:	7/21/22 T.M.
SUBMITTAL TO APA AND DDH:	8/18/22 T.M.

SCALE:
AS NOTED
NOT FOR CONSTRUCTION
SHEET TITLE:
STORMWATER DETAILS
SHEET:

DRAWN BY:	STA	
CHECKED BY:	DATE	
REVISED FOR MANHOLE COMMENTS	7/20/22 TAM	
SUBMITTED TO AEA AND DOH	7/21/22 TAM	
REVISION	DATE	BY
1	7/20/22	TAM
2	7/21/22	TAM
3	8/16/22	TAM

NEW YORK STATE
Adirondack Park Agency
FINAL
 P2022-0008

DESIGN FLOW NOTES:
 ALL FLOW RATES HAVE BEEN CALCULATED BASED ON "TYPICAL PER UNITY HYDRAULIC LOADING RATES" FROM THE 2014 "NEW YORK STATE DESIGN STANDARDS FOR INTERMEDIATE SIZED WASTEWATER TREATMENT SYSTEMS"

ABSORPTION FIELD DESIGN CALCULATIONS (BATHHOUSES)






SEPTIC I.D.	DESIGN FLOW		UNIT FLOW RATE (GPD/SITE)	GROSS DESIGN FLOW	% REDUCTION FOR WATER SAVING FIXTURES	DESIGN FLOW	APPLICATION RATE	ELEN GSF EFFECTIVE TRENCH WIDTH	REQUIRED TRENCH LENGTH	PROPOSED TRENCHES	PROPOSED TOTAL TRENCH LENGTH
	SEWERED	UNSEWERED									
18	0	0	10	150		120			17	2 @ 21' EACH	42
28	23	0	10	990		792			74	3 @ 41' EACH	123
38	46	0	10	1140		912			142	3 @ 49' EACH	147
48	33	5	15	570	20	456	1.20	6 SF/LF	73	2 @ 45' EACH	90
58	69	0	15	345		276			38	2 @ 33' EACH	66
68	19	20	15	1195		956			133	3 @ 45' EACH	135
78	25	4	15	845		676			94	3 @ 41' EACH	123


GENERAL SANITARY NOTES:

- MAINTAIN 100' MINIMUM SEPARATION BETWEEN SEPTIC SYSTEM AND ANY WELL (200' TO PUBLIC WATER SUPPLY WELL). CONTRACTOR SHALL VERIFY THE LOCATION OF ALL EXISTING/PROPOSED WELLS PRIOR TO CONSTRUCTION.
- MINIMUM SEPARATION BETWEEN SEPTIC TANK AND BUILDINGS SHALL BE 10 FEET.
- MINIMUM SEPARATION BETWEEN EDGE OF TRENCHES AND BUILDINGS SHALL BE 20 FEET.
- MINIMUM SEPARATION BETWEEN PROPERTY LINE AND EDGE OF TRENCHES SHALL BE 10 FEET.
- MINIMUM SEPARATION BETWEEN WELL AND SEPTIC TANK TO BE 50 FEET.
- ALL CONSTRUCTION TO BE IN COMPLIANCE WITH THE NEW YORK STATE SANITARY CODE.
- REQUIRED INSPECTIONS (TO BE PERFORMED BY PROFESSIONAL ENGINEER):
 A) PRIOR TO PLACEMENT OF SEPTIC TANK OR COMMENCEMENT OF THE TILE FIELD CONSTRUCTION.
 B) DURING THE INSTALLATION OF ANY REQUIRED FILL MATERIAL.
 C) PRIOR TO BACKFILLING TRENCHES.
 D) FINAL INSPECTION UPON COMPLETION OF THE SYSTEM.
- CRUSHED STONE SHALL BE CLEAN, DURABLE AND NO SMALLER THAN OR LARGER THAN 1-1/2" DIAMETER.
- WHEN THE TRENCHES HAVE BEEN EXCAVATED, THE SIDES AND BOTTOM SHALL BE RAKED TO SCARIFY ANY SMOORED SOIL SURFACES.
- CONSTRUCTION EQUIPMENT NOT NEEDED TO CONSTRUCT THE SYSTEM SHOULD BE KEPT OFF THE AREA TO BE UTILIZED FOR THE ABSORPTION TRENCH SYSTEM TO PREVENT UNDESIRABLE COMPACTION OF THE SOILS.
- EACH DISTRIBUTION LINE SHALL CONNECT INDIVIDUALLY TO THE DISTRIBUTION BOX AND EXIT AT THE SAME SLOPE FOR THE FIRST 5 FEET TO 10 FEET FROM THE BOX (1/8" PER FOOT).
- THE DISTRIBUTION BOX SHALL BE SET LEVEL AND ARRANGED SO THAT EFFLUENT IS EVENLY DISTRIBUTED TO EACH DISTRIBUTION LINE. ADEQUATE PROVISIONS SHALL BE TAKEN TO ASSURE STABILITY AND PROVIDE ACCESS FOR INSPECTION OF THE DISTRIBUTION BOX.
- THE PIPES CONNECTING THE DISTRIBUTION BOX TO THE DISTRIBUTION LINES SHALL BE TIGHT-JOINT CONSTRUCTION Laid ON UNDISTURBED EARTH OR PROPERLY BEDDED THROUGHOUT ITS LENGTH.
- IF THE SYSTEM DESIGN DOES NOT INCLUDE PROVISIONS FOR GARBAGE GRINDERS, IN THE EVENT THAT GARBAGE GRINDERS ARE TO BE INSTALLED, THE CONTRACTOR SHALL NOTIFY ENGINEER PRIOR TO SEPTIC INSTALLATION FOR NECESSARY MODIFICATIONS.
- FOOTING DRAINS, SUMP PUMPS OR WATER SOFTENER DISCHARGES SHALL NOT BE CONNECTED INTO THE SEPTIC SYSTEM.
- CONTRACTOR TO COMPLY WITH ALL O.S.H.A. AND OTHER STATE AND LOCAL SAFETY REQUIREMENTS DURING CONSTRUCTION.
- AS PER NEW YORK STATE INDUSTRIAL CODE 53; CALL 1-800-962-7962 TO LOCATE BURIED CABLES, OR OTHER UNDERGROUND UTILITIES, NO LESS THAN TWO, OR MORE THAN TEN WORKING DAYS, PRIOR TO DIGGING, DRILLING, EXCAVATING, DRIVING POSTS, ETC.


ABSORPTION FIELD DESIGN CALCULATIONS (SEWERED RV SITES)

SEPTIC I.D.	DESIGN FLOW		UNIT FLOW RATE (GPD/SITE)	GROSS DESIGN FLOW	% REDUCTION FOR WATER SAVING FIXTURES	DESIGN FLOW	APPLICATION RATE	ELEN GSF EFFECTIVE TRENCH WIDTH	REQUIRED TRENCH LENGTH	PROPOSED TRENCHES	PROPOSED TOTAL TRENCH LENGTH
	SEWERED	UNSEWERED									
1A	8	0	10	800		640			111	3 @ 41' EACH	123
2A	11	0	10	1100		880			153	3 @ 53' EACH	159
3A	8	0	10	800		640			111	3 @ 41' EACH	123
4A	12	0	10	1200		960			167	4 @ 45' EACH	180
5A	11	0	10	1100		880			153	4 @ 49' EACH	196
6A	12	0	10	1200		960			167	4 @ 45' EACH	180
7A	9	0	10	900		720			125	3 @ 45' EACH	135
8A	12	0	10	1200		960			167	4 @ 45' EACH	180
9A	12	0	10	1200		960			167	4 @ 45' EACH	180
10A	12	0	10	1200		960			167	4 @ 45' EACH	180
11A	12	0	10	1200		960			167	4 @ 45' EACH	180
12A	11	0	10	1100		880			153	3 @ 53' EACH	159
13A	11	0	10	1100		880			153	3 @ 53' EACH	159
14A	12	0	10	1200		960			167	4 @ 45' EACH	180
15A	12	0	10	1200		960			167	4 @ 45' EACH	180
16A	11	0	10	1100		880			153	4 @ 41' EACH	164
17A	10	0	10	1000		800			139	3 @ 49' EACH	147
18A	12	0	10	1200		960			167	3 @ 57' EACH	171
19A	12	0	10	1200		960			167	3 @ 57' EACH	171
20A	3	0	10	300		240			42	2 @ 37' EACH	74

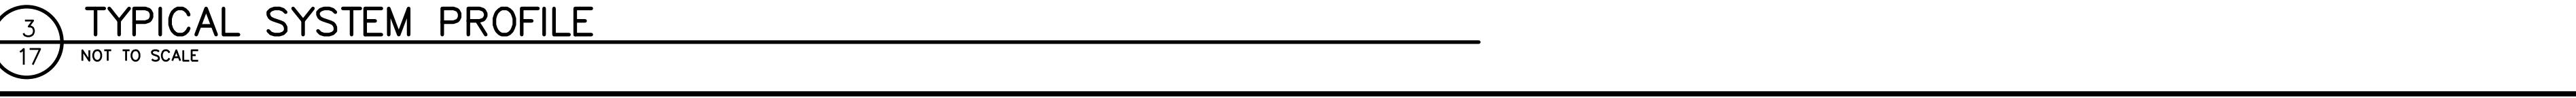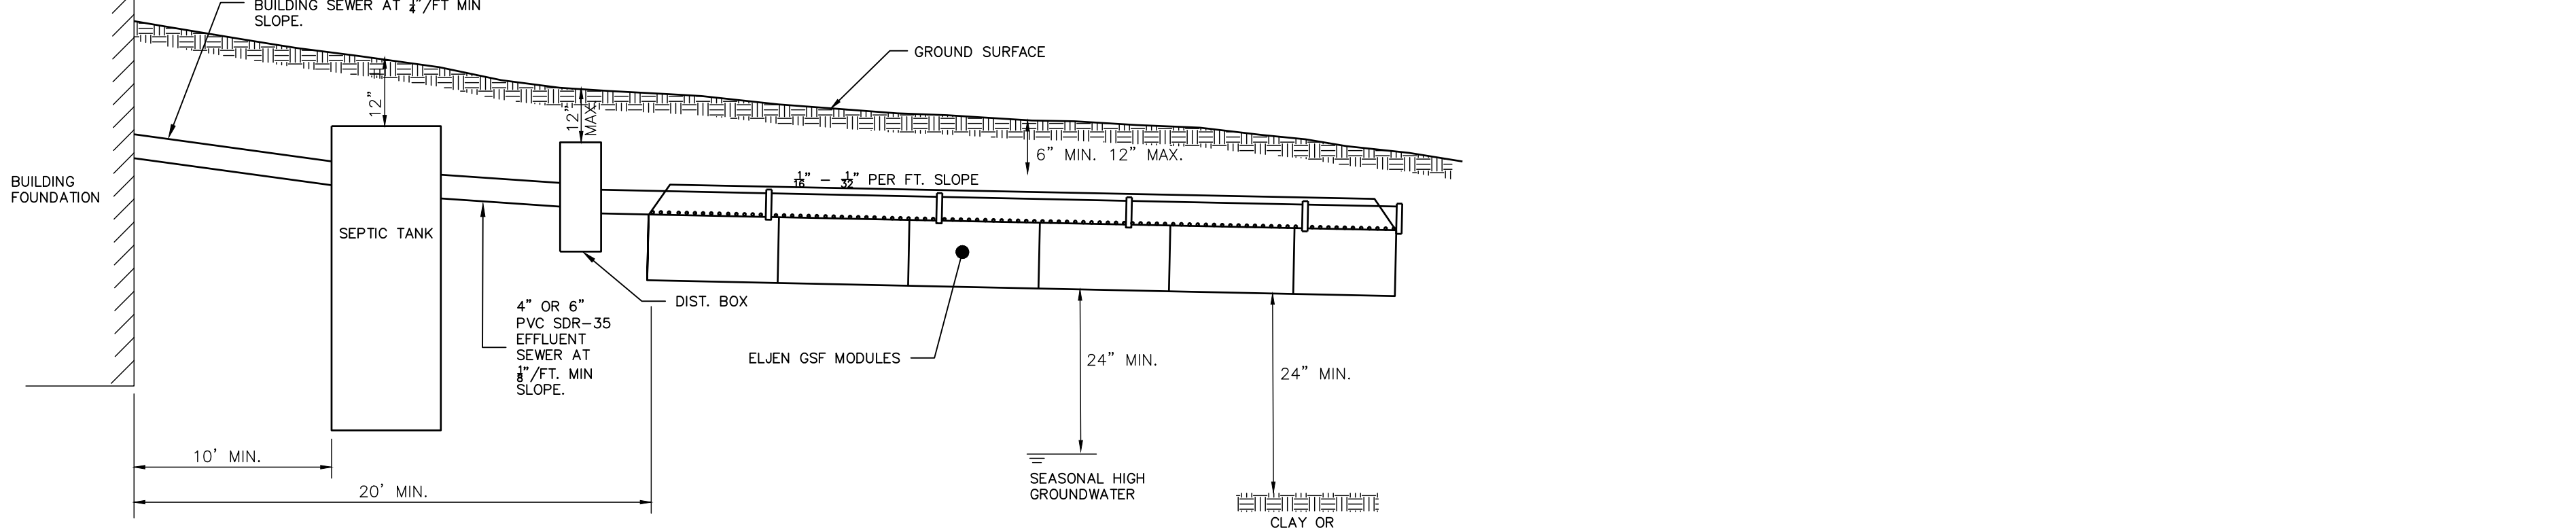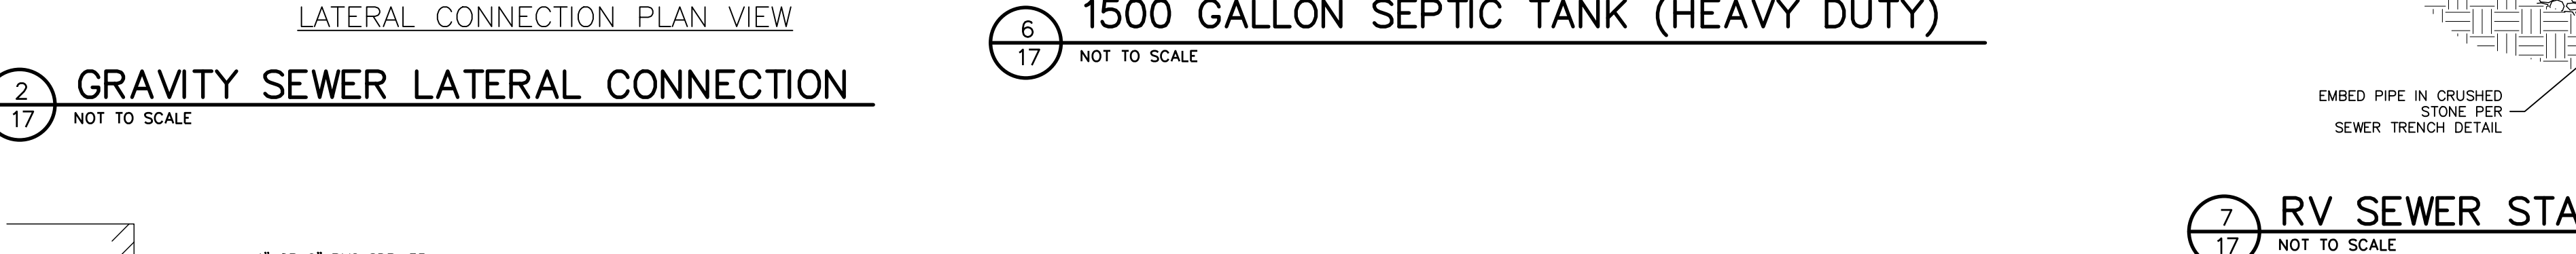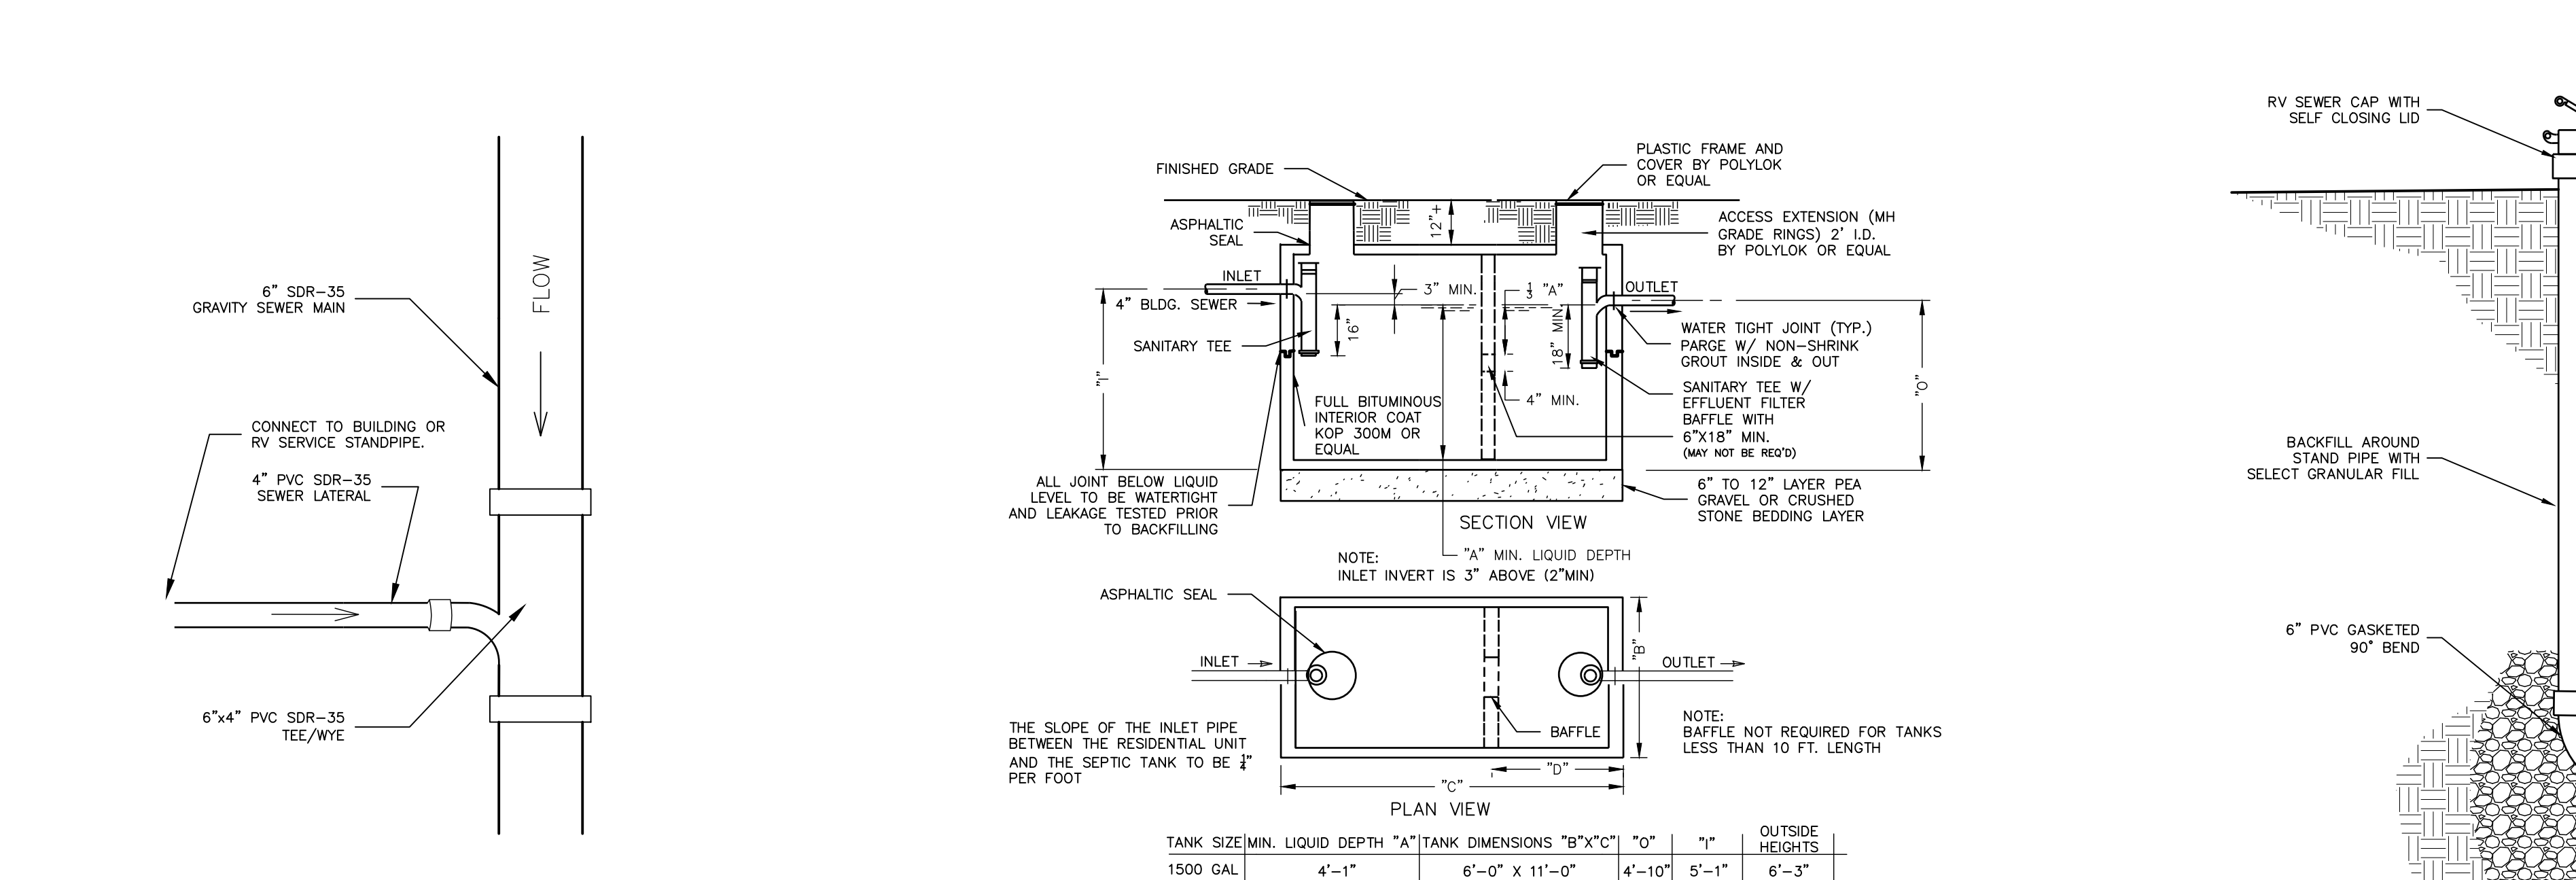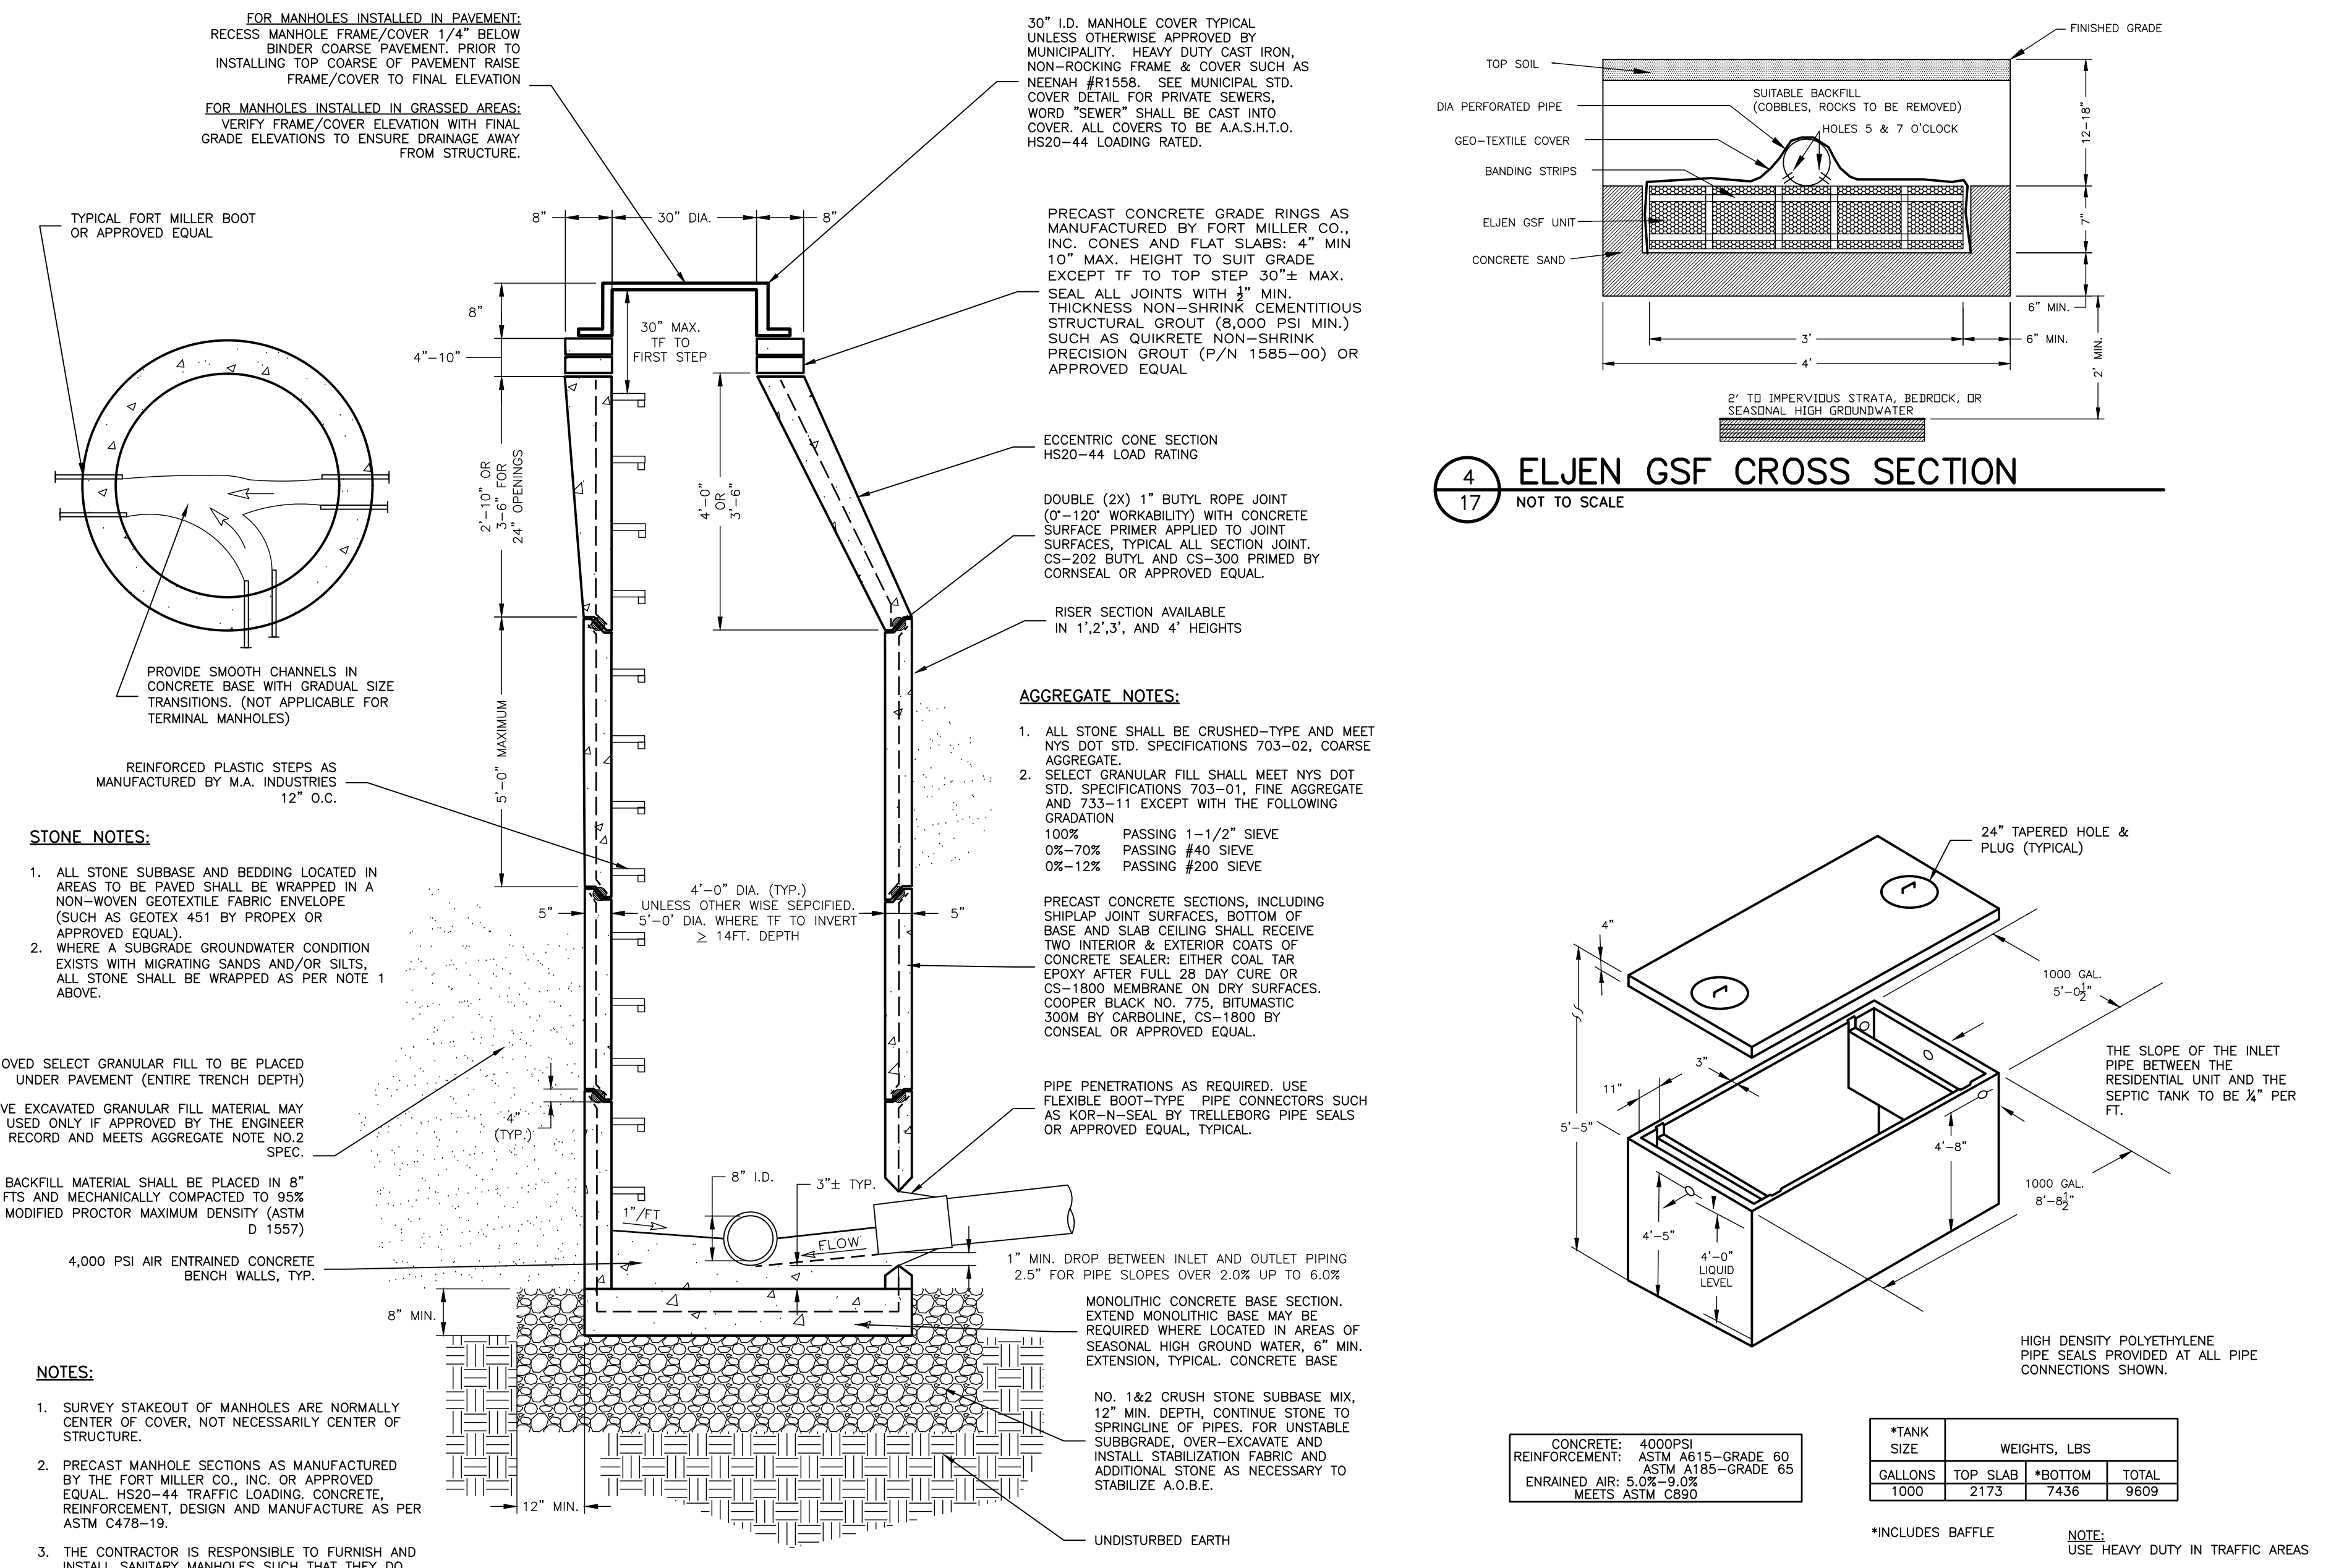

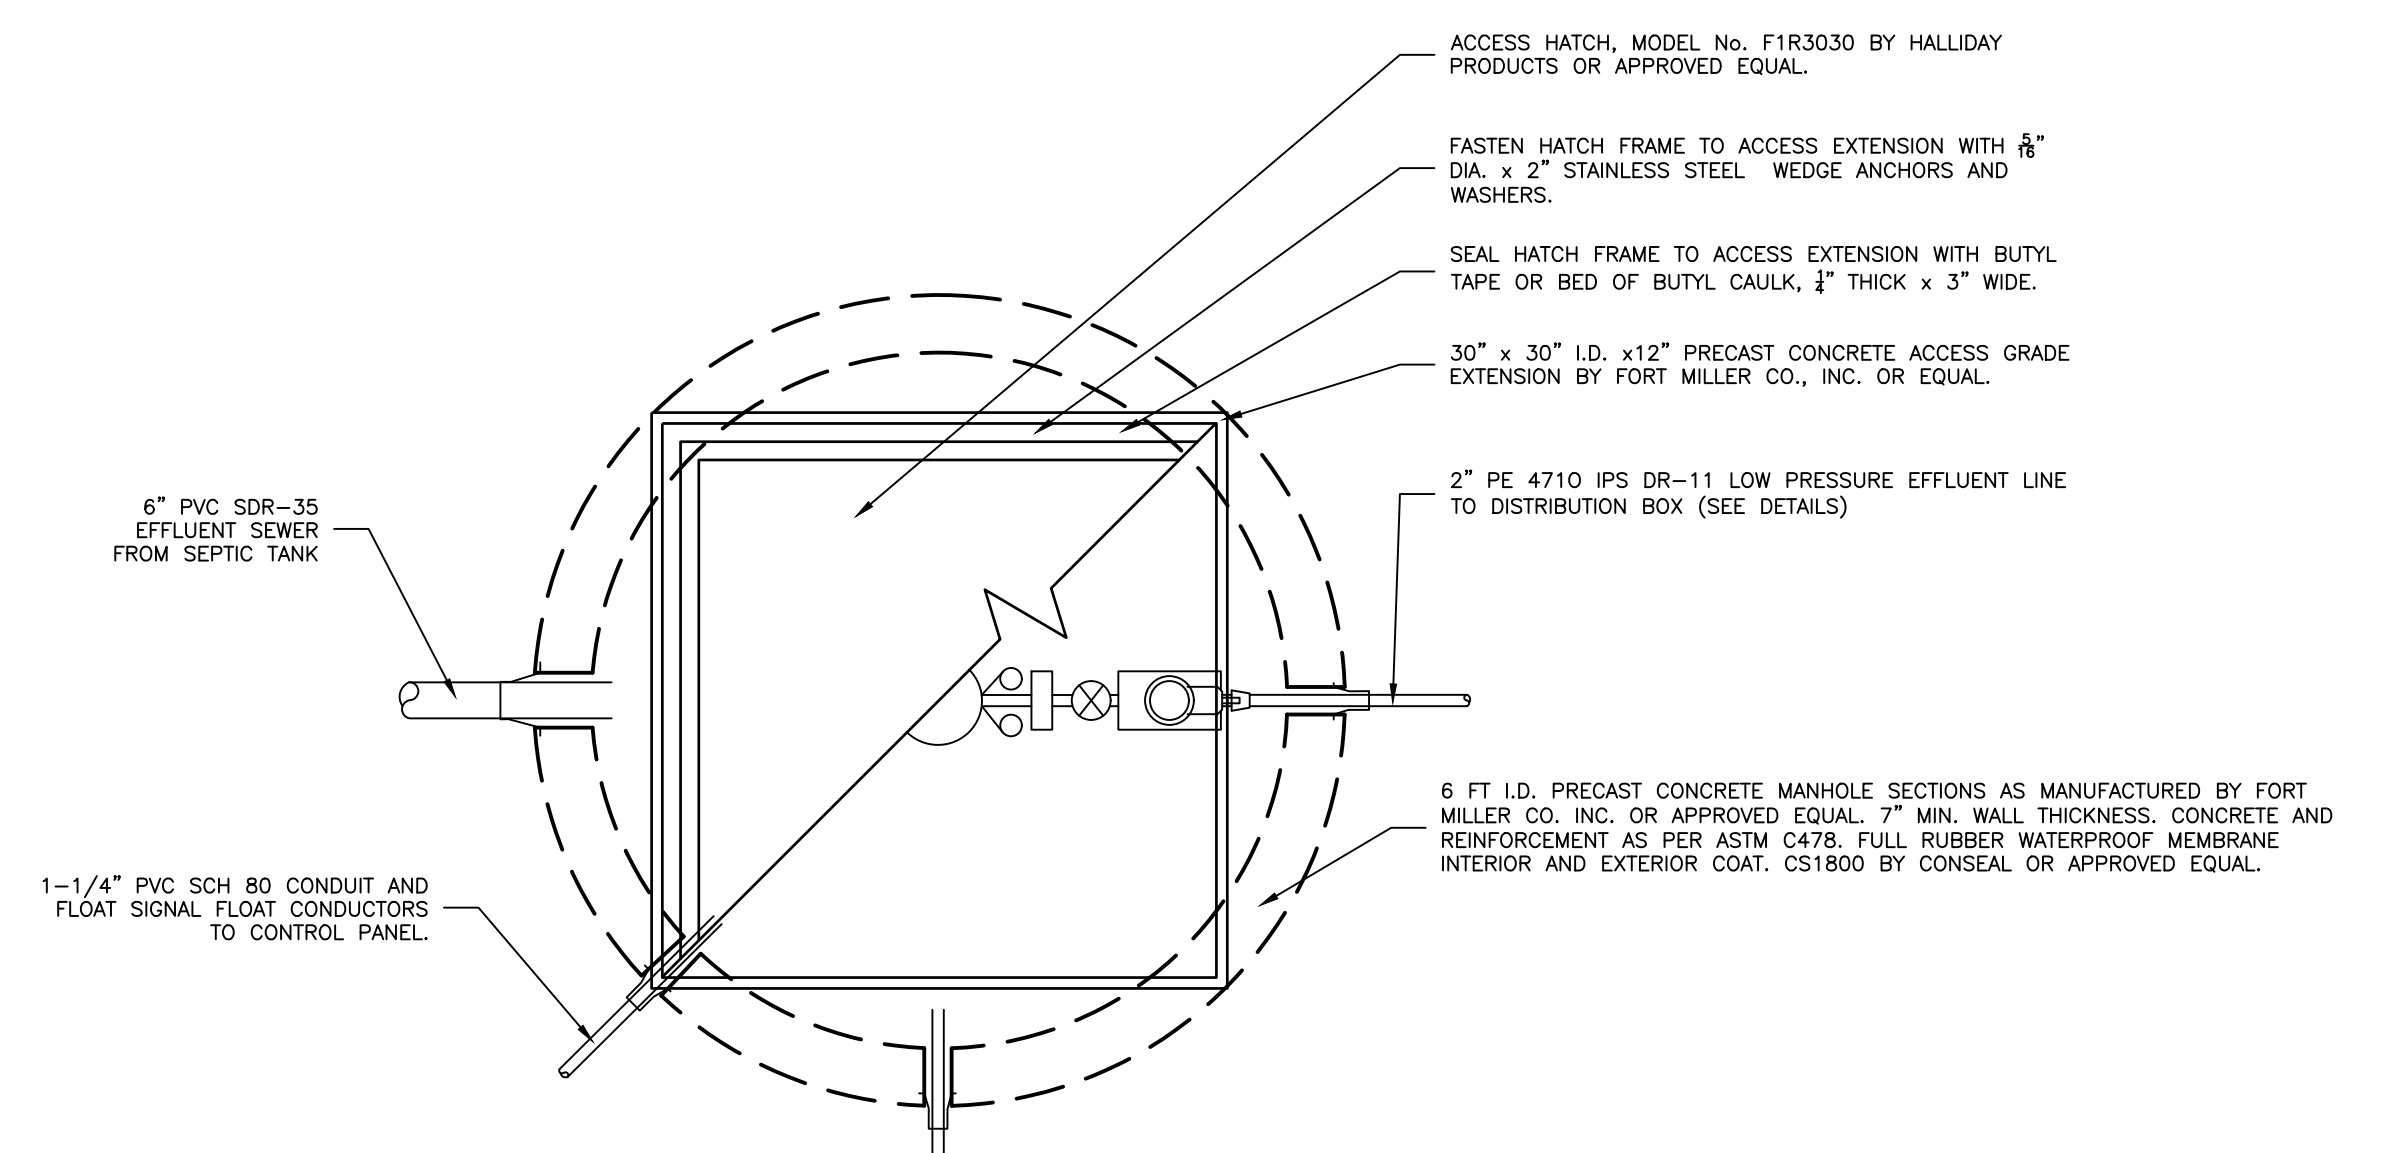


- NOTES:**
- CONTRACTOR TO CONFIRM ADEQUATE SPACE WITHIN MANHOLE STRUCTURE TO COMPLETE ALL FITTINGS AND APPURTENANCES AS SHOWN PRIOR TO ORDERING STRUCTURE.
 - FORCE MAIN TO BE INSTALLED AT CONSTANT UPWARD SLOPE TO DISTRIBUTION BOX (1% MIN SLOPE AND NO LOW SPOTS) IN ORDER TO ALLOW DRAIN BACK TO PUMP STATION BETWEEN PUMP CYCLES.
 - COAT INSIDE AND OUTSIDE OF TANK WITH RUBBER WATERPROOFING MEMBRANE, CS-1800, BY CONSEL OR APPROVED EQUAL.

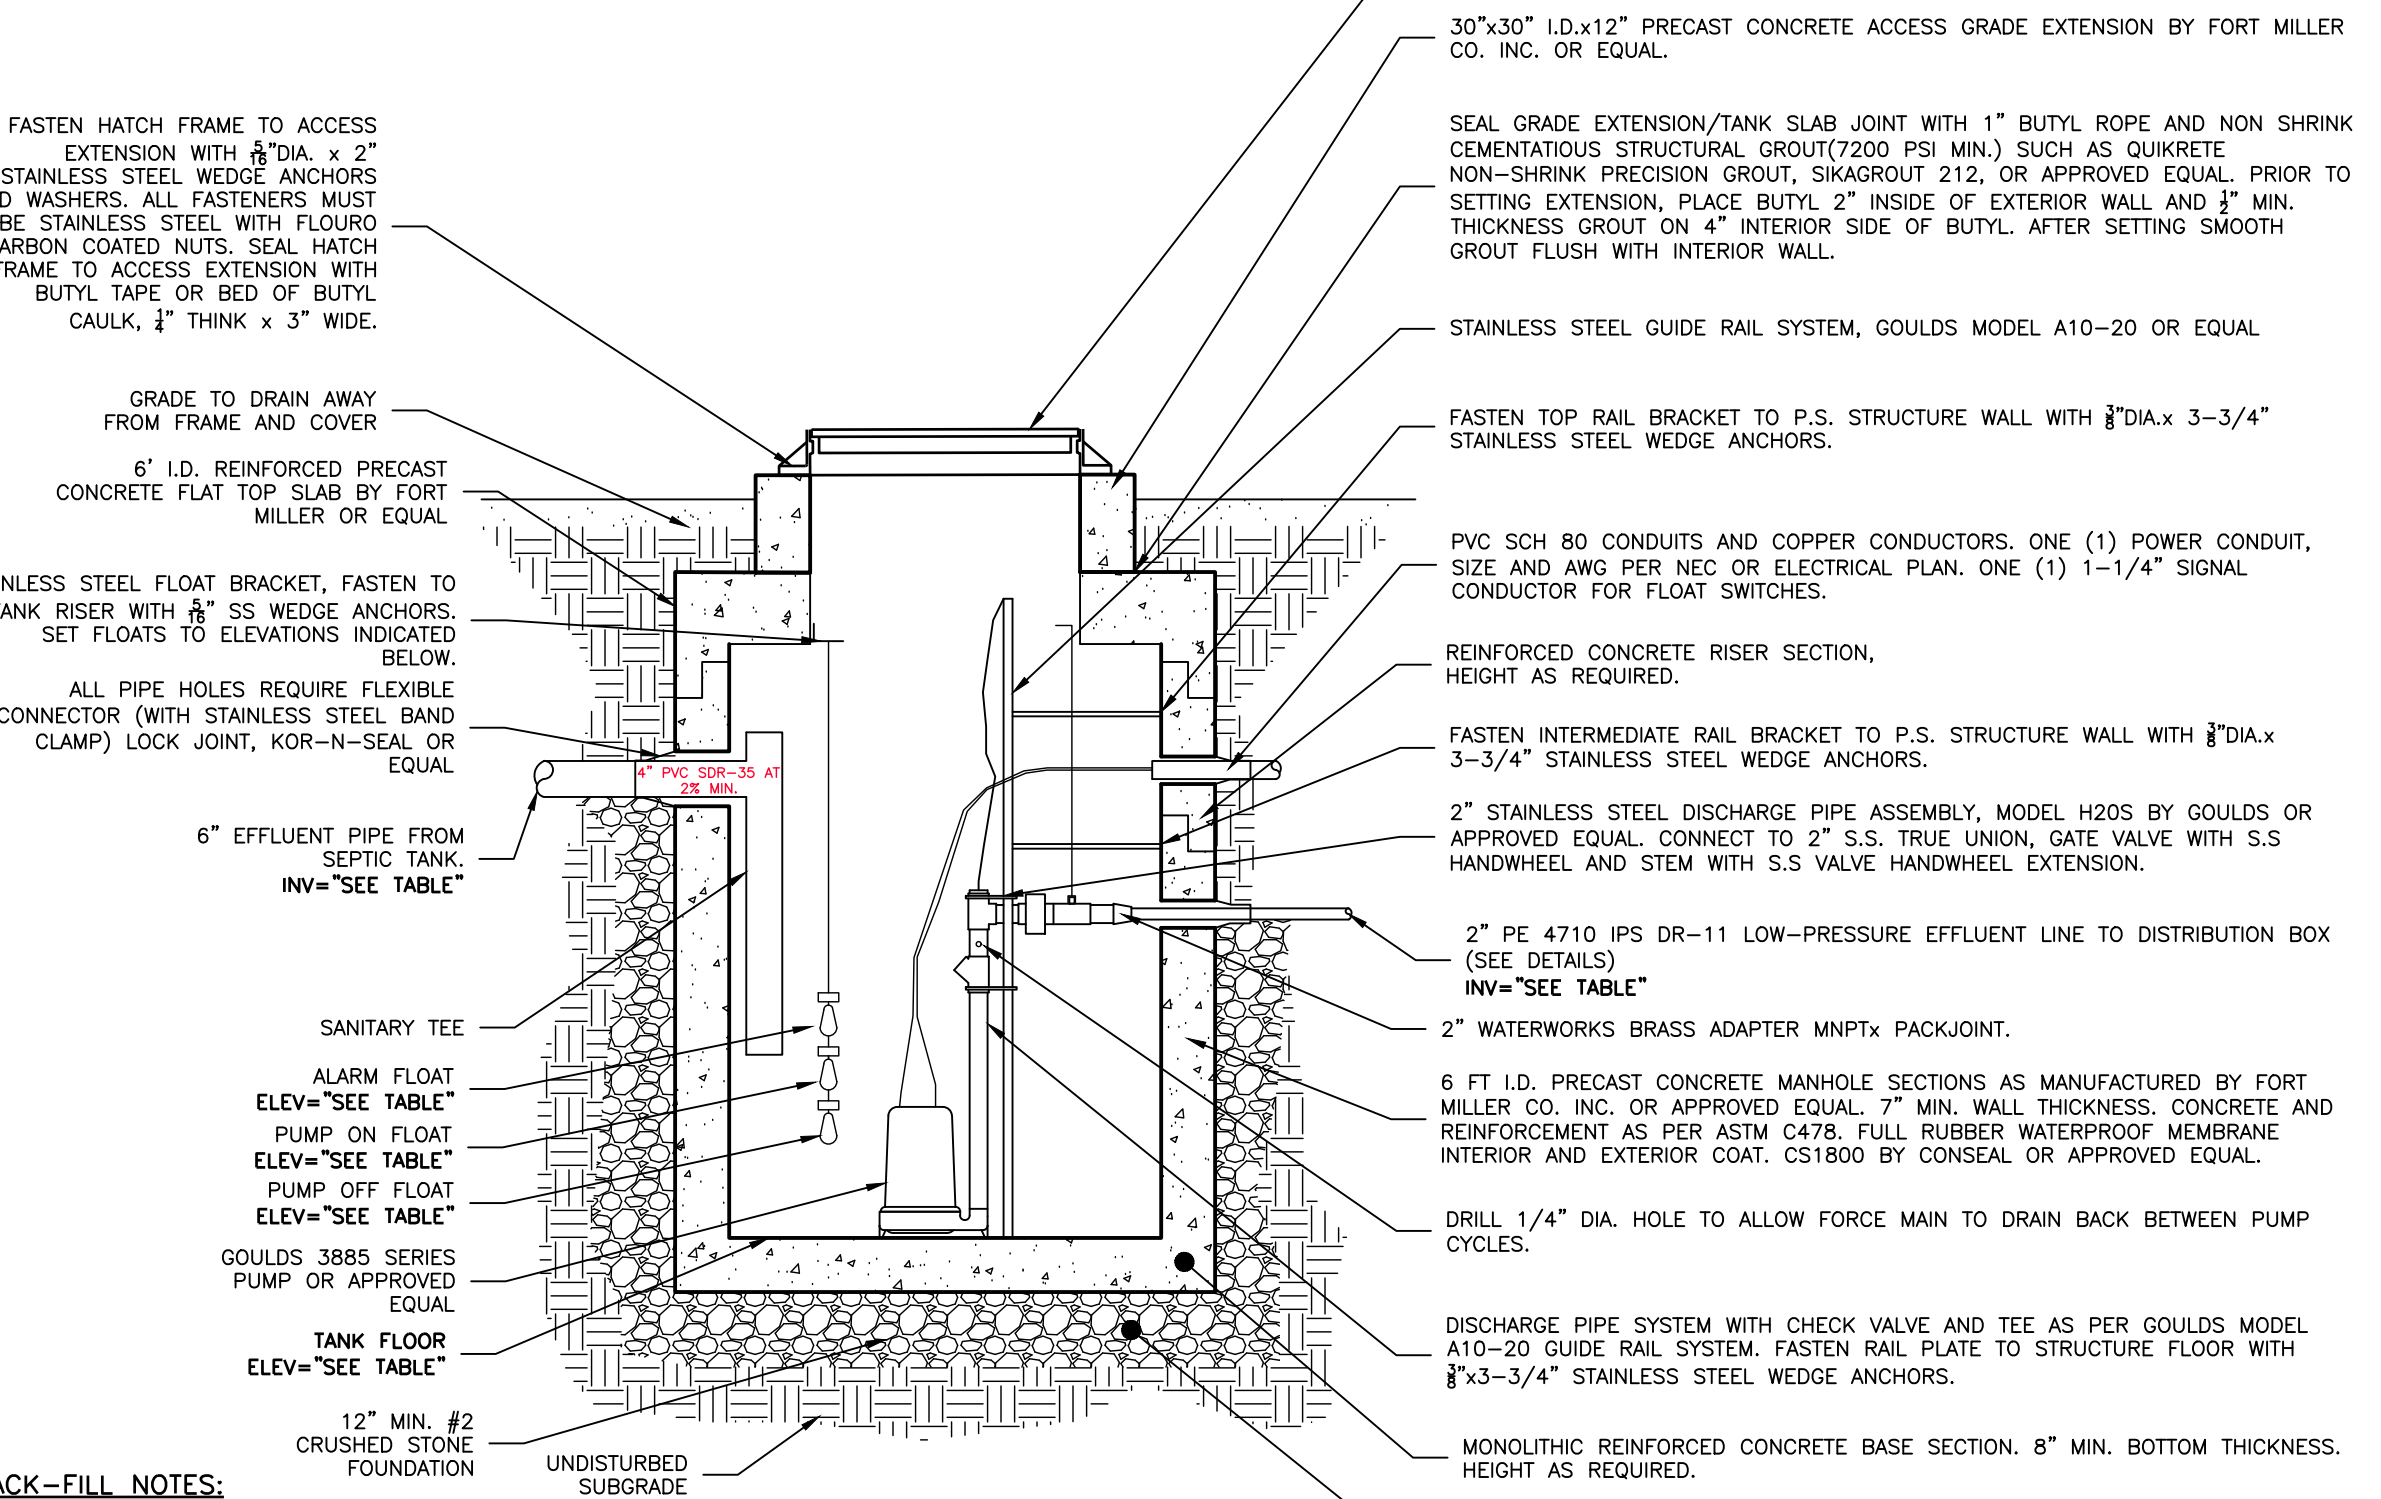

- BACK-FILL NOTES:**
- ALL SELECT GRANULAR FILL/ SELECT STRUCTURAL FILL MATERIALS SHALL MEET NYSDOT REQUIREMENTS, 2008 STANDARD SPECIFICATIONS, SECTION 203-2.02 C, EXCEPT THAT 100% SHALL PASS THE 2" SIEVE. 100% IN EXCESS OF 1/2" SIEVE. 0%-70% PASSING #40 SIEVE. 0%-12% PASSING #200 SIEVE.
 - CRUSHED STONE SHALL NOT EXCEED No. 2 IN SIZE. ALL AGGREGATES SHALL MEET NYSDOT REQUIREMENTS, 2008 STANDARD SPECIFICATIONS, SECTION 703.

1 SIMPLEX PUMP PIT
 NOT TO SCALE

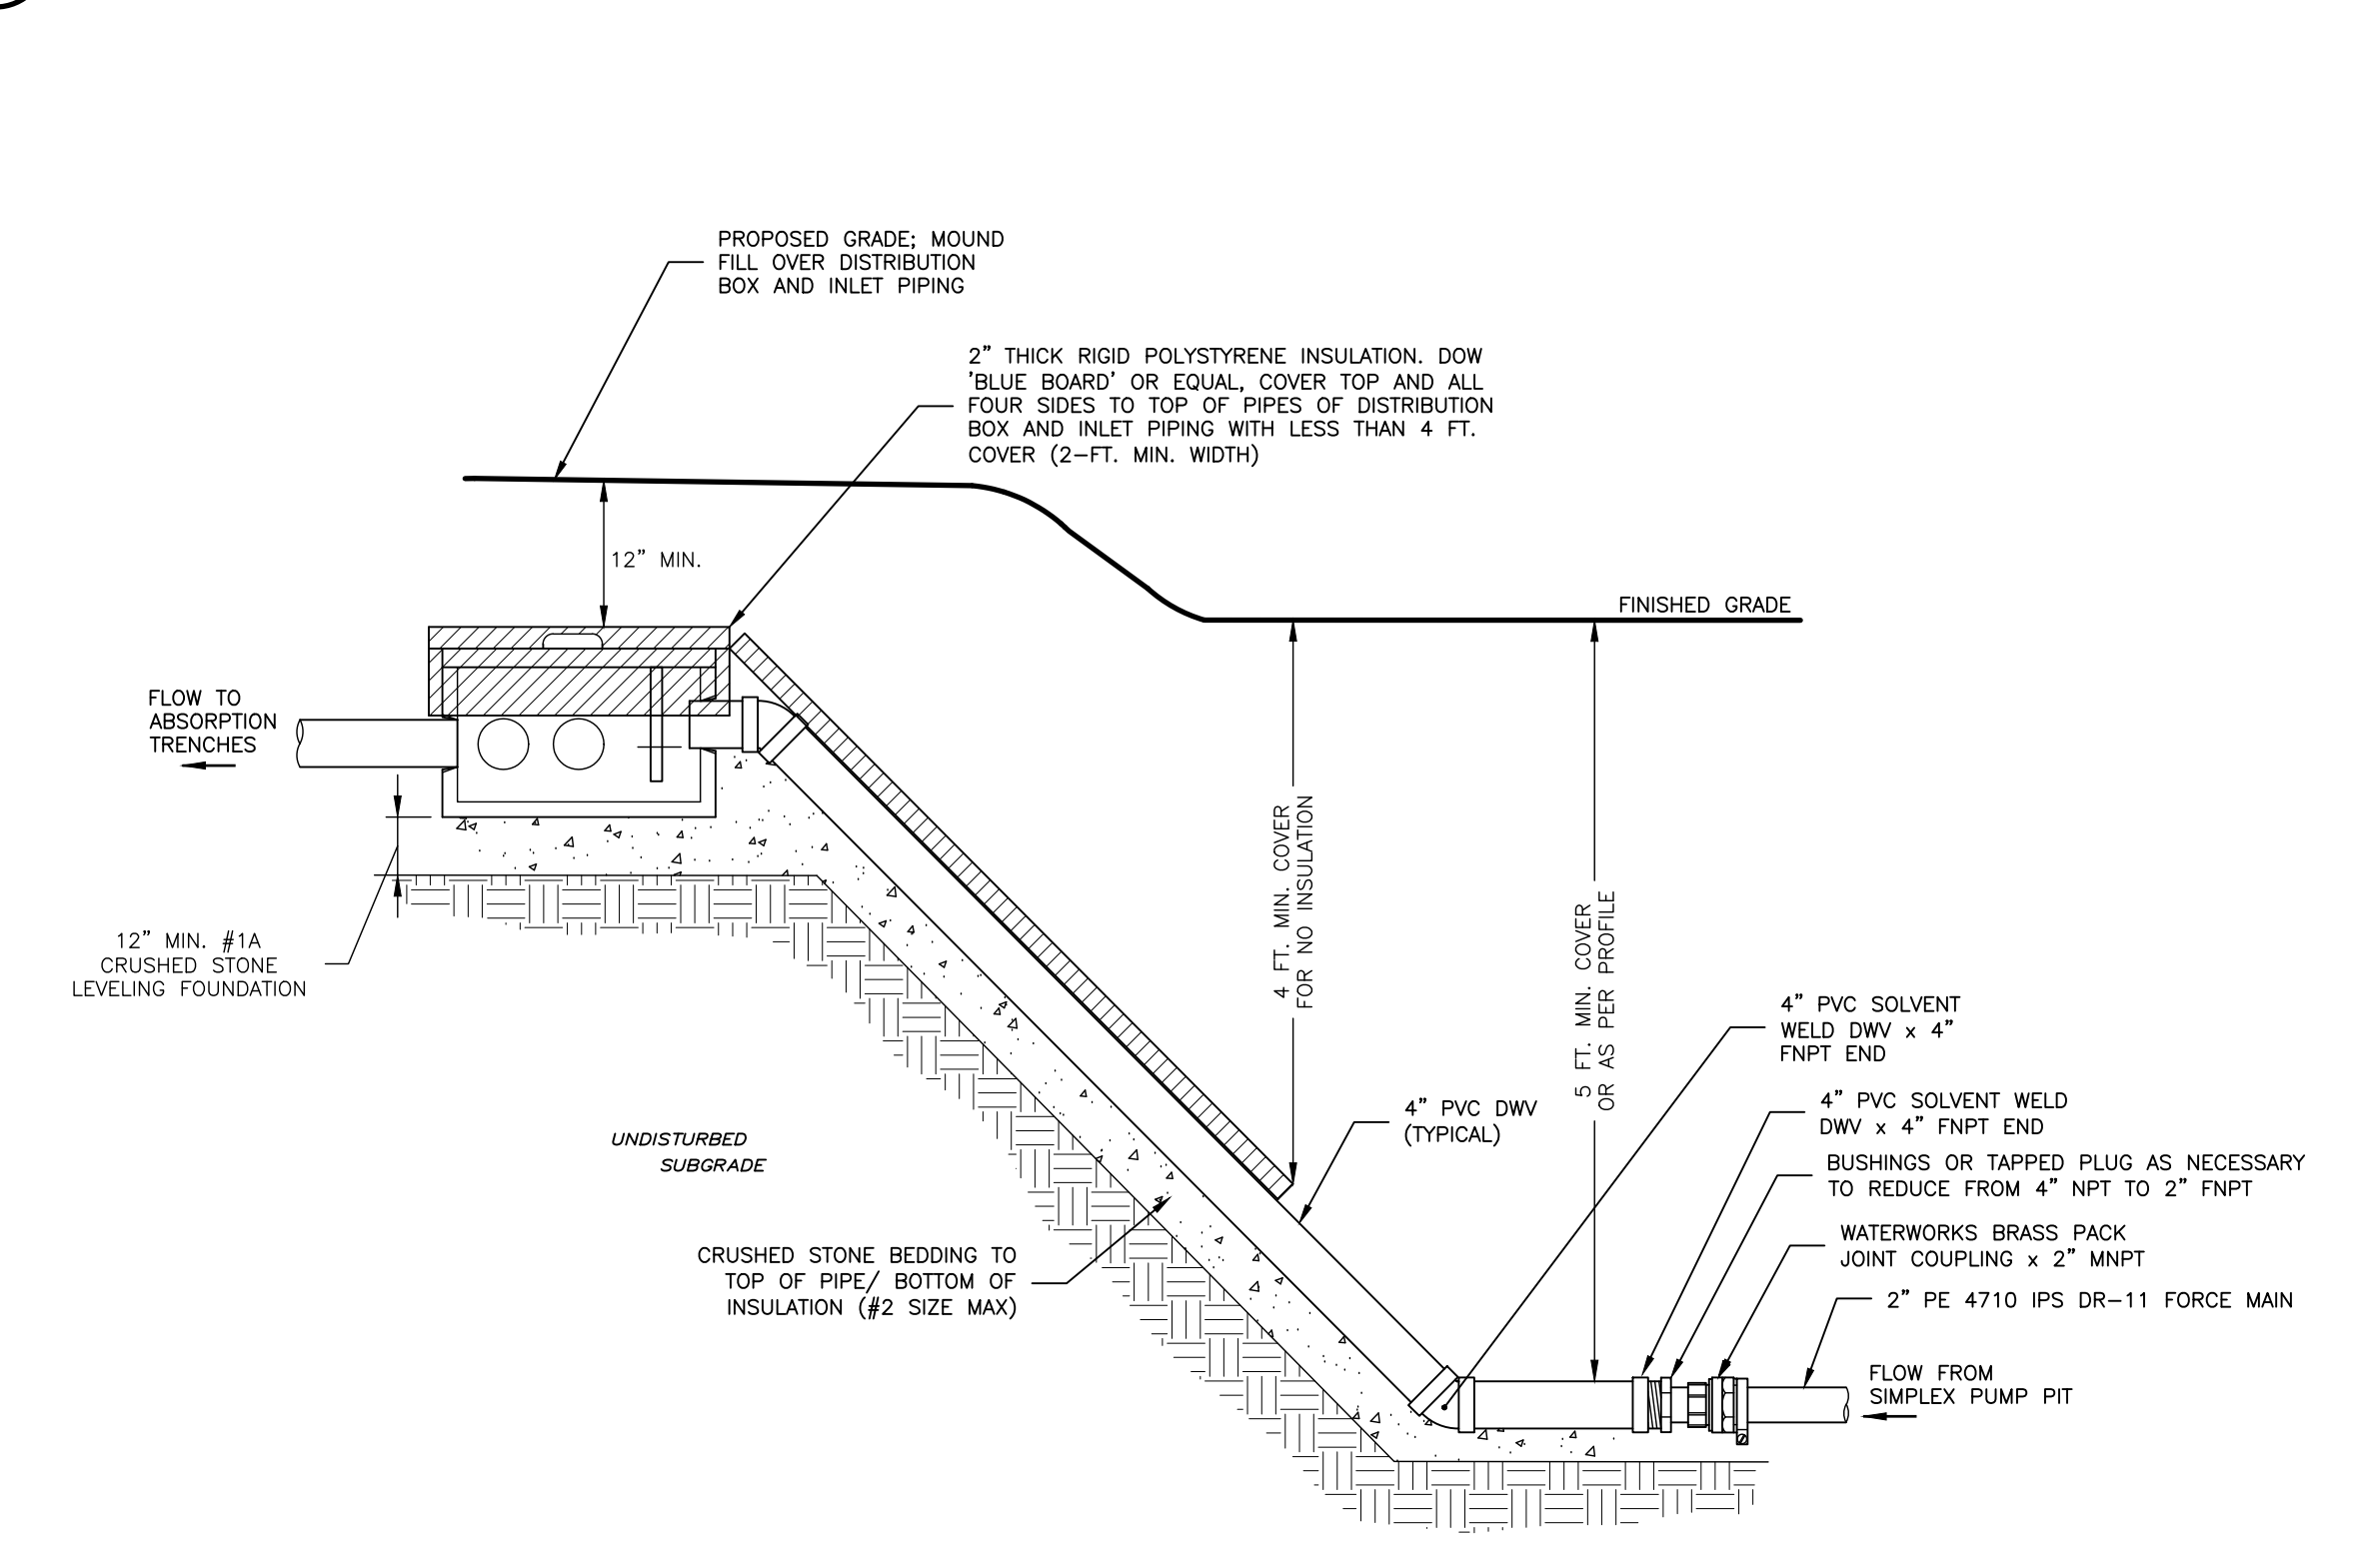

3 SIMPLEX CONTROL PANEL
 NOT TO SCALE



- NOTES:**
- NATIVE EXCAVATED GRANULAR MATERIAL MAY BE BACKFILLED IF APPROVED BY THE ENGINEER.
 - ALL STONE SHALL BE CRUSHED-TYPE, NOT EXCEED #2 SIZE AND CONFORM TO NYSDOT SPECIFICATIONS SEC. 703-02. COARSE AGGREGATE.
 - GRANULAR FILL SHALL CONFORM TO NYSDOT SPECIFICATIONS SEC. 703-01, FINE AGGREGATE, AND 733-11, EXCEPT WITH THE FOLLOWING GRADATION:
 100% PASSING 1-1/2" SIEVE
 0%-70% PASSING #40 SIEVE
 0%-12% PASSING #200 SIEVE
 - STONE MANHOLES SHALL BE SHOVEL-SLICED TO THE SPRING-LINE OF PIPE.
 - ALL STONE SHALL BE WRAPPED IN AREAS TO BE PAVED.

PUMP TANK ELEVATIONS

SEPTIC I.D.	INV IN (FT)	FLOOR (FT)	PUMP OFF (FT)	PUMP ON (FT)	ALARM (FT)	INV OUT (FT)
1A	845.3	841.3	842.3	842.6	843.1	843.8
2A	842.0	838.0	839.0	839.4	839.9	840.5
3A	823.0	819.0	820.0	820.3	820.8	821.5
6A	843.5	839.5	840.5	841.3	841.8	842.0
8A	810.0	811.0	812.0	812.6	813.1	813.5
9A	818.0	814.0	815.0	815.5	816.0	816.5
10A	814.8	810.8	811.8	812.4	812.9	813.3
11A	822.0	818.0	819.0	819.5	820.0	820.5
13A	833.0	829.0	830.0	830.5	831.0	831.5
14A	819.0	815.0	816.0	816.5	817.0	817.5
15A	815.0	811.0	812.0	812.7	813.2	813.5
16A	836.0	832.0	833.0	833.7	834.2	834.5
17A	849.0	845.0	846.0	846.7	847.2	847.5
18A	824.5	820.5	821.5	822.2	822.7	823.0
19A	780.0	776.0	777.0	777.5	778.0	778.5
3B	833.0	829.0	830.0	830.5	831.0	831.5
5B	823.5	819.5	820.5	820.8	821.3	822.0
7B	780.0	776.0	777.0	777.4	777.9	778.5

PUMP SPECIFICATIONS (GOULDS 3885)

SEPTIC I.D.	PUMP OFF ELEV	D-BOX ELEV	ELEVATION HEAD	FORCE MAIN LENGTH (FT)	PUMP RATE (GPM)	HEAD LOSS (FL+MISC)	TDH	PUMP SPEC
1A	842.3	848.0	5.7	20.0	50.0	1.7	7.4	WE03M
2A	839.0	845.0	6.0	20.0	50.0	1.7	7.7	WE03M
3A	820.0	826.0	6.0	15.0	50.0	1.8	7.8	WE03M
6A	840.5	846.5	6.0	437.0	38.0	15.0	21.0	WE05H
8A	812.0	824.0	12.0	197.0	35.0	6.4	18.4	WE03M
9A	815.0	820.0	5.0	129.0	50.0	4.6	9.6	WE03M
10A	811.7	833.0	21.3	360.0	35.0	10.9	32.2	WE05HH
11A	819.0	825.0	6.0	125.0	50.0	7.7	13.7	WE03M
13A	830.0	817.5	0.0	200.0	55.0	13.7	13.7	WE03M
14A	816.0	820.0	4.0	180.0	42.0	7.9	11.9	WE03M
15A	812.0	832.0	20.0	270.0	42.0	11.4	31.4	WE07H
16A	833.0	848.0	15.0	350.0	42.0	14.5	29.5	WE07H
17A	846.0	856.0	10.0	370.0	43.0	15.9	25.9	WE05H
18A	821.5	785.0	0.0	470.0	40.0	17.6	17.6	WE03M
19A	777.0	780.5	3.5	150.0	52.0	9.6	13.1	WE03M
3B	830.0	836.0	6.0	220.0	48.0	11.9	17.9	WE05H
5B	820.5	835.0	14.5	193.0	35.0	6.3	20.8	WE05H
7B	777.0	789.0	12.0	160.0	42.0	7.2	19.2	WE05H

- ELECTRICAL NOTES:**
- THE CONTRACTOR SHALL VERIFY LINE VOLTAGE AVAILABLE AT THE SITE PRIOR TO ORDERING OF ELECTRICAL EQUIPMENT.
 - IF INSTALLED OUTSIDE THE PUMP CONTROL PANEL SHALL BE A NEMA 4X ENCLOSURE, SIMPLEX TYPE AS MANUFACTURED BY S.E.-RHOMBUS OR APPROVED EQUAL AND INCLUDE THE FOLLOWING:
 - A THERMOSTATICALLY CONTROLLED HEATER TO PREVENT CONDENSATION.
 - VISUAL AND AUDIBLE ALARM FOR HIGH WATER LEVEL AND PUMP MALFUNCTION CONDITIONS WITH A TEST/NORMAL/ SILENCE SWITCH.
 - PUMP RUN INDICATOR LIGHT AND H-O-A SWITCH.
 - PUMP CLASPED RUN-TIME COUNTER.
 - KEYED LOCK OR KEYPAD FOR FOLLOWING.
 - THE CONTROL PANEL SHALL BE LOCATED IN A CONSPICUOUS LOCATION, 5'-FT MIN. FROM THE P.S. HATCH AND/OR VENT PIPE, AS SHOWN ON THE PLANS OR AS APPROVED BY THE OWNERS REPRESENTATIVE.
 - THERE SHALL BE NO ELECTRICAL SPICES, JUNCTION BOXES, OR CONNECTIONS OF ANY KIND IN THE PUMP CHAMBER (WELL).
 - LEVEL CONTROLS SHALL BE INTRINSICALLY SAFE.
 - ALL CONDUCTORS SHALL BE COPPER UNLESS OTHERWISE NOTED.
 - ALL ELECTRICAL WORK SHALL BE DONE IN FULL COMPLIANCE WITH THE CURRENT EDITION OF THE NATIONAL ELECTRICAL CODE (NEC) AND ALL STATE AND LOCAL CODES.
 - ALL ELECTRICAL MATERIALS SHALL BE U.L. LISTED.
 - ALL EQUIPMENT SHALL BE INSTALLED IN ACCORDANCE WITH THE MANUFACTURER'S WRITTEN INSTRUCTIONS.

DOSING CALCULATIONS


SEPTIC I.D.	TRENCH LENGTH (FT)	DISTRIBUTION PIPE VOLUME (CF)	FORCE MAIN LENGTH	FORCE MAIN VOLUME (CF)	DOSING VOLUME (CF)	PUMP TANK VOLUME PER FOOT (CF)	ON/OFF ELEVATION DIFFERENCE (IN)
1A	123	11	20	0.4	9		4.0
2A	159	14	20	0.4	12		5.0
3A	123	11	15	0	9		4.0
6A	180	16	437	9.5	22		9.0
8A	180	16	197	4	17		7.0
9A	180	16	129	3	15		6.0
10A	180	16	327	7	20	28	8.0
11A	180	15	125	3	15		6.0
13A	159	14	200	4	15		6.0
14A	159	14	180	4	15		6.0
15A	180	16	270	6	18		8.0
16A	180	16	350	8	20		9.0
17A	164	14	370	8	19		8.0
18A	147	44	470	10	45		19.0
19A	171	15	150	3	15		6.0
3B	147	13	220	5	15		6.0
5B	66	6	400	9	13		6.0
7B	123	11	160	4	12		5.0

- DOSING CALCULATION NOTES:**
- DISTRIBUTION PIPE VOLUME WAS CALCULATED USING A PIPE DIAMETER OF 4 INCHES
 - FORCE MAIN PIPE VOLUME WAS CALCULATED USING A PIPE DIAMETER OF 2 INCHES
 - DOSING VOLUME WAS CALCULATED BY ADDING 80% OF DISTRIBUTION PIPE VOLUME + 100% FORCE MAIN VOLUME.
 - PUMP TANK VOLUME BASED ON 6" DIAMETER CONCRETE TANK. TANK DIMENSIONS AND VOLUME SHOULD BE CONFIRMED BASED ON ACTUAL TANKS USED PRIOR TO PUMP STARTUP.

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FOR PROJECT NUMBER:	148201
<small>IN THE PRESENCE OF THESE DOCUMENTS IN ANY FORM OR MANNER, THE USER HEREBY AGREES TO HOLD THE DESIGNER, ENGINEER, ARCHITECT, PLANNING AND LANDSCAPE ARCHITECT, AND ALL OTHER PROFESSIONALS AND PERSONS RESPONSIBLE FOR THE DESIGN AND CONSTRUCTION OF THE PROJECT HARMLESS FROM AND AGAINST ALL AND ANY SUCH CLAIMS, DAMAGES, LOSSES AND EXPENSES, INCLUDING REASONABLE ATTORNEY'S FEES, THAT MAY BE ASSERTED AGAINST OR INCURRED BY ANY SUCH PERSONS.</small>	
REVISION:	DATE
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SUBMITTAL TO APA	7/21/22 TAM
SUBMITTAL TO APA AND DOH	9/16/22 TAM

SCALE:	1" = 120'
NOT FOR CONSTRUCTION	
SHEET TITLE:	LIGHTING PLAN
SHEET:	19 of 19

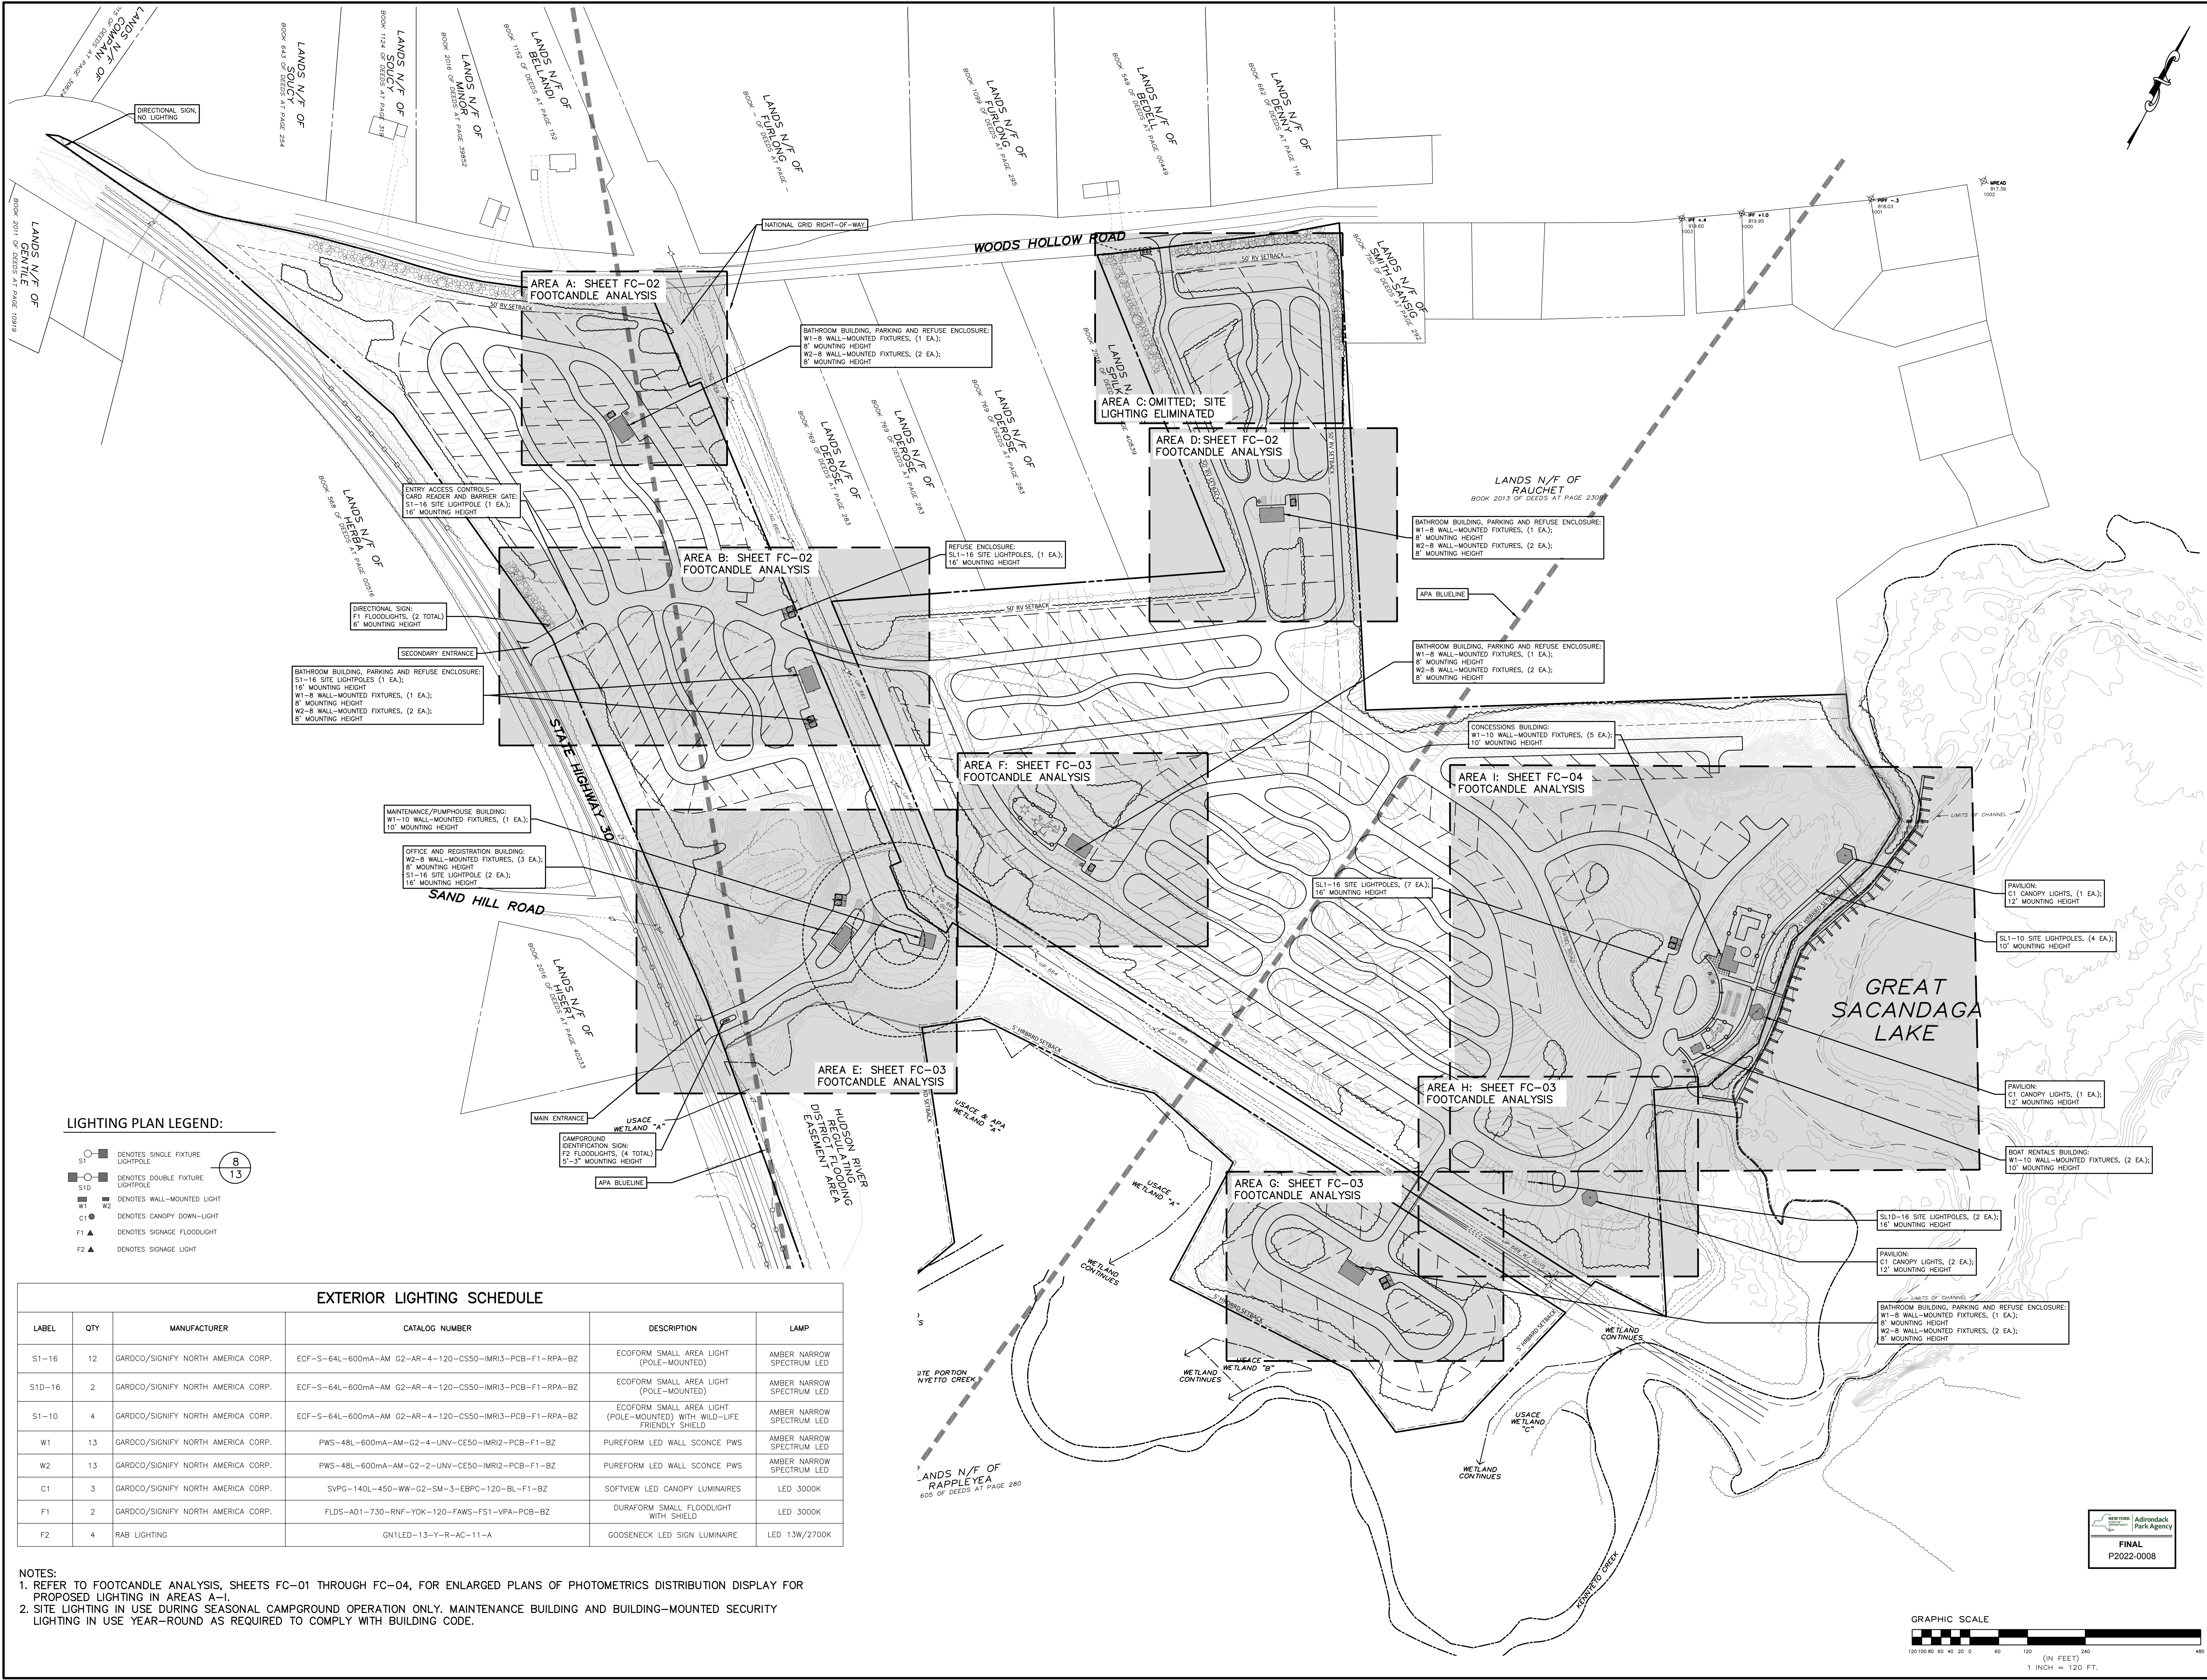

LIGHTING PLAN LEGEND:

- DENOTES SINGLE FIXTURE LIGHTPOLE
- DENOTES DOUBLE FIXTURE LIGHTPOLE
- DENOTES WALL-MOUNTED LIGHT
- DENOTES CANOPY DOWN-LIGHT
- DENOTES SIGNAGE FLOODLIGHT
- DENOTES SIGNAGE LIGHT

8
 13

EXTERIOR LIGHTING SCHEDULE

LABEL	QTY	MANUFACTURER	CATALOG NUMBER	DESCRIPTION	LAMP
S1-16	12	GARDCO/SIGNIFY NORTH AMERICA CORP.	ECF-S-64L-600mA-AM G2-AR-4-120-CS50-IMR3-PCB-F1-RPA-BZ	ECOFORM SMALL AREA LIGHT (POLE-MOUNTED)	AMBER NARROW SPECTRUM LED
S1D-16	2	GARDCO/SIGNIFY NORTH AMERICA CORP.	ECF-S-64L-600mA-AM G2-AR-4-120-CS50-IMR3-PCB-F1-RPA-BZ	ECOFORM SMALL AREA LIGHT (POLE-MOUNTED)	AMBER NARROW SPECTRUM LED
S1-10	4	GARDCO/SIGNIFY NORTH AMERICA CORP.	ECF-S-64L-600mA-AM G2-AR-4-120-CS50-IMR3-PCB-F1-RPA-BZ	ECOFORM SMALL AREA LIGHT (POLE-MOUNTED) WITH WILD-LIFE FRIENDLY SHIELD	AMBER NARROW SPECTRUM LED
W1	13	GARDCO/SIGNIFY NORTH AMERICA CORP.	PWS-48L-600mA-AM-G2-4-UNV-CE50-IMR2-PCB-F1-BZ	PUREFORM LED WALL SCONCE PWS	AMBER NARROW SPECTRUM LED
W2	13	GARDCO/SIGNIFY NORTH AMERICA CORP.	PWS-48L-600mA-AM-G2-2-UNV-CE50-IMR2-PCB-F1-BZ	PUREFORM LED WALL SCONCE PWS	AMBER NARROW SPECTRUM LED
C1	3	GARDCO/SIGNIFY NORTH AMERICA CORP.	SVPG-140L-450-WW-G2-SM-3-EBPC-120-BL-F1-BZ	SOFTVIEW LED CANOPY LUMINAIRES	LED 3000K
F1	2	GARDCO/SIGNIFY NORTH AMERICA CORP.	FLDS-A01-730-RNF-YOK-120-FAWS-FS1-VPA-PCB-BZ	DURAFORM SMALL FLOODLIGHT WITH SHIELD	LED 3000K
F2	4	RAB LIGHTING	GN1LED-13-Y-R-AC-11-A	GOOSENECK LED SIGN LUMINAIRE	LED 13W/2700K

NOTES:
 1. REFER TO FOOTCANDLE ANALYSIS, SHEETS FC-01 THROUGH FC-04, FOR ENLARGED PLANS OF PHOTOMETRICS DISTRIBUTION DISPLAY FOR PROPOSED LIGHTING IN AREAS A-I.
 2. SITE LIGHTING IN USE DURING SEASONAL CAMPGROUND OPERATION ONLY. MAINTENANCE BUILDING AND BUILDING-MOUNTED SECURITY LIGHTING IN USE YEAR-ROUND AS REQUIRED TO COMPLY WITH BUILDING CODE.

